

E ELECTRIC HANDHOLE

ELECTRIC MANHOLE

ELECTRIC MARKER FLAG

ELECTRIC MARKER SIGN

ELECTRIC TRANSFORMER

LIGHT STANDARD

ELECTRIC METER

UTILITY POLE

ાં મANDICAPPED PARKING

MARQUEE/BILLBOARD

P.O.C. POINT OF COMMENCING

E ELECTRIC VAULT

── SIGN

WATER VALVE

W WATER WELL

PKS PK NAIL SET

PKF PK NAIL FOUND

IRF IRON ROD FOUND

IPF IRON PIPE FOUND

ADF ALUMINUM DISK FOUND

P.O.B. POINT OF BEGINNING

XS "X" CUT IN CONCRETE SET

XF "X" CUT IN CONCRETE FOUND

AIR RELEASE VALVE

CIRS 5/8" CAPPED IRON ROD SET

IRFC IRON ROD WITH CAP FOUND

MERLE W. MILLER DATE: 12-10-2021

PLEASE NOTE THAT THE USE OF THE WORD "CERTIFY" OR "CERTIFICATE" USED HEREON CONSTITUTES

AN EXPRESSION OF PROFESSIONAL OPINION REGARDING THOSE FACTS OF FINDINGS WHICH ARE THE

SUBJECT OF THE CERTIFICATION, AND DOES NOT CONSTITUTE A WARRANTY OF GUARANTEE, EITHER

REGISTERED PROFESSIONAL

LAND SURVEYOR NO. 5438

EXPRESSED OR IMPLIED.

STATE OF TEXAS

* METES & BOUNDS DESCRIPTION *

BEING A 7.869 ACRE TRACT OF LAND LOCATED IN THE SAMUEL MITCHELL SURVEY, ABSTRACT NO. 593, CITY OF MANSFIELD, JOHNSON COUNTY, TEXAS, BEING ALL OF A CALLED 7.875 ACRE TRACT OF LAND AS DESCRIBED IN THE SPECIAL WARRANTY DEED TO L.R. RAY, TRUSTEE OF THE L.R. RAY AND TOMMIE A. RAY TRUST DATED JANUARY 18,1994, FILED FOR RECORD IN COUNTY CLERK'S INSTRUMENT NO. 2013-07246, OFFICIAL PUBLIC RECORDS, JOHNSON COUNTY, TEXAS (OPRJCT), SAID 7.869 ACRE TRACT OF LAND BEING MORE PARTICULARLY DESCRIBED BY METES AND BOUNDS AS FOLLOWS:

COMMENCING AT A 1/2 INCH IRON ROD FOUND IN CONCRETE FOR THE SOUTHERNMOST CORNER OF MITCHELL FARMS, AN ADDITION TO THE CITY OF MANSFIELD, JOHNSON COUNTY, TEXAS, ACCORDING TO THE PLAT RECORDED IN COUNTY CLERK'S INSTRUMENT NO. 2021-147, OPRJCT, SAID COMMENCING POINT HAVING A NAD83 TEXAS COORDINATE SYSTEM POSITION (GRID) OF N:6884881.4 E: 2398843.8 (BEARINGS & COORDINATE VALUES SHOWN HEREON ARE IN REFERENCE TO THE NAD83 — TEXAS COORDINATE SYSTEM -NORTH CENTRAL ZONE, 4202, BASED ON GPS OBSERVATIONS UTILIZING THE LEICA GPS REFERENCE NETWORK);

THENCE NORTH 59 DEGREES 39 MINUTES 19 SECONDS EAST, ALONG THE SOUTHEAST LINE OF SAID MITCHELL FARMS, A DISTANCE OF 748.99 FEET, TO A 1/2 INCH IRON ROD FOUND FOR THE WESTERNMOST CORNER OF SAID CALLED 7.875 ACRE TRACT OF LAND, AND BEING THE POINT OF BEGINNING, SAID BEGINNING POINT HAVING A NAD83 TEXAS COORDINATE SYSTEM POSITION (GRID) OF N: 6885259.8

THENCE NORTH 59 DEGREES 41 MINUTES 50 SECONDS EAST, ALONG A NORTHWEST LINE OF SAID CALLED 7.875 ACRE TRACT OF LAND, A DISTANCE OF 299.57 FEET, TO A 1/2 IRON ROD FOUND FOR THE NORTHERNMOST CORNER OF SAID CALLED 7.875 ACRE TRACT OF LAND, SAME BEING THE WESTERNMOST CORNER OF LOT 1, BLOCK 1, THE RANCH, AN ADDITION TO THE CITY OF MANSFIELD, JOHNSON COUNTY, TEXAS, ACCORDING TO THE PLAT RECORDED IN VOLUME 8, PAGE 208, PLAT RECORDS, JOHNSON COUNTY, TEXAS (PRJCT); THENCE SOUTH 30 DEGREES 29 MINUTES 09 SECONDS EAST, ALONG THE COMMON LINE OF SAID CALLED 7.875 ACRE TRACT OF LAND AND SAID LOT 1, BLOCK 1, THE RANCH, AT A DISTANCE OF 168.38 FEET, PASSING A 1/2 INCH IRON ROD FOUND FOR THE SOUTHERNMOST CORNER OF SAID LOT 1, BLOCK 1, THE RANCH, SAME BEING THE WESTERNMOST CORNER OF LOT 2, BLOCK 1, OF SAID THE RANCH, AND CONTINUING IN ALL A TOTAL DISTANCE OF 336.95 FEET, TO A 1/2 INCH IRON ROD FOUND, BEING THE SOUTHERNMOST CORNER OF SAID LOT 2, BLOCK 1, THE RANCH,

THENCE NORTH 59 DEGREES 38 MINUTES 26 SECONDS EAST, ALONG THE COMMON LINE OF SAID CALLED 7.875 ACRE TRACT OF LAND, AND SAID LOT 2, BLOCK 1, THE RANCH, AT A DISTANCE OF 382.27 FEET, PASSING A 1/2 IRON ROD FOUND FOR THE EASTERNMOST CORNER OF SAID LOT 2. BLOCK 1. THE RANCH. AND CONTINUING IN ALL A TOTAL DISTANCE OF 387.40 FEET, TO A 5/8 INCH CAPPED IRON ROD SET STAMPED "PERC ENGINEERING", BEING ON THE SOUTHWEST RIGHT—OF—WAY LINE OF SOUTH MITCHELL ROAD, A VARIABLE WIDTH PUBLIC RIGHT-OF-WAY:

THENCE SOUTH 30 DEGREES 21 MINUTES 32 SECONDS EAST, ALONG THE SAID SOUTHWEST RIGHT-OF-WAY LINE, A DISTANCE OF 337.89 FEET. TO A 1-INCH STEEL ROD IN CONCRETE FOUND FOR THE EASTERNMOST CORNER OF SAID CALLED 7.875 ACRE TRACT OF LAND, FROM WHICH A MAG NAIL FOUND FOR THE SOUTHERNMOST SOUTHWEST CORNER OF A TRACT OF LAND AS DESCRIBED IN COUNTY CLERK'S INSTRUMENT NO. 2019-33887 BEARS, SOUTH 33 DEGREES 16 MINUTES 09 SECONDS EAST, A DISTANCE OF 666.16 FEET, SAID MAG NAIL HAVING A NAD83 TEXAS COORDINATE SYSTEM POSITION (GRID) OF N: 6884467.9 E: 2400790.2;

THENCE SOUTH 59 DEGREES 38 MINUTES 40 SECONDS WEST, DEPARTING SAID SOUTHWEST RIGHT-OF-WAY LINE, ALONG THE SOUTHEAST LINE OF THE HEREIN DESCRIBED TRACT OF LAND, BEING COMMON WITH THE NORTHWEST LINE OF LOT 1, BLOCK 1, SINGH ADDITION, AN ADDITION TO THE CITY OF MANSFIELD, JOHNSON COUNTY, TEXAS, ACCORDING TO THE PLAT RECORDED IN COUNTY CLERK'S INSTRUMENT NO. 2020-178, PRJCT, A DISTANCE OF 715.37 FEET, TO A 1/2 INCH IRON ROD FOUND, FROM WHICH A 1/2 INCH CAPPED IRON ROD FOUND STAMPED "PRISM SURVEY" FOR THE WESTERNMOST CORNER OF SAID LOT 1, BLOCK 1, SINGH ADDITION, BEARS SOUTH 59 DEGREES 40 MINUTES 07 SECONDS WEST, A DISTANCE OF 284.59 FEET;

THENCE NORTH 28 DEGREES 00 MINUTES 47 SECONDS WEST, ALONG THE SOUTHWEST LINE OF SAID CALLED 7.875 ACRE TRACT OF LAND, BEING COMMON WITH THE NORTHEAST LINE OF LOT E, BLOCK 1, A. MOORE U.S. 287 SOUTH ADDITION, AN ADDITION TO THE CITY OF MANSFIELD, JOHNSON COUNTY, TEXAS, ACCORDING TO THE PLAT RECORDED IN VOLUME 388-161, PAGE 2, PRJCT, A DISTANCE OF 675.65 FEET, TO THE POINT OF BEGINNING AND CONTAINING 7.869 ACRES (342,797 SQUARE FEET) OF LAND, MORE OR LESS.

* ATTENTION TO SCHEDULE B ITEMS *

10. THE FOLLOWING MATTERS AND ALL TERMS OF THE DOCUMENTS CREATING OR OFFERING EVIDENCE OF THE MATTERS (WE MUST INSERT MATTERS OR DELETE THIS EXCEPTION):

a. ALL LEASES, GRANTS, EXCEPTIONS OR RESERVATIONS OF COAL, LIGNITE, OIL, GAS AND OTHER MINERALS, TOGETHER WITH ALL RIGHTS, PRÍVILEGES, AND IMMUNITIES RELATING THERETO, APPEARING IN THE PUBLIC RECORDS WHETHER LISTED IN SCHEDULE B OR NOT. THERE MAY BE LEASES, GRANTS, EXCEPTIONS OR RESERVATIONS OF MINERAL INTEREST THAT ARE NOT LISTED.

NOT ADDRESSED BY SURVEYOR

b. ALL ENCUMBRANCES. VIOLATIONS. VARIATIONS. OR ADVERSE CIRCUMSTANCES AFFECTING TITLE THAT WOULD BE DISCLOSED BY AN ACCURATE AND COMPLETE LAND SURVEY OF THE LAND, INCLUDING, WITHOUT LIMITATION, ALL VISIBLE AND APPARENT EASEMENTS OR USES AND ALL UNDERGROUND EASEMENTS OR USES, THE EXISTENCE OF WHICH MAY ARISE BY UNRECORDED GRANT OR BY USE. (MAY BE AMENDED OR DELETED UPON APPROVAL OF SURVEY.)

NOT ADDRESSED BY SURVEYOR

c. RIGHTS, IF ANY, OF THIRD PARTIES WITH RESPECT TO ANY PORTION OF THE SUBJECT PROPERTY LYING WITHIN THE BOUNDARIES OF A PUBLIC OR PRIVATE ROAD. (MAY BE AMENDED OR DELETED UPON APPROVAL OF SURVEY.)

NOT ADDRESSED BY SURVEYOR

d. RIGHTS OF PARTIES IN POSSESSION AND RIGHTS OF TENANTS UNDER ANY UNRECORDED LEASES OR RENTAL AGREEMENTS. (MAY BE AMENDED OR DELETED UPON EXECUTION OF SATISFACTORY AFFIDAVIT WITH RESPECT TO PARTIES IN POSSESSION AND

NOT ADDRESSED BY SURVEYOR

e. UNDIVIDED ROYALTY INTEREST IN COAL, LIGNITE, OIL, GAS AND OTHER MINERALS, AND ALL RIGHTS INCIDENT THERETO, DESCRIBED IN INSTRUMENT FILED 02/28/1956, RECORDED IN VOLUME 407, PAGE 16, REAL PROPERTY RECORDS, JOHNSON COUNTY, TEXAS COMPANY MAKES NO REPRESENTATION AS TO THE PRESENT OWNERSHIP OF ANY SUCH INTERESTS

MAY AFFECT THE SUBJECT PROPERTY. HOWEVER, THE SURVEYOR RECOMMENDS AN ATTORNEY'S OPINION ON THE LANGUAGE CONTAINED THEREIN

f. UNDIVIDED ROYALTY INTEREST IN COAL, LIGNITE, OIL, GAS AND OTHER MINERALS, AND ALL RIGHTS INCIDENT THERETO, DESCRIBED IN INSTRUMENT FILED 10/26/1981, RECORDED IN VOLUME 881, PAGE 354, REAL PROPERTY RECORDS, JOHNSON COUNTY, TEXAS. COMPANY MAKES NO REPRESENTATION AS TO THE PRESENT OWNERSHIP OF ANY SUCH INTERESTS

DOES APPEAR TO AFFECT THE SUBJECT PROPERTY

g. MINERAL LEASE TOGETHER WITH ALL RIGHTS, PRIVILEGES AND IMMUNITIES INCIDENT THERETO, TO CARTER—GIFFORD OIL COMPANY FROM ARTHUR LEE MOORE AND WANDALEA MOORE DESCRIBED IN INSTRUMENT FILED 09/12/1961, RECORDED IN VOLUME 11, PAGE 390, REAL PROPERTY RECORDS, JOHNSON COUNTY, TEXAS. COMPANY MAKES NO RÉPRESÉNTATION AS TO THE PRESENT OWNERSHIP OF ANY SUCH INTERESTS.

DOES APPEAR TO AFFECT THE SUBJECT PROPERTY

n. MINERAL LEASE TOGETHER WITH ALL RIGHTS, PRIVILEGES AND IMMUNITIES INCIDENT THERETO, TO DAVID H. ARRINGTON OIL & GAS. INC. FROM LEE ROY RAY DESCRIBED IN INSTRUMENT FILED 09/07/2005, RECORDED IN VOLUME 3618, PAGE 35, REAL PRÓPERTY RECORDS, JOHNSON COUNTY, TEXAS. COMPANY MAKES NÓ REPRESENTATION AS TO THE PRESENT OWNERSHIP OF

DOES APPEAR TO AFFECT THE SUBJECT PROPERTY. HOWEVER, THE TERM OF 2 YEARS NEEDS TO BE EVALUATED BY AN ATTORNEY.

i. FIFTEEN FOOT UTILITY EASEMENT OVER AND ACROSS NORTHWESTERLY SIDE OF PROPERTY AS SET OUT IN WARRANTY DEED, FILED 10/26/1981, RECORDED IN VOLUME 881, PAGE 354, REAL PROPERTY RECORDS, JOHNSON COUNTY, TEXAS.

DOES AFFECT THE SUBJECT PROPERTY AS SHOWN HEREON

j. EASEMENT GRANTED BY LEE ROY RAY TO PEREGRINE PIPELINE COMPANY, LP, FILED 06/19/2007, RECORDED IN VOLUME 4121, PAGE 202, REAL PROPERTY RECORDS, JOHNSON COUNTY, TEXAS.

DOES AFFECT THE SUBJECT PROPERTY AS SHOWN HEREON

ZC#23-006 **EXHIBIT A**

CATEGORY 1A, CONDITION II LAND TITLE SURVEY 7.869 ACRES OF LAND

LOCATED IN THE SAMUEL MITCHELL SURVEY, ABSTRACT NO. 593 CITY OF MANSFIELD, JOHNSON COUNTY, TEXAS



4055 INTERNATIONAL PLAZA, STE 430 FORT WORTH, TX 76109 MAIN: 817.380.5110 tbpels #10194323 www.PERC-eng.com


2. THIS SURVEY WAS PREPARED WITH THE BENEFIT OF THE COMMITMENT FOR TITLE INSURANCE ISSUED BY FIRST AMERICAN TITLE GUARANTY COMPANY, GF NO. 2017-351240-RU, EFFECTIVE DATE: OCTOBER 18, 2021, ISSUED: NOVEMBER 01, 2021. THE EASEMENTS, RIGHTS-OF-WAY OR OTHER EXCEPTIONS NOTED HEREON ARE ACCORDING TO SCHEDULE "B" THEREIN. THIS SURVEYOR HAS NOT ABSTRACTED THE PROPERTY.

3. THIS LAND TITLE SURVEY IS OF A TRACT OF LAND AS DESCRIBED IN COUNTY CLERK'S INSTRUMENT #2013-07246, DEED RECORDS, JOHNSON COUNTY, TEXAS.

4. THE SUBJECT PROPERTY IS LOCATED IN ZONE "X", AREAS OF 0.2% ANNUAL CHANCE FLOOD; AREAS OF 1% ANNUAL CHANCE FLOOD WITH

AVERAGE DEPTHS OF LESS THAN 1 FOOT OR WITH DRAINAGE AREAS LESS THAN 1 SQUARE MILE: AND AREAS PROTECTED BY LEVEES FROM 1% ANNUAL CHANCE FLOOD; AREAS DETERMINED TO BE OUTSIDE THE 0.2% ANNUAL CHANCE FLOODPLAIN, ACCORDING TO THE FLOOD INSURANCE RATE MAP (FIRM), MAP NUMBER 48251C0125J, MAP REVISED DECEMBER 4, 2012. THE SURVEYOR HAS NOT PERFORMED A STUDY OF THE LIMITS OF THE FLOODPLAIN AND THIS DESIGNATION IS BASED SOLELY ON OVERLAYING THE FLOOD MAP ONTO THE SUBJECT TRACT. SUBSURFACE AND ENVIRONMENTAL CONDITIONS WERE NOT EXAMINED OR CONSIDERED AS PART OF THIS SURVEY. NO STATEMENT IS MADE CONCERNING THE EXISTENCE OF UNDERGROUND OR OVERHEAD CONTAINERS OR FACILITIES THAT MAY AFFECT THE USE OR DEVELOPMENT OF

THE SUBJECT PROPERTY.

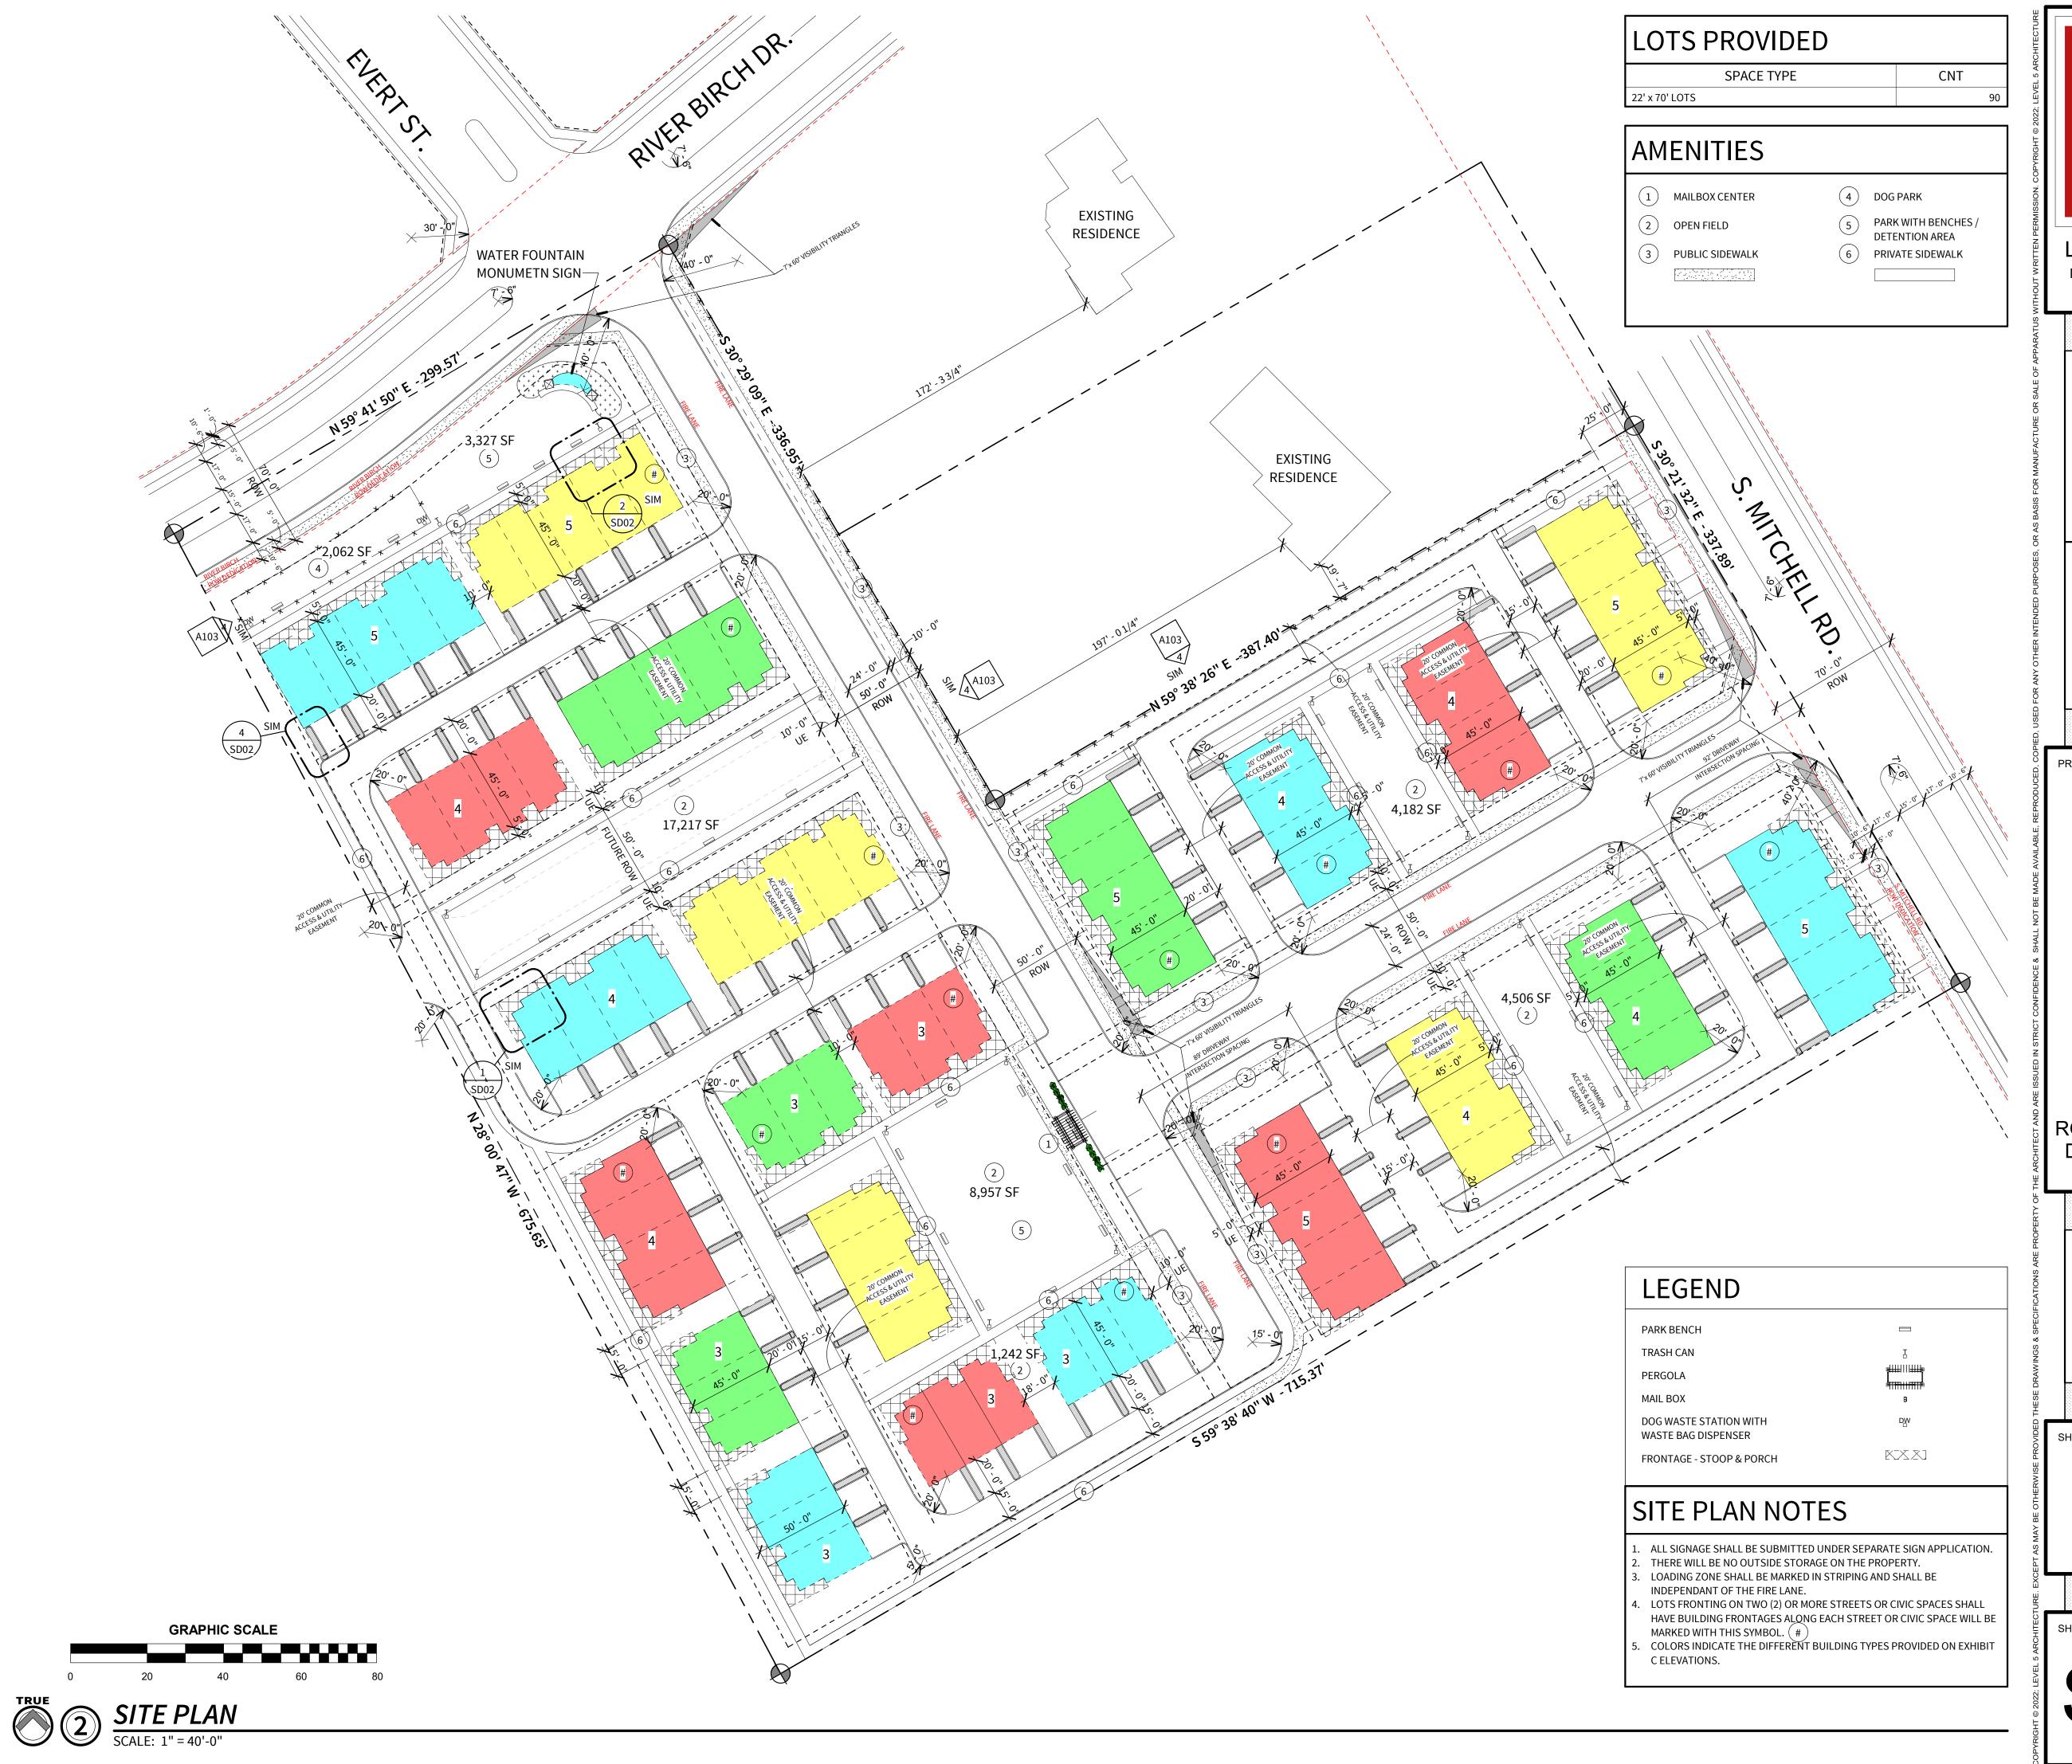

LEVEL 5

Level 5 Architecture

Mansfield, TX | Springdale, AR
level5architecture.com

THESE DOCUMENTS ARE FOR REVIEW ONLY AND ARE NOT INTENDED FOR CONSTRUCTION PURPOSES

ARCHITECT: JUSTIN S. GILMORE LEVEL 5 ARCHITECTURE

PROJECT INFORMATION:

SOUTH MITCHELL DEVELOPMENT

TOWNHOMES

SOUTH MITCHELL ROAD & RIVER BIRCH DRIVE, MANSFIELD, TX 76063

PROJECT NUMBER: 21-96T
ISSUE DATE: MM/DD/YYYY

REVISIONS:


ZC#23-006

SHEET NAME:


EXHIBIT B

SHEET NUMBER:

SD01

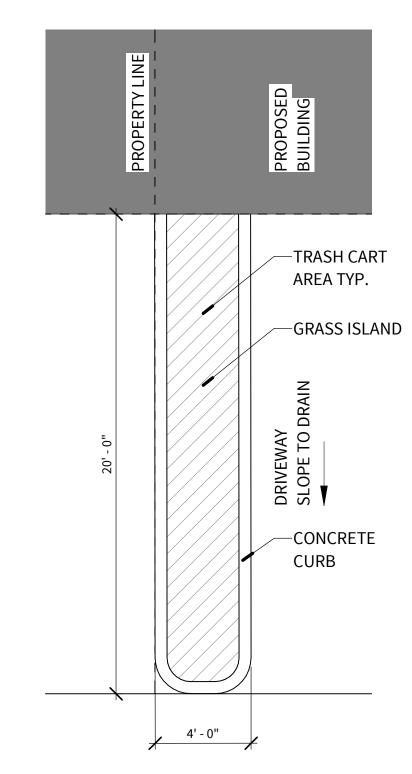


ENLARGED SITE PLAN SCALE: 1/4" = 1'-0"

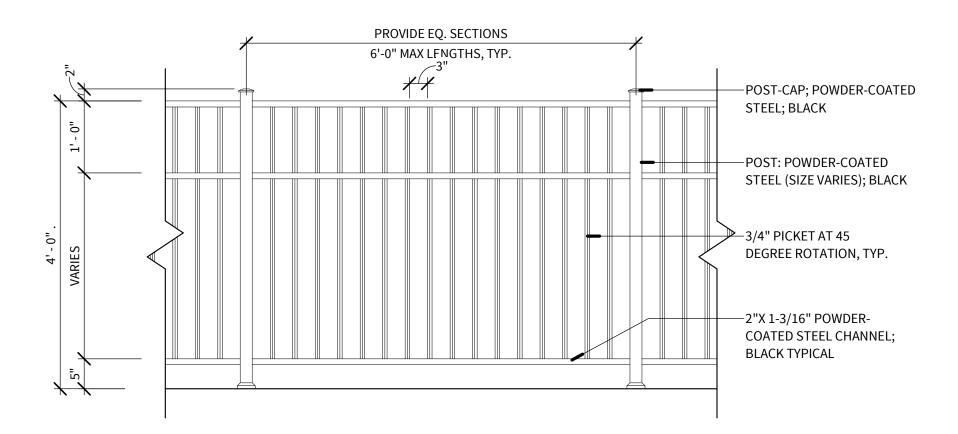


WROUGHT IRON RAILING ELEVATION

SCALE: 3/4" = 1'-0"

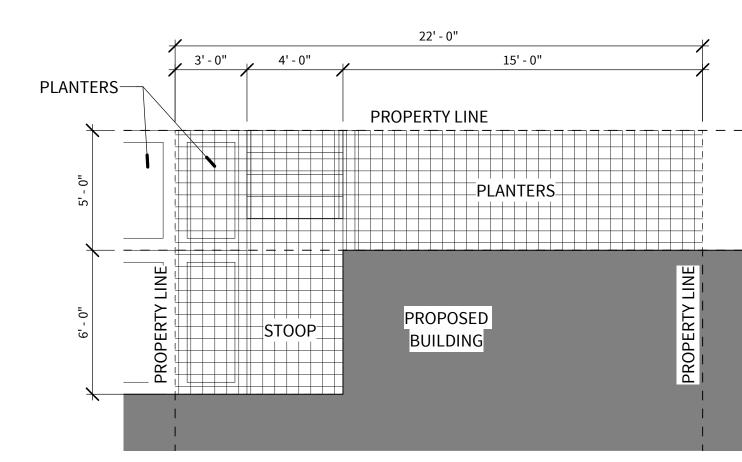

TYPICAL STOOP

ENLARGED SITE PLAN SCALE: 1/4" = 1'-0"

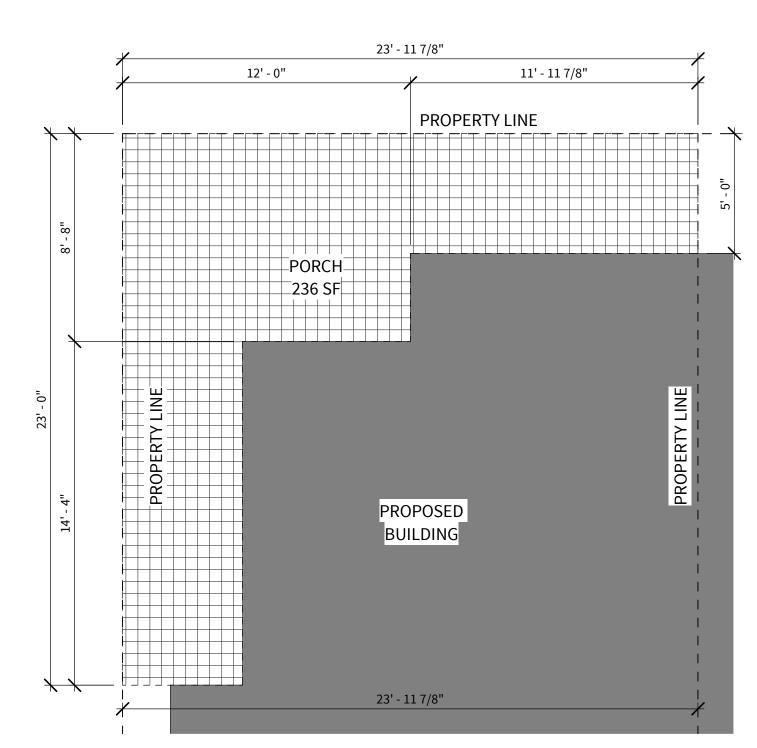

TYPICAL CORNER PORCH

ENLARGED SITE PLAN

SCALE: 1/4" = 1'-0"



Level 5 Architecture

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THESE DOCUMENTS ARE FOR REVIEW ONLY AND ARE NOT INTENDED FOR CONSTRUCTION PURPOSES ARCHITECT: JUSTIN S. GILMORE

LEVEL 5 ARCHITECTURE

SOUTH MITCHELL DEVELOPMENT

TOWNHOMES

SOUTH MITCHELL ROAD & RIVER BIRCH DRIVE, MANSFIELD, TX 76063

PROJECT NUMBER: 21-96T
ISSUE DATE: MM/DD/YYYY
REVISIONS:

ZC#23-006

SHEET NAME:

EXHIBIT B

SHEET NUMBER:

New Elevations, Submitted after 11.6.23
Planning and Zoning Commission Hearing







Level 5 Architecture

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ARCHITECT: JUSTIN S. GILMORE LEVEL 5 ARCHITECTURE

PROJECT INFORMATION:

SOUTH MITCHELL DEVELOPMENT

TOWNHOMES

SOUTH MITCHELL ROAD & RIVER BIRCH DRIVE, MANSFIELD, TX 76063

PROJECT NUMBER: YY-##
SSUE DATE: MM/DD/YYYY

ISSUE DATE: REVISIONS:

SHEET NAME:

EXTERIOR ELEVATIONS

SHEET NUMBER:

A401

New Elevations, Submitted after 11.6.23
Planning and Zoning Commission Hearing





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ARCHITECT: JUSTIN S. GILMORE LEVEL 5 ARCHITECTURE

PROJECT INFORMATION:

SOUTH MITCHELL DEVELOPMENT

TOWNHOMES

SOUTH MITCHELL ROAD & RIVER BIRCH DRIVE, MANSFIELD, TX 76063

PROJECT NUMBER: YY-##
SSUE DATE: MM/DD/YYYY

ISSUE DATE: REVISIONS:

SHEET NAME:

EXTERIOR ELEVATIONS

SHEET NUMBER:


A402

Elevations Presented at 11.6.23 Planning and Zoning Commission Hearing

SHINGLE ROOF SIDING BRICK FINISH BRICK FINISH

WEST ELEVATION

SCALE: 1/8" = 1'-0"

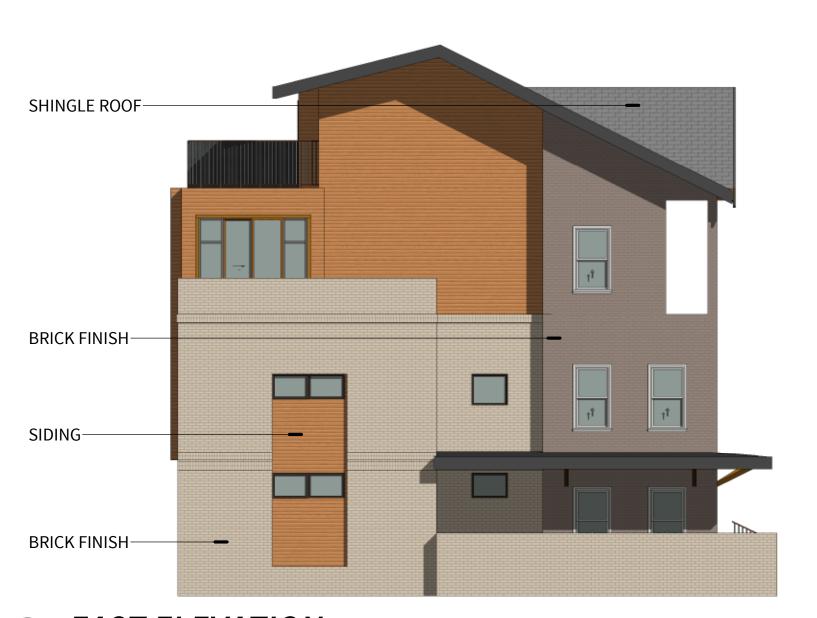

SCALE: 1/8" = 1'-0"

MATERIAL CALCULATION

NORTH ELEVATION
GLASS = 14%
SIDING = 9%
MASONRY = 49%
ROFF = 21%
STUCCO=7%
EAST ELEVATION
GLASS = 20%
SIDING = 26%

MASONRY = 12%

ROOF = 12%

SOUTH ELEVATION
GLASS = 8%
SIDING = 56%
MASONRY = 26%
ROOF = 10%

WEST ELEVATION
GLASS = 20%
SIDING = 56%
MASONRY = 12%
ROOF = 12%



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ARCHITECT: JUSTIN S. GILMORE LEVEL 5 ARCHITECTURE

PROJECT INFORMATION:

SOUTH MITCHELL DEVELOPMENT

TOWNHOMES

SOUTH MITCHELL ROAD & RIVER BIRCH DRIVE, MANSFIELD, TX 76063

PROJECT NUMBER: YY-##
ISSUE DATE: MM/DD/YYYY

ZC#23-006

SHEET NAME:

REVISIONS:

EXHIBIT C

SHEET NUMBER:



SCALE: 1/8" = 1'-0"



NORTH ELEVATION - GREEN BUILDING TYPE

SCALE: 1/8" = 1'-0"

MATERIAL CALCULATION

NORTH ELEVATION
GLASS = 18%
SIDING = 16%
MASONRY = 43%
ROOF = 23%

GLASS = 9%
SIDING = 56%
MASONRY = 28%
ROOF = 7%

SOUTH ELEVATION

EAST ELEVATION
GLASS = 8%
SIDING = 35%
MASONRY = 55%
ROOF = 2%

WEST ELEVATION
GLASS = 8%
SIDING = 35%
MASONRY = 55%
ROOF = 2%

Level 5 Architecture

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ARCHITECT: JUSTIN S. GILMORE LEVEL 5 ARCHITECTURE

PROJECT INFORMATION:

SOUTH MITCHELL DEVELOPMENT

TOWNHOMES

SOUTH MITCHELL ROAD & RIVER BIRCH DRIVE, MANSFIELD, TX 76063

PROJECT NUMBER: YY-##
ISSUE DATE: MM/DD/YYYY


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ZC#23-006

SHEET NAME:

EXHIBIT C

SHEET NUMBER:

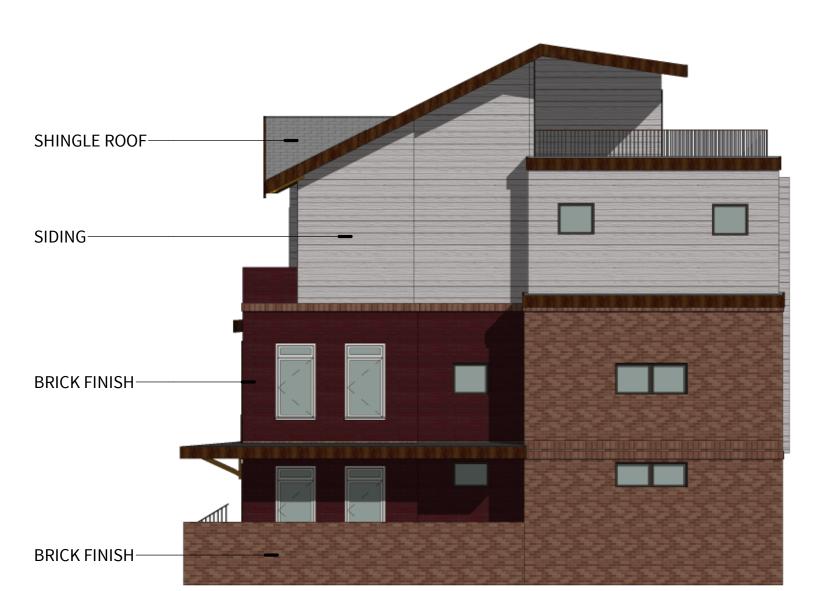


WEST ELEVATION


SCALE: 1/8" = 1'-0"



SCALE: 1/8" = 1'-0"

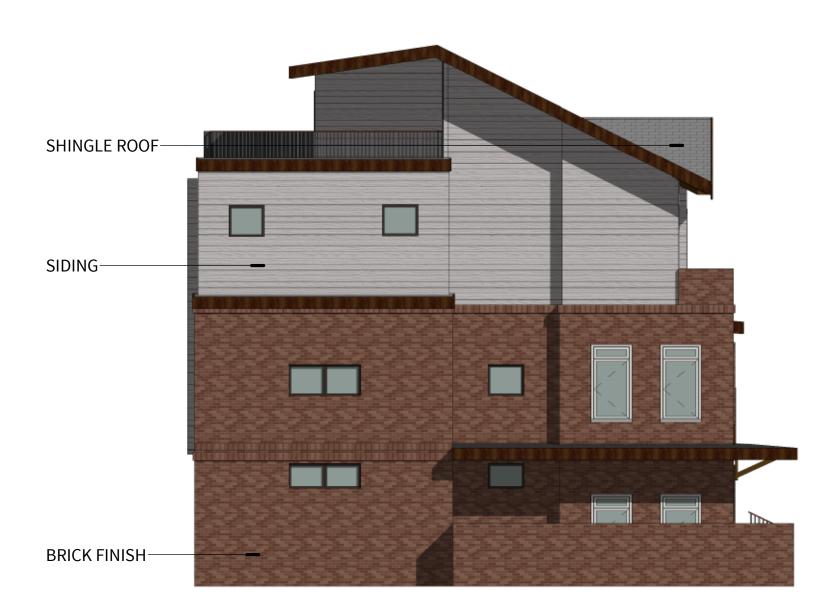

SCALE: 1/8" = 1'-0"

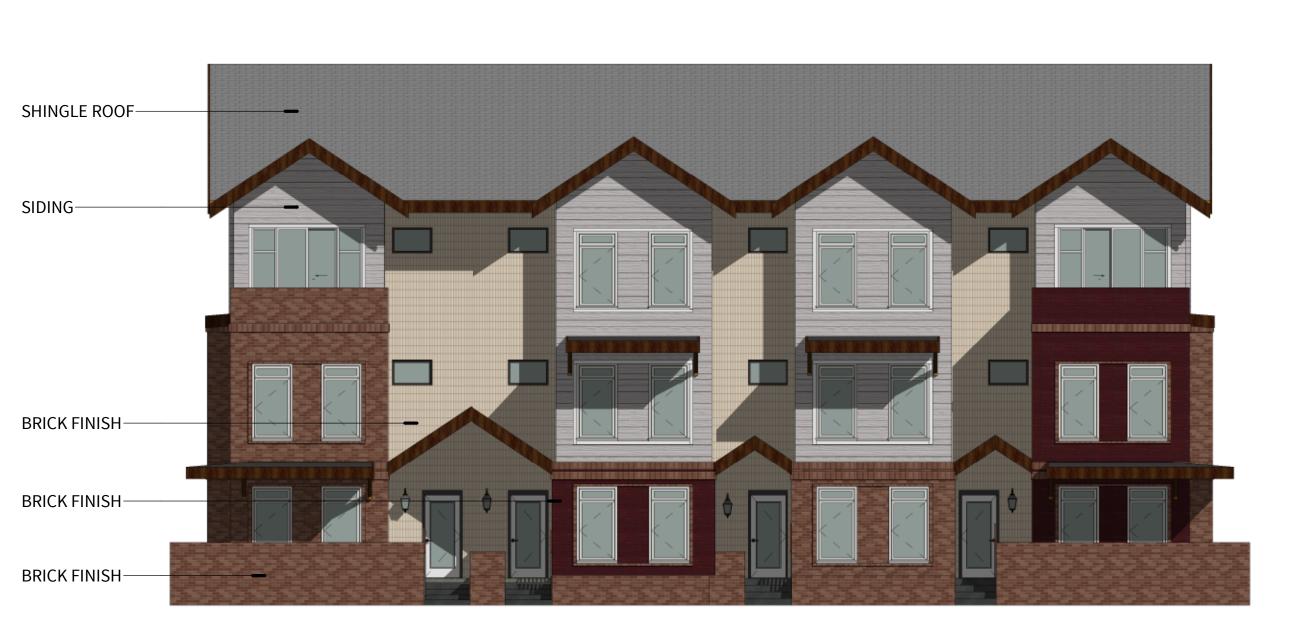

NORTH ELEVATION - BLUE BUILDING TYPE

SCALE: 1/8" = 1'-0"

MATERIAL CALCULATION

NORTH ELEVATION
GLASS = 18%
STUCCO = 16%
MASONRY = 44%
ROOF = 22%

EAST ELEVATION

MASONRY = 53%


GLASS = 7% STUCCO = 35%

ROOF = 5%

WI GL ST M/

SOUTH ELEVATION
GLASS = 9%
STUCCO = 58%
MASONRY = 23%
ROOF = 10%

WEST ELEVATION
GLASS = 7%
STUCCO = 35%
MASONRY = 53%
ROOF = 5%

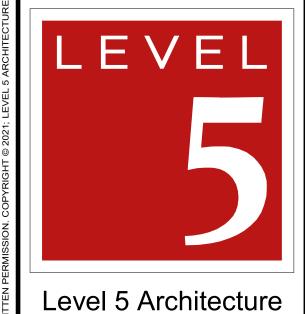

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PURPOSES

ARCHITECT:

JUSTIN S. GILMORE

LEVEL 5 ARCHITECTURE

PROJECT INFORMATION:

SOUTH MITCHELL DEVELOPMENT

TOWNHOMES

SOUTH MITCHELL ROAD & RIVER BIRCH DRIVE, MANSFIELD, TX 76063

PROJECT NUMBER: YY-##
ISSUE DATE: MM/DD/YYYY

REVISIONS:

ZC#23-006

SHEET NAME:

SHEET NUMBER:

EXHIBIT C

SD05

SHINGLE ROOF

STUCCO

BRICK FINISH

BRICK FINISH


WEST ELEVATION

SCALE: 1/8" = 1'-0"



SCALE: 1/8" = 1'-0"

SHINGLE ROOF-

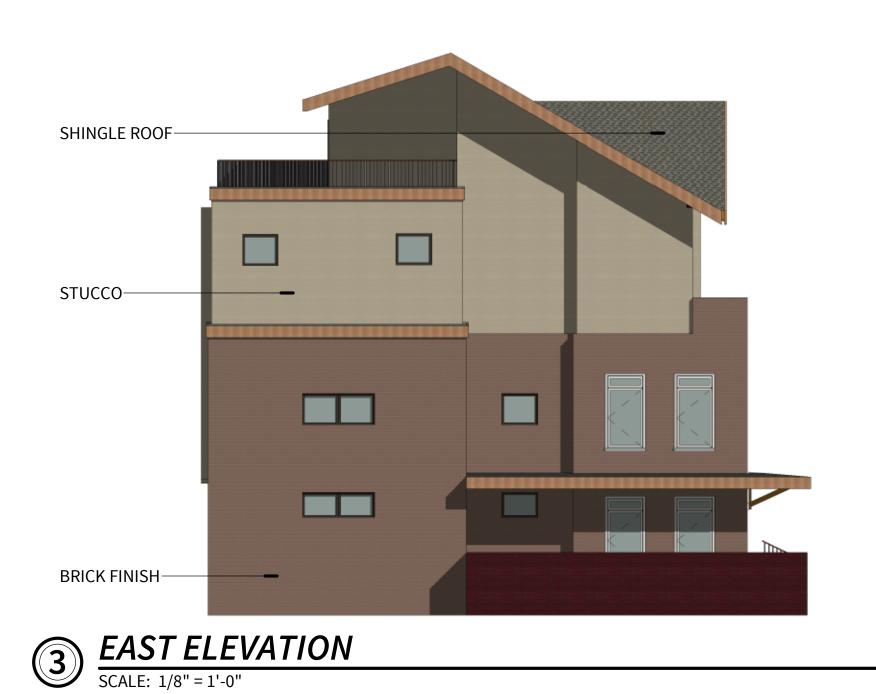

BRICK FINISH

BRICK FINISH

NORTH ELEVATION - YELLOW BUILDING TYPE

SCALE: 1/8" = 1'-0"


MATERIAL CALCULATION

NORTH ELEVATION
GLASS = 15%
SIDING = 31%
MASONRY = 35%
ROOF = 19%

EAST ELEVATION
GLASS = 8%
SIDING = 27%
MASONRY = 39%
ROOF = 26%

SOUTH ELEVATION
GLASS = 7%
SIDING = 59%
MASONRY = 28%
ROOF = 6%

WEST ELEVATION
GLASS = 8%
SIDING = 27%
MASONRY = 39%
ROOF = 26%

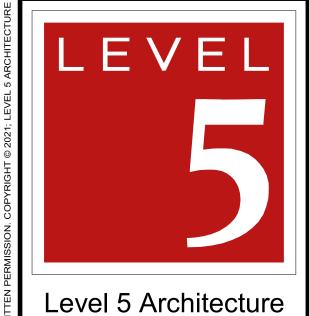

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PURPOSES

ARCHITECT:

JUSTIN S. GILMORE

LEVEL 5 ARCHITECTURE

PROJECT INFORMATION:

SOUTH MITCHELL DEVELOPMENT

TOWNHOMES

SOUTH MITCHELL ROAD & RIVER BIRCH DRIVE, MANSFIELD, TX 76063

PROJECT NUMBER: YY-##
ISSUE DATE: MM/DD/YYYY

REVISIONS:


ZC#23-006

SHEET NAME:

EXHIBIT C


SHEET NUMBER:

SD06

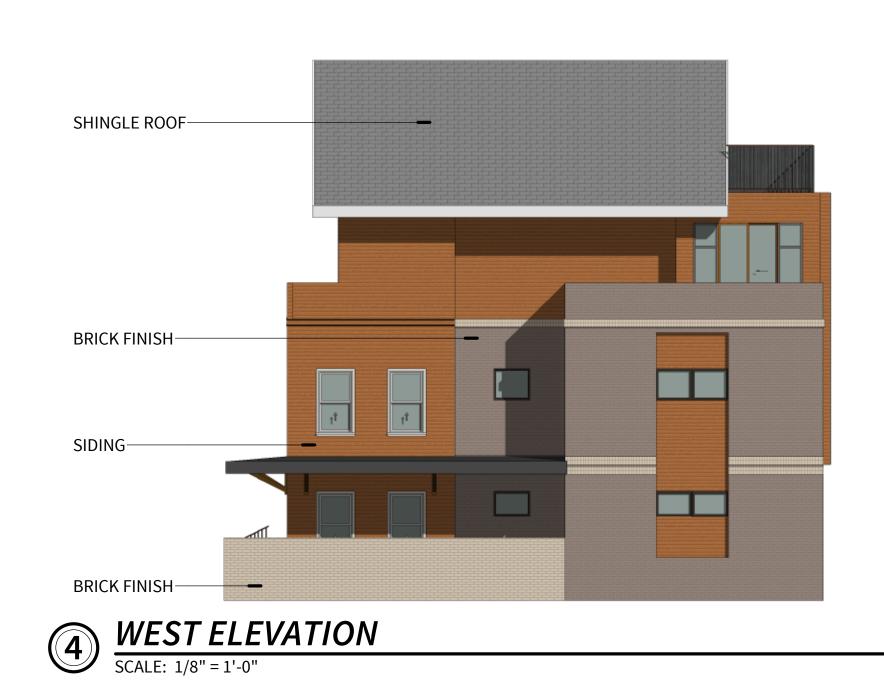




SCALE: 1/8" = 1'-0"

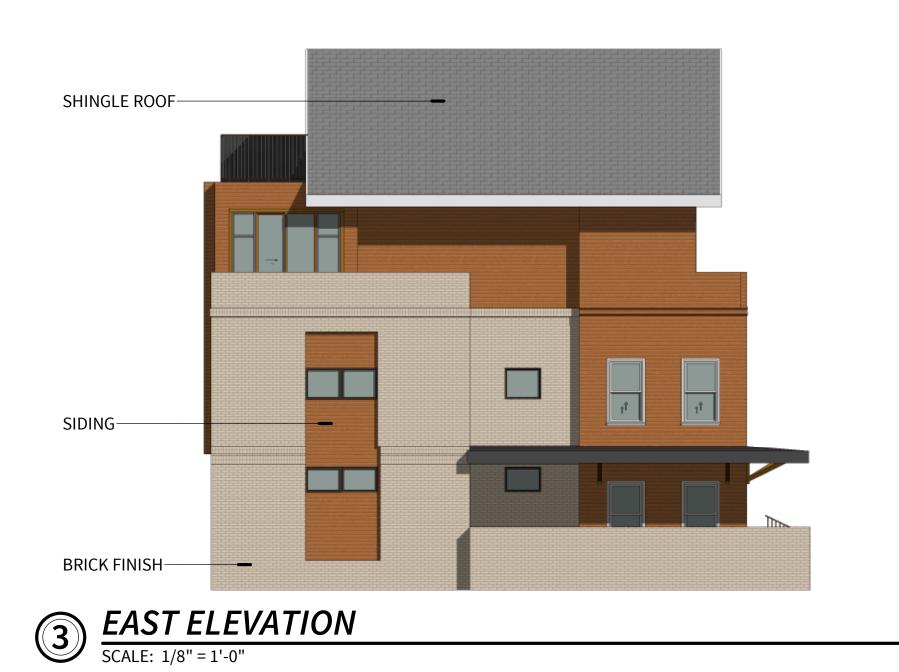



NORTH ELEVATION - RED BUILDING TYPE

SCALE: 1/8" = 1'-0"

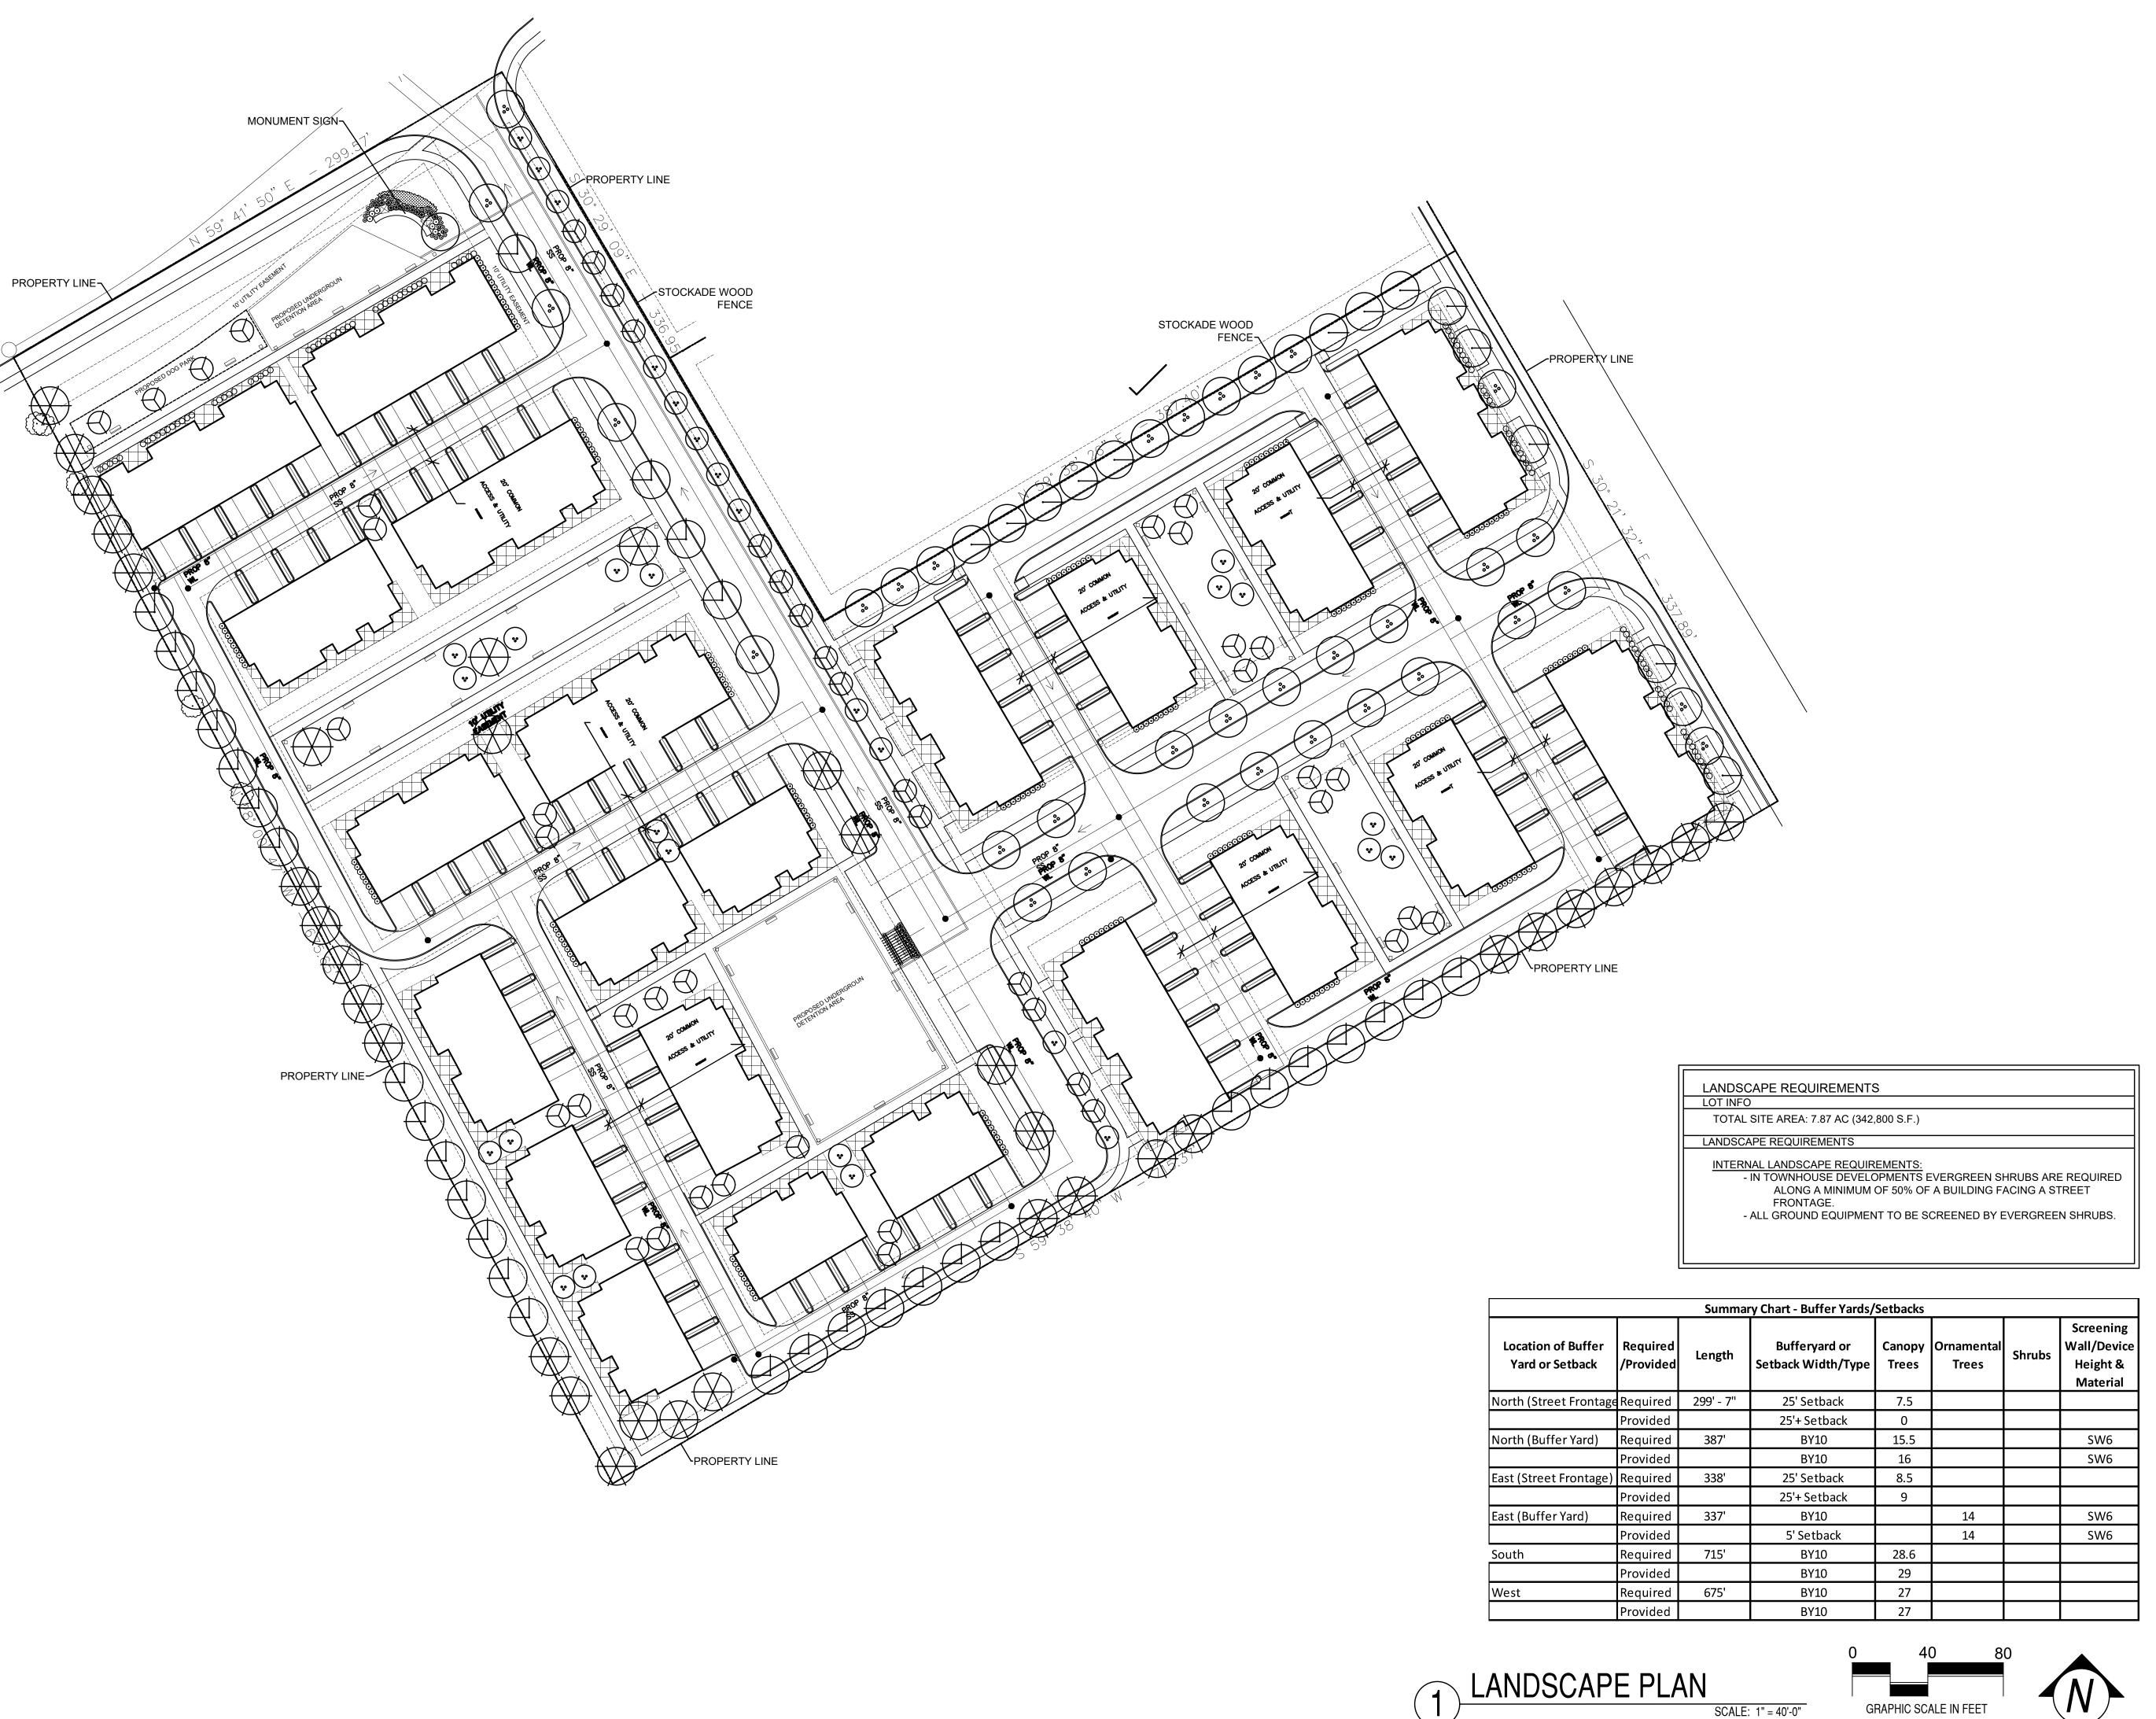


10-12-23 SITE PLAN SUBMITTAL

CLIENT:

LEVEL 5 DESIGN GROUP 501 E. Broad Street Mansfield, Texas 76063

architects

MEEKS DESIGN GROUP, INC. 1755 N. COLLINS BLVD., SUITE 300 RICHARDSON, TX 75080 PH (972) 690-7474 F (972) 690-7878

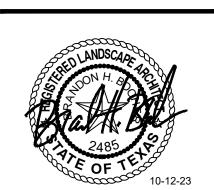

ZC#23-006 EXHIBIT D

MANSFIELD, TEXAS JOB NUMBER: LEV-2201

LANDSCAPE PLAN

SCALE: 1" = 40'-0"


LP0.01





TREE STAKE SOLUTIONS, LLC.

9973 FM 521 Road Phone: 281-778-1400 Mobile: 903-676-6143 Rosharon, Texas 77583 Fax: 281-778-1425 www.treestakesolutions.com

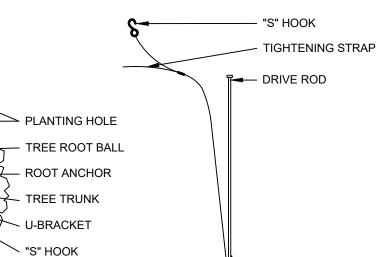

DETAIL A


ANCHOR

1. INSTALLATION TO BE COMPLETED IN ACCORDANCE WITH MANUFACTURER'S SPECIFICATIONS.

 DO NOT SCALE DRAWING. THIS DRAWING IS INTENDED FOR USE BY ARCHITECTS, ENGINEERS, CONTRACTORS, CONSULTANTS AND DESIGN PROFESSIONALS FOR PLANNING PURPOSES ONLY. THIS DRAWING MAY

NOT BE USED FOR CONSTRUCTION. 4. ALL INFORMATION CONTAINED HEREIN WAS CURRENT AT THE TIME OF DEVELOPMENT BUT MUST BE REVIEWED AND APPROVED BY THE PRODUCT MANUFACTURER TO BE CONSIDERED ACCURATE.

5. CONTRACTOR'S NOTE: FOR PRODUCT AND COMPANY INFORMATION VISIT www.treestakesolutions.com

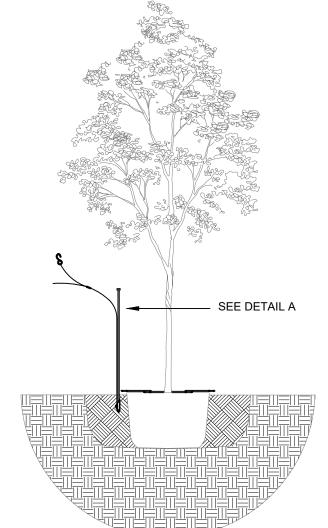

PLAN

- PLACE ANCHOR WITH RING SIDE DOWN AGAINST TOP OF ROOTBALL
- CENTER ROOT ANCHOR'S INNER RING(S) AROUND TRUNK OF TREE

ROOT ANCHOR ITEM# | ROOT BALL & CONTAINER SIZE | QUANTITY & ANCHOR SIZE

3 - V68 Anchors

3 - V88 Anchors

10 / 15 Gallon or 17" root ball

45 / 65 Gallon or 27-30" root ball

95 / 100 Gallon or 36" root ball

150 Gallon or 42" root ball

200 Gallon or 48" root ball

300 Gallon or 58" root ball

Root Balls larger than 60"

20 / 39 Gallon or 22" root ball

 ALIGN DRIVE ROD AS CLOSE AS POSSIBLE TO OUTSIDE EDGE OF U-BRACKET

15-BG

30-BG

45/65-BG

100-BG

150-BG

200-BG

300-BG

STEP 2:
DRIVE ANCHOR STRAIGHT DOWN INTO
UNDISTURBED SUBBASE SOIL TO

UNDISTURBED SUBBASE SOIL TO RECOMMENDED DEPTH AS PER TR SIZING CHAI

Contract of the second	
STEP STEP STEP STEP STEP STEP STEP STEP	
	Į
	1
	\$\bar{y}\$
STEP 3:	
REMOVE DRIVE ROD	
REPEAT STEPS 1 & 2 FOR ALL THREE (3) ANGUER LOCATIONS	

ANCHOR LOCATIONS

INTO			
REE			

HART BELOW	•	PULL BACK ON STRAP APPROXIMATELY 3"
		FOR THE V-68 ANCHOR, OR 6" TO 7" FOR
		THE V-88 ANCHOR TO SET ANCHOR INTO A
		HORIZONTAL OR LOCKED POSITION.
		A FULCRUM MAY BE REQUIRED TO ASSIST
		IN SETTING THE ANCHOR.
	•	PLACE "S" HOOK OVER THE END OF THE
		U-BRACKET
	•	PULL STRAP(S) UP VERTICALLY UNTIL
		ROOT ANCHOR RINGS BITE INTO THE TOP
		OF THE ROOT BALL AND U-BRACKETS ARE
		SETTING FLUSH ON TOP OF THE ROOT

	TREE DI ANTINO DETAIL
1 1	TREE PLANTING DETAIL




TIE EXCESS STRAPS OFF TO THE

NECESSARY

U-BRACKET ALLOWING ENOUGH

REMAINING STRAP TO ADJUST TREE, IF

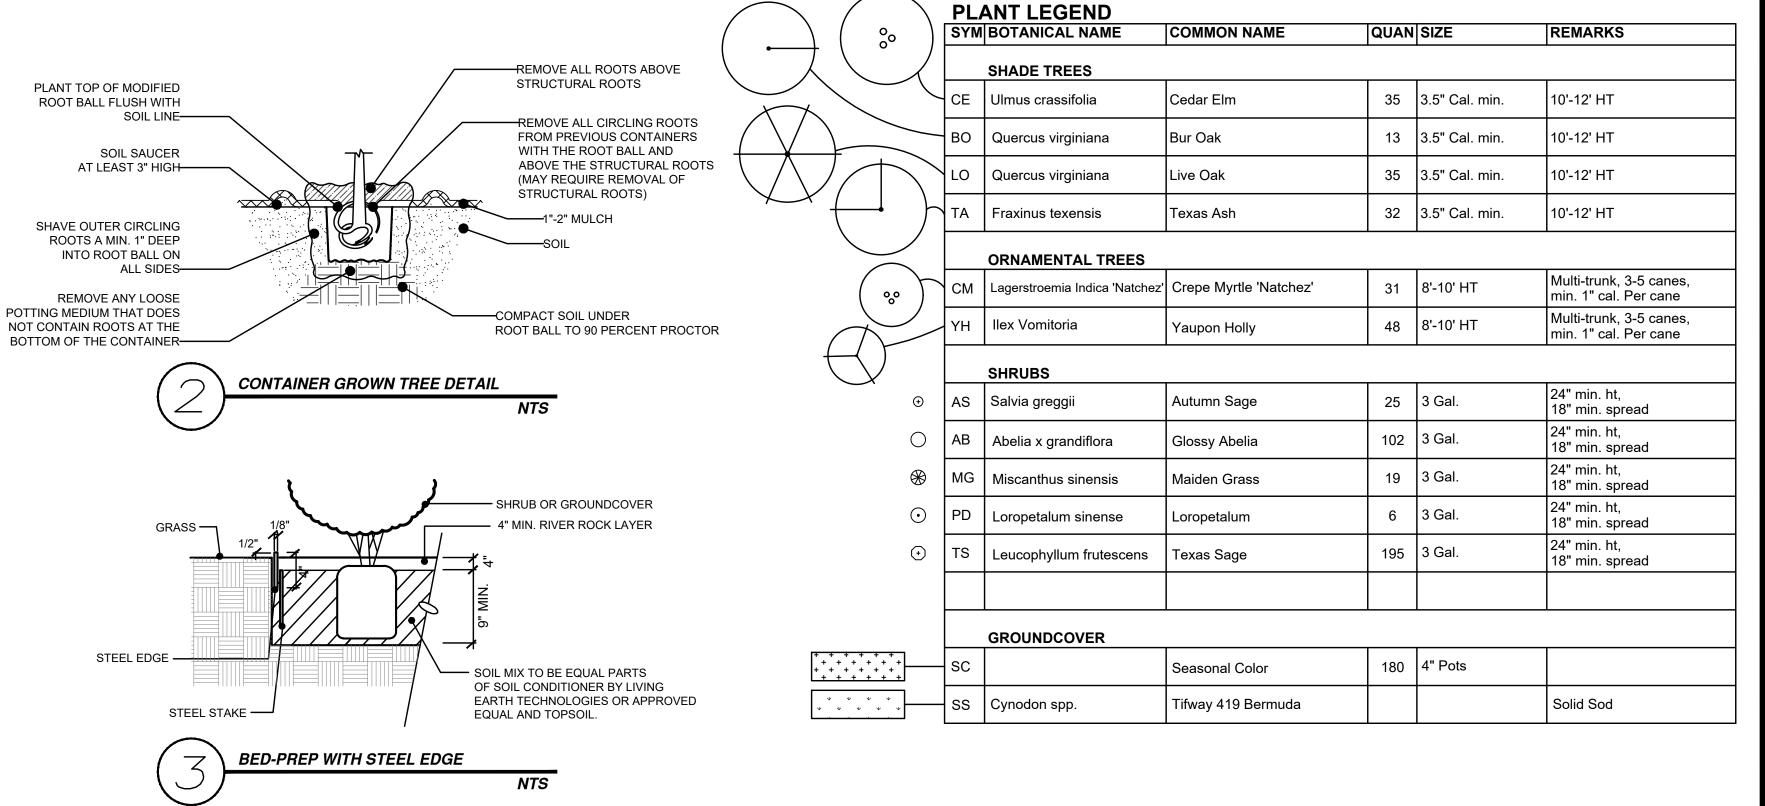

LANDSCAPING NOTES

- 1. ALL PLANT MATERIAL SHALL MEET THE LATEST REQUIREMENTS OF THE AMERICAN STANDARD FOR NURSERY STOCK (ANSI Z60.1).
- 2. ALL NEW PLANT MATERIAL SHALL BE PLANTED AND MAINTAINED IN ACCORDANCE WITH THE LATEST EDITION OF THE AMERICAN NATIONAL STANDARDS INSTITUTE REQUIREMENTS FOR TREE, SHRUB, AND OTHER WOODY PLANT MAINTENANCE (ANSI A300 PARTS 1 THROUGH 6).
- 3. PROVIDE ADJUSTABLE BUBBLERS ON ALL TREES IN ORDER TO MEET THE SPECIFIC HYDROLOGIC REQUIREMENTS OF NEWLY PLANTED TREES IN ACCORDANCE WITH TCEQ.
- 4. DRIP EMITTERS (BUBBLERS) SHALL BE INSTALLED AT EACH TREE LOCATION AND OPERATE ON VALVES SEPARATE FROM THE SPRAY ZONES.
- 5. NO TREE SHALL BE PLANTED CLOSER THAN 5 FEET FROM ANY UNDERGROUND PUBLIC WATER AND WASTEWATER LINE.
- 6. NO TREE SHALL BE PLANTED CLOSER THAN 4 FEET FROM IMPERVIOUS COVER.
- 7. FENCES, LANDSCAPING AND OTHER ITEMS WILL NOT BE INSTALLED IN LOCATIONS WHERE THEY WILL OBSTRUCT THE VISIBILITY OF, OR ACCESS TO, FIRE HYDRANTS OR FIRE DEPARTMENT CONNECTIONS (FDC).

TYPICAL PLANTING NOTES

- 1. ALL PLANT MATERIAL LOCATIONS SHALL BE STAKED IN THE FIELD BY THE CONTRACTOR AND APPROVED BY THE OWNER / LANDSCAPE
- THE CONTRACTOR SHALL VERIFY ALL BUILDING SETBACK LINES, EASEMENT LINES, AND VISIBILITY LINES IN THE FIELD PRIOR TO
- 4. THE CONTRACTOR SHALL VERIFY LOCATIONS OF ALL UTILITIES. SHOWN ON THIS PLAN AND NOT SHOWN ON THESE PLANS, IN THE FIELD PRIOR TO COMMENCEMENT OF WORK.
- 5. PROVIDE POSITIVE DRAINAGE AWAY FROM ALL SITE FEATURES.
- 6. STEEL EDGING SHALL BE INSTALLED AT ALL LOCATIONS WHERE PLANT MATERIALS MEET TURF AREAS.

CONTRACTOR IS RESPONSIBLE FOR ALL PLANT MATERIAL SHOWN ON PLANTING PLANS. THE PLANT LIST IS TO BE USED FOR PLANT NAMES, SYMBOLS, SIZES AND SPACING, QUANTITIES SHOWN ARE FOR COMPARISON AND SHOULD ONLY BE USED FOR BIDDING OR PRICE QUOTES.

- ARCHITECT PRIOR TO INSTALLATION.
- 2. FINE GRADING SHALL BE PERFORMED IN ALL AREAS TO BE SEEDED/SODDED. FINE GRADING SHALL INCLUDE THE REMOVAL OF DEBRIS, ROCKS, ETC. FROM THE SITES AND INSURE POSITIVE DRAINAGE IN ALL AREAS SEEDED/SODDED.
- CONSTRUCTION.

) 10-12-23 SITE PLAN SUBMITTAL REVISIONS:

CLIENT:

LEVEL 5 DESIGN GROUP 501 E. Broad Street Mansfield, Texas 76063

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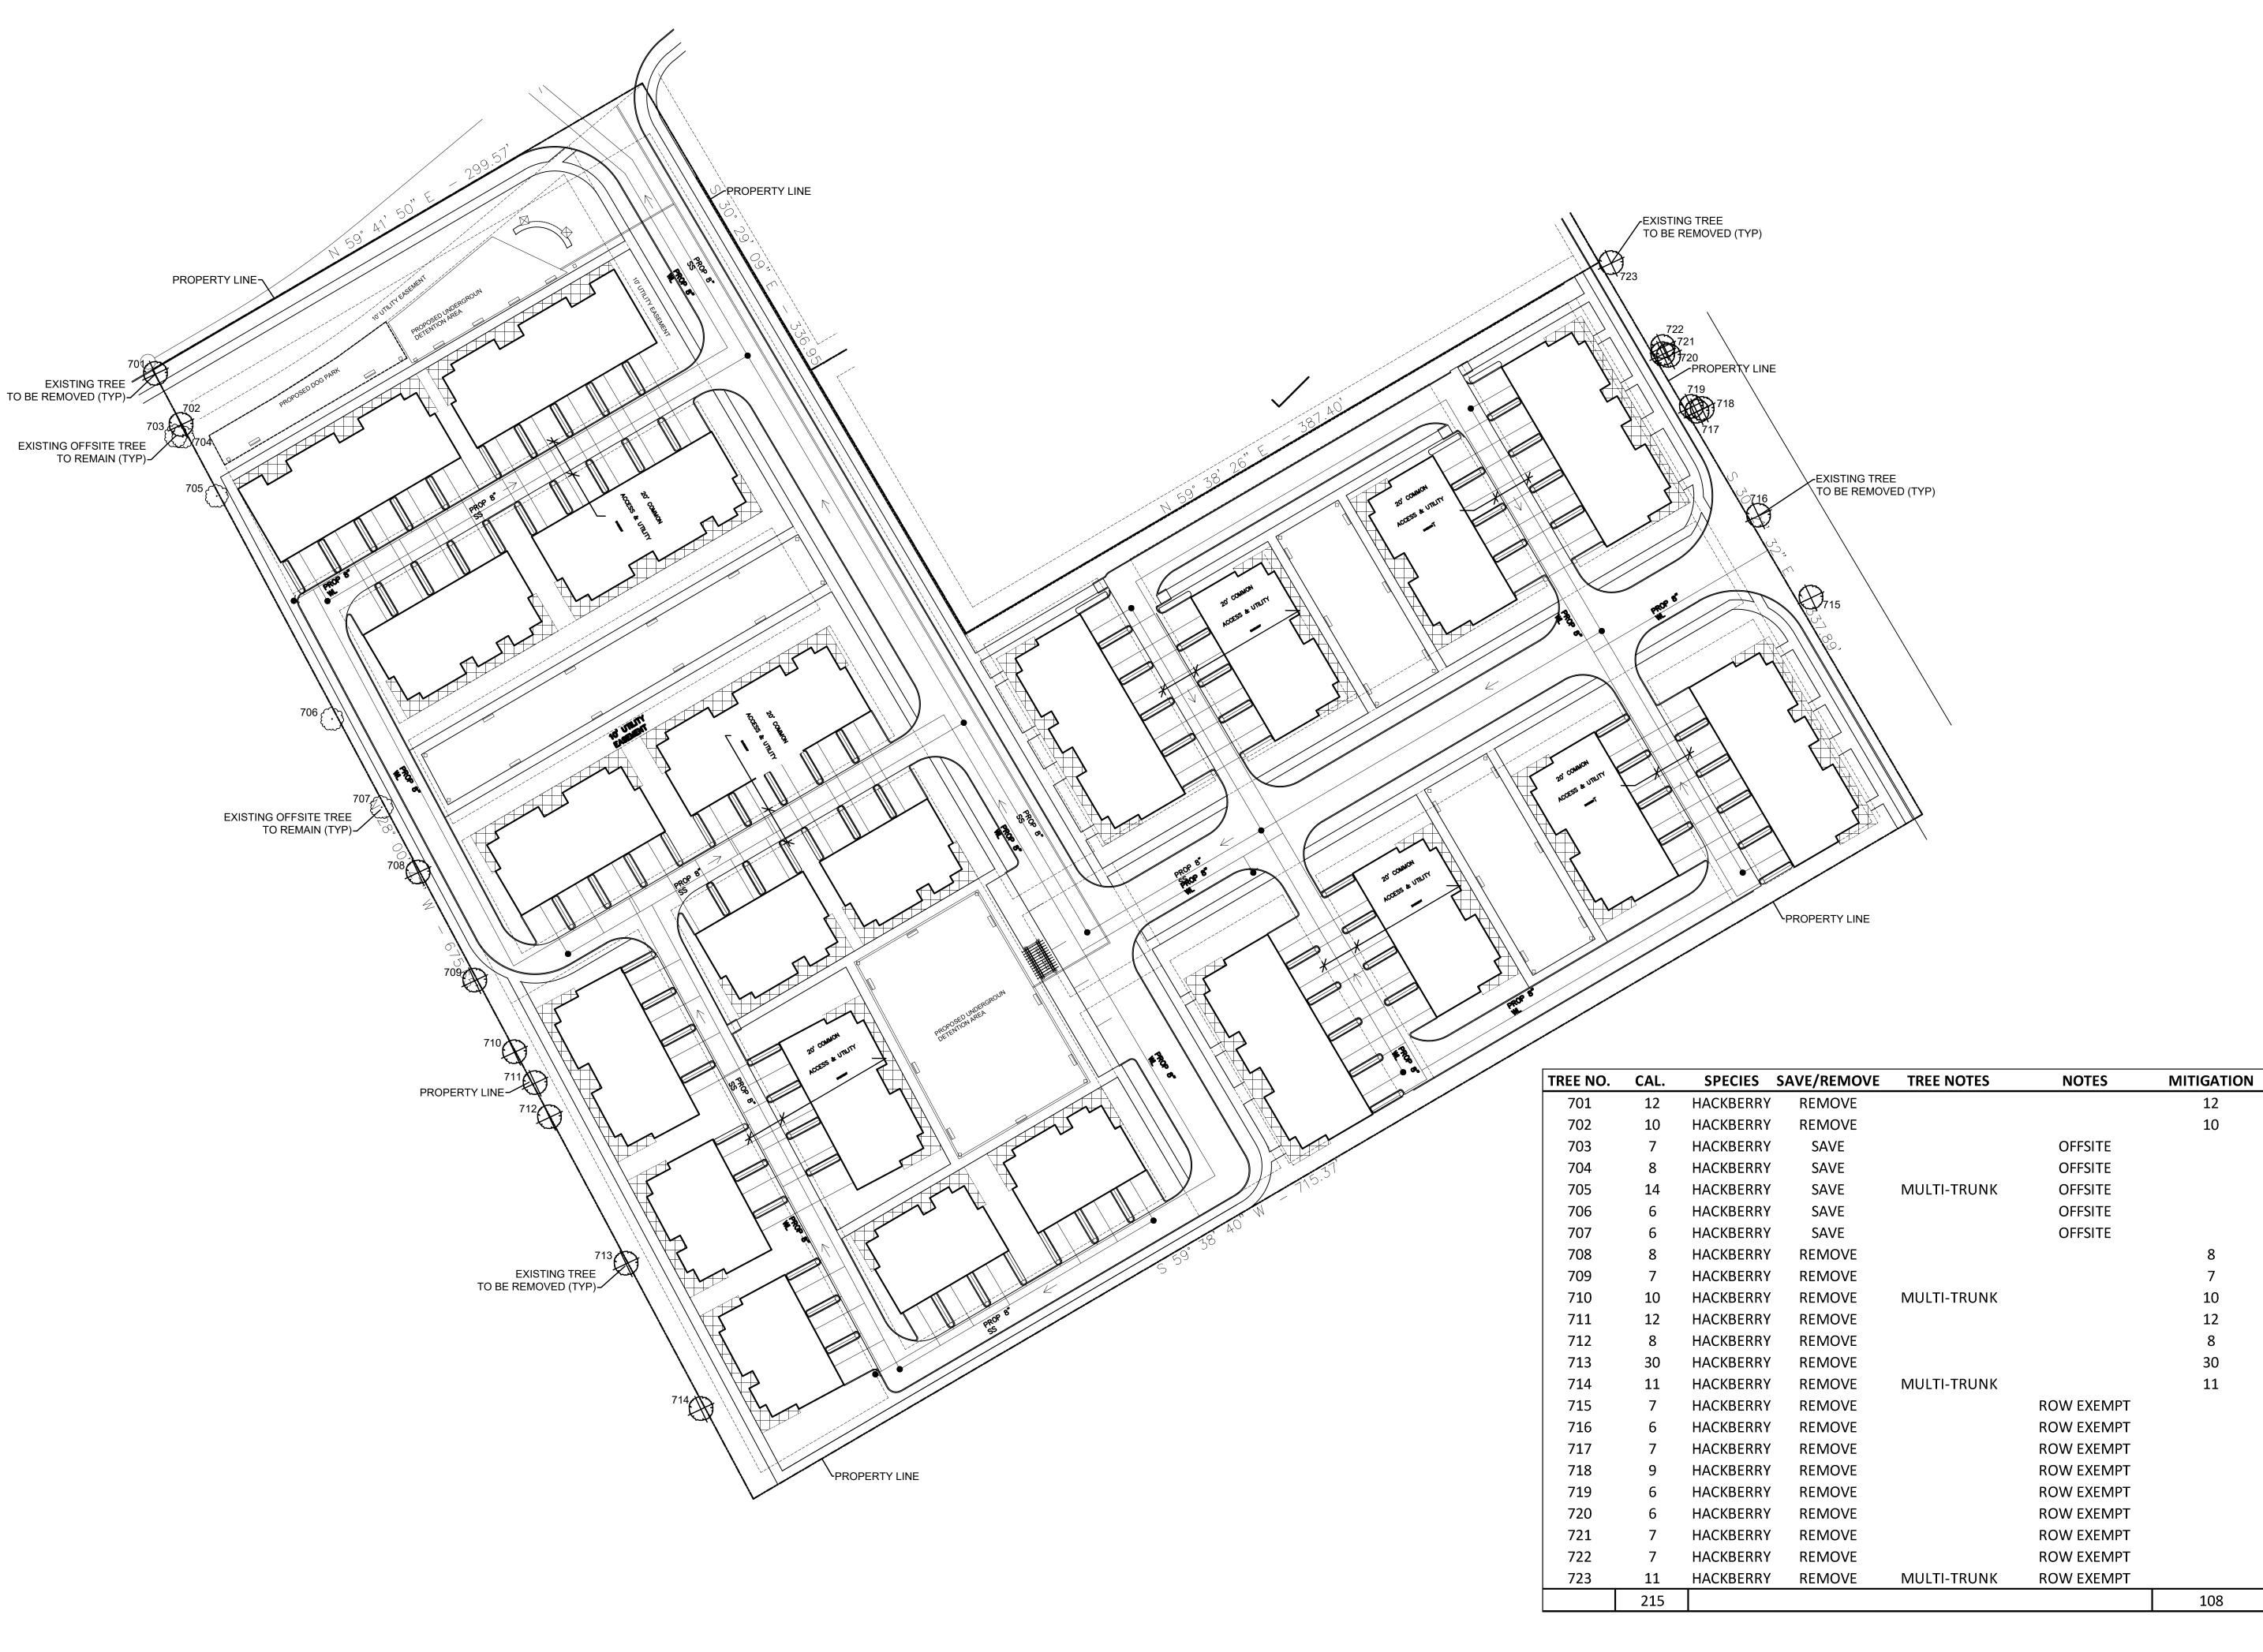
ZC#23-006 EXHIBIT D IANSFIELD, TEXAS

PLANT LIST AND

JOB NUMBER: LEV-2201

DETAILS

LP0.02



10-12-23 SITE PLAN SUBMITTAL

CLIENT:

LEVEL 5 DESIGN GROUP 501 E. Broad Street Mansfield, Texas 76063

architects

MEEKS DESIGN GROUP, INC. 1755 N. COLLINS BLVD., SUITE 300 RICHARDSON, TX 75080 PH (972) 690-7474 F (972) 690-7878



ZC#23-006 EXHIBIT D

JOB NUMBER: LEV-2201

TREE PRESERVATION

TS-1

TREE PRESERVATION PLAN
SCALE: 1" = 40'-0"

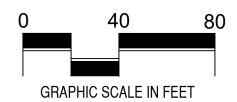


EXHIBIT E FOR ZC#23-006

DREAMSVILLE MANSFIELD, PLANNED DEVELOPMENT DISTRICT REGULATIONS

PURPOSE AND INTENT:

The purpose and the intent of this Dreamsville Mansfield Planned Development District (this "PD, PLANNED DEVELOPMENT DISTRICT"), is to provide a distinct set of regulations that will produce a new housing community on an infill parcel of land for a multi-generational development that is not only aesthetically pleasing in all aspects, but carries an efficient use of infill development.

APPLICABILITY:

- A. All proposed development shall be in accordance with the provisions of this PD, Planned Development District, and development plans recorded hereunder, if any, shall be binding upon the applicant thereof, his and all successors and assigns, and shall limit and control all applications for building permits.
- B. The provisions of Chapter 155 of the Mansfield Code of Ordinances (Zoning Ordinance)
 shall continue to be applicable to all issues not covered by the regulations found in this
 PD, Planned Development District.
- C. In the event of a conflict between these PD, Planned Development District standards and the Zoning Ordinance, as amended, the standards that are set forth herein shall prevail.
- D. In the event of a conflict between these PD, Planned Development District standards and any of its illustrations, photographs, and other exhibits, including the site plan, that are

- attached thereto, and that are specified elsewhere in text, the standards that are set forth herein in the text shall prevail.
- E. In the event of a conflict between these PD, Planned Development District standards and any other codes, ordinances, regulations, or standards as adopted by the City of Mansfield, Texas, the standards that are set forth herein shall prevail.
- F. The appeals process for this PD, Planned Development District, follows the considerations and procedures as set forth in Section 155.066 of the Mansfield Zoning Ordinance.

DESCRIPTIONS OF DEVELOPMENT TRACT:

Development pursuant to the provisions of this PD, Planned Development District, is regulated in accordance with the intensity of the residential uses permitted, according to the following legally descripted tract:

A. DEVELOPMENT TRACT OF LAND LOCATED IN THE SAMUEL MITCHELL SURVEY, ABSTRACT NO. 593 (EXHIBIT "A").

DEVELOPMENT PLAN:

For the purpose of this PD, Planned Development District, a site plan and illustrative renderings of the dwelling unit types are attached hereto, respectively, as "EXHIBIT B - SD01" (collectively the "DEVELOPMENT PLAN") to achieve the following:

A. To establish all required setbacks and buffers for the property in the locations identified on the Development Plan;

B. To identify the uses of the dwelling units and clarify business applications within the dwelling units.

DEFINITIONS:

The following provides definitions for terms used in this PD, Planned Development District, that are technical in nature or otherwise may not reflect a common usage of the term. Where terms are not defined in this PD, Planned Development District, and are defined in Section 155.012 of the Mansfield Code of Ordinances, such terms shall have the meanings ascribed to them as found in that Section. Where terms are not defined in this PD, Planned Development District or in Section 155.012 of the Mansfield Code of Ordinances, such terms shall have ordinarily accepted meanings such as the context applies.

ANCILLARY ROOF: A secondary structure attached to the principal structure, typically in the form of a one-story structure attached to a two-story structure.

ARCH: A curved symmetrical structure spanning an opening and typically supporting the weight of a bridge, roof, or wall above it.

ATTIC: The interior part of a building contained within a pitched roof structure.

AWNING: A fixed or movable shading structure, and cantilevered or otherwise entirely supported from a building, used to protect outdoor spaces from sun, rain, and other natural conditions.

BROWNSTONE: A single-family dwelling that shares a party wall with another of the same type and it occupies the full width of the front lot line (SYNONYM: ROW HOUSE, SINGLE-FAMILY ATTACHED).

BUILDING ELEVATION: An exterior wall of a building.

BUILDING FRONTAGE: The area between a building elevation and the public right-of-way, it is inclusive of its built and planted components.

BUILDING HEIGHT: The vertical extent of a building measured in stories.

DRIVEWAY: A vehicular lane within a lot, often leading to a garage.

DOORYARD FRONTAGE: A building frontage type with a shallow setback and a front garden or a patio, usually with a low wall or hedge at the lot line, minimum of 3'-0" (VARIANT: LIGHTWELL, LIGHT COURT).

GLAZING: The portion of a building elevation that is comprised of transparent glass, and that is usually set in doors and windows.

LOT: A parcel of land accommodating a building or buildings under single ownership.

LOT COVERAGE: The percentage of any lot that may be covered by buildings and other roofed structures.

LOT LINE: The boundary that legally and geometrically demarcates a lot.

PIER: A solid support that is designed to sustain vertical pressure.

PORCH: An open-air room appended to a building, with floor and roof, but no walls on at least two (2) sides. Typical porch provided on sheet "EXHIBIT B - SD01". Minimum depth is 5'-0" and width of 10'-0".

PRINCIPAL ENTRANCE: The main point of access for pedestrians into a building.

REAR ALLEY: a private right-of-way, or access easement, designated to be a secondary means of vehicular access to the rear or to the side of lots; a rear alley may connect to a vehicular driveway located to the rear of lots providing access to accessory buildings, service areas, and parking, and may contain utility easements.

STOOP FRONTAGE: A building frontage wherein the building elevation is aligned close to the front lot line with the first story elevated from the sidewalk for privacy, and with an exterior stair and a landing at an entrance. Typical stoop provided on sheet "EXHIBIT B - SD01"

STORY: A habitable level within a building, excluding an attic or a raised basement.

GENERAL SITE AND BUILDING STANDARDS:

A. <u>CONSIDERATIONS FOR UTILITIES.</u>

- 1. Utilities shall be placed underground.
- Utility services may require easements at the front, side, or rear lot lines for meters, pedestals, and other equipment requirements.

B. CONSIDERATIONS FOR LANDSCAPING.

- 1. All landscaping plans shall require approval by the Director of Planning.
- 2. All topographic transitions between improvements and existing grades or between lots shall appear to be natural slopes or to be garden terraces. In the event natural slopes or garden terraces are not possible, retaining walls may be used, at a maximum height of 2'-09, subject to review and approval by the Director of Planning.
- 3. All removal of trees larger than six (6) inches caliper shall require approval by the Director of Planning.

C. CONSIDERATIONS FOR LIGHTING.

- 1. Exterior light fixtures shall be compatible with the architectural style of the building to which they are attached.
 - a. Uplighting, floodlighting, and wall washing lighting shall be prohibited.
- 2. Garage doors opening onto a rear alley shall provide a light fixture with a photocell that lights from dusk to dawn.

SITE AND BUILDING STANDARDS SPECIFIC TO SINGLE-FAMILY ATTACHED (BROWNSTONES):

The site and building standards provided below shall be specific to construction the legally described property in "EXHIBIT A" and intended to allow only for single-family attached residential uses (i.e., brownstones) situated on individually platted lots.

A. PERMITTED USES.

- 1. The uses permitted for lots shall be expressly limited to the following:
 - a. Brownstone.
 - b. Home Occupation.

B. <u>LOT ORIENTATION</u>.

- 1. All lots shall front on a street or a civic space.
- 2. All lots shall be accessed from a rear alley.

C. LOT SIZE AND LOT OCCUPATION.

- 1. The minimum lot size shall be a minimum of 1,800 square feet.
 - a. The minimum lot width shall be 22 feet.
 - b. The minimum lot depth shall be 80 feet.
 - c. The minimum lot frontage shall be 20 feet.
- 2. The maximum lot coverage for all principal buildings and their accessory buildings shall not exceed 70 percent.
- 3. The minimum habitable area for a principal building shall be 1,500 square feet of enclosed space, not including garages, patios, and porches.

D. <u>BUILDING SETBACKS</u>.

- 1. General:
 - a. Only one (1) principal dwelling unit may be built on each lot
- 2. <u>Principal Buildings</u>:
 - a. Minimum front yard 5 feet.
 - b. Minimum side yard 0 feet.
 - c. Minimum rear yard 5 feet.
- 3. Accessory buildings.
 - Applicable regulations and restrictions for accessory building setbacks per
 Section 155.099 of the Mansfield Code of Ordinances shall apply.

E. BUILDING HEIGHT.

- 1. General:
 - a. Building height is limited by stories and is measured from highest adjacent

- sidewalk grade. Stories shall not exceed more than 14 feet in height.
- b. Building height shall be measured from finished floor to finished ceiling.
- c. Below grade stories do not count towards height calculations, provided they do not extend more than four (4) feet above the sidewalk grade.
- d. Chimneys, cupulas, antennae, vents, elevator bulkheads, stair housing, and other uninhabited elements do not count towards building height.

2. <u>Principal buildings</u>.

- a. Principal buildings shall have a minimum height of three (3) stories and be limited to a maximum height of three and a half (3.5) stories.
- b. Principal buildings shall have a minimum ceiling height of ten (10) feet at the first story.

F. <u>BUILDING FRONTAGES</u>.

1. General:

- a. Lots fronting on two (2) or more streets or civic spaces shall have building frontages along each street or civic space. Identified on Site Plan Notes on sheet "EXHIBIT B SD01"
- b. Balconies, bay windows, and such are permitted to encroach into the front setback up to 100 percent of its depth.
- c. In order to encourage diversity in design, building frontages shall vary lot to lot.
- d. All brownstones shall provide a dooryard frontage or a stoop frontage.

2. Dooryard frontages:

- a. Dooryards may be raised a minimum of two (2) feet from average sidewalk grade at the frontage.
- b. Fences or walls shall be provided as a part of the dooryard.
- c. All dooryards shall be no less than five (5) feet deep.
- d. All dooryard fences and walls shall be four (4) feet in height.
- e. All dooryards shall be bound by fences or walls on three (3) sides.
- f. An evergreen hedge may replace a fence or wall.
- g. Dooryards may be paved in brick, cobble, or stone.

3. Stoop frontages:

- a. All stoops shall be no less than five (5) feet in depth.
- b. All stoops shall be between four (4) and six (6) feet in width.
- c. All stoops shall be covered by a pitched roof structure.
- d. Stoops may encroach into the front setback up to 100 percent of its depth.
- e. Stoops may be recessed into the main volume of the brownstone where front setbacks are less than five (5) feet.

G. PARKING REQUIREMENTS.

1. General:

- a. A minimum of two (2) parking spaces shall be provided for each principal dwelling unit and located within a garage.
- b. Required parking shall be accessed from a rear alley and the required parking shall be oriented to the rear of the lot.

- c. All garages shall be configured in the following orientation, as generally described below:
 - (i) Rear-entry, within the principal dwelling unit volume; and
 - (ii) The garage shall be set toward the rear of the principal dwelling unit volume.

H. ARCHITECTURE.

1. General.

- a. Block based architecture diversity shall include special details to enhance the distinctiveness of each unit. This may include changes in color, material, height, entry portico, stoops, railings, et cetera. Site Plan located on sheet "EXHIBIT B SD01" shows different colors to represent each block-based architecture units.
- b. There shall be no more than five (5) principal dwelling units attached under the same roof.

2. Walls.

- a. More than two (2) building wall materials shall be used on the exterior of a brownstone, excluding bay windows, patios, porches, exterior shutters, trim, and such.
- b. Building walls shall be finished in brick or stone. Cementitious fiber board, stucco, and wood can only be used as an accent material and where used on a single building, shall not exceed 20 percent of the total building wall area, with each building elevation being calculated independently.

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- (i) All stucco shall be masonry.
- (ii) All stucco shall have a smooth sand finish.
- (iii) All exposed exterior wood shall be painted or stained.
- (iv) Exterior insulation and finish systems (E.I.F.S.) are prohibited.
- c. The heavier of the building wall materials shall be located below the light (e.g. stone below brick; brick below stucco; and stucco below cementitious fiber board and wood). The material transition shall run horizontally across the entire length of the building elevation.
- d. Arches and piers shall match the primary materials and the primary colors of the building walls and shall be no less than 12 inches by 12 inches.
- e. Columns shall be made of concrete or stone and shall be no less than 12 inches by 12 inches.
- f. Posts shall be made of wood or a synthetic material that has the appearance of wood.
 - (i) All posts shall be no less than six (6) inches by six (6) inches.
- g. All columns, piers, and posts shall be appropriately spaced in order to form square or vertically proportioned bays.

3. Roofs.

a. Principal roofs, where sloped, shall be symmetrical gable or hip and angled no less than 6:12. Sloped roofs shall only be clad in asphalt shingle, slate, or terra cotta tile. Sloped roof cladding may include metal, provided that it complements an architectural style and that it minimizes glare.

- b. Principal roofs, where low-slope (i.e., flat), shall be surrounded on all sides by a horizontal parapet wall no less than three-and-a-half (3.5) feet in height where the roof deck meets the parapet wall.
- c. Ancillary roofs may be sheds angled no less than 3:12.

4. Openings.

- a. Principal dwelling units shall have a limit for door and window openings in building elevations that are set along a street or a civic space. No less than 15 percent and no more than 40 percent of the total building wall area shall be used for door and window openings.
 - (i) All windows openings shall be vertically proportioned and shall be rectangular in shape where visible from streets and civic spaces.
 - (ii) All windows shall use vertically proportioned panes, excluding any transom windows above door openings visible from streets and civic spaces.
- b. Door and window openings shall reveal their thickness within the building wall, and where appropriate to the building material that is used. Doors and windows in building walls made of brick, stone, and stucco shall be recessed a minimum of three (3) inches in depth.
- c. Door and window header heights shall be consistent on building elevations fronting a street or a civic space.
- d. Door and window openings in building elevations that are set along a street or a civic space shall be evenly spaced to create a harmonious composition.

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e. Garage doors shall be made of wood or composite wood and may have glass or framed panels.

5. Attachments.

- a. Chimneys, where visible, shall be clad in brick, stone, or stucco.
 - (i) All chimneys shall extend to the ground and shall have a projecting cap on top.
- b. All flooring at stoops (e.g., the exterior stair and the landing) shall be made of brick, concrete, or stone to match the building wall finish.
- c. All flooring at balconies and at porches shall be made of brick, concrete, or stone.
- d. Any part of a balcony projecting beyond a building wall shall be structurally supported by concrete beams or profiled sills or wood beams or brackets of appropriate scale.

I. <u>STREETSCAPE STANDARDS</u>.

- Private streets shall be paved in concrete, and they may be paved in other surface
 materials including asphalt, brick, cobble, or stone subject to review and approval
 by the Director of Planning.
- 2. Private streets shall have street trees planted on center, every 30 feet.
- 3. The minimum sidewalk width shall be five (5) feet.
- 4. The minimum parkway width shall be four (4) feet.
- 5. Rear Alleys:

a. The minimum width of the access easement for an alley shall be 20 feet and shall have a minimum pavement width of 14 feet.

J. <u>SITE PLAN</u>.

1. Development shall require a site plan subject to review and approval by the Director of Planning. Such site plan shall be reviewed and approved prior to platting and the issuance of any building permit. The site plan shall be prepared and submitted to demonstrate compliance with all the provisions for development and all other applicable provisions of this PD, Planned Development District and the Mansfield Code of Ordinances.

MISCELLANEOUS STANDARDS:

A. BUILDING MECHANICAL AND ROOFTOP MECHANICAL EQUIPMENT.

- Building mechanical equipment including, but not limited to, electric meters, gas
 meters, water meters, and transformers and refuse storage shall be visually
 screened.
- 2. Rooftop mechanical equipment shall be visually screened from all sides by parapet walls or opaque screening enclosures, both of which shall be a minimum of twelve (12) inches greater in height than the equipment.

B. COLLECTION RECEPTACLES.

All collection receptacles shall be visually screened on all sides by a solid,
 opaque wall a minimum of six feet in height, and constructed of a material

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matching the nearest building wall to the satisfaction of the Director of Planning. All access doors into the collection receptacle shall be made of opaque metal matching the height of the solid walls.

C. MANDATORY PROPERTY OWNERS' ASSOCIATION.

1. A mandatory property owners' association shall be recorded in the public records of Tarrant County, Texas, and shall be binding upon all purchasers of land within development. The mandatory property owners' association shall be responsible for the maintenance of all on-site parking, lighting, landscape, irrigation, fences, walls, gates (non-vehicular, access control systems, storm water quality and detention systems, private streets, and civic space and amenities.