


South Elevation	Area(sf) 9	6
Glass	1,145	34.4%
Brick	700	21.1%
Stone-look Tilt-wall	1,387	41.7%
ACM	92	2.8%
Total	3,324	100.0%
West Elevation	Area(sf) %	
Glass	750	24.5%
Brick	721	23.6%
Stone-look Tilt-wall	1,520	49.7%
ACM	65	2.1%
Total	3,056	100.0%


EXTERIOR ELEVATION - OVERALL FRONT (SOUTH) SCALE: 1/16" = 1'-0"

TEXAS RETINA

EXHIBIT C - 1 of 3 5 December 2017 CASE: DS#17-003

ENVIRONMENTS FOR HEALTH ARCHITECTURE

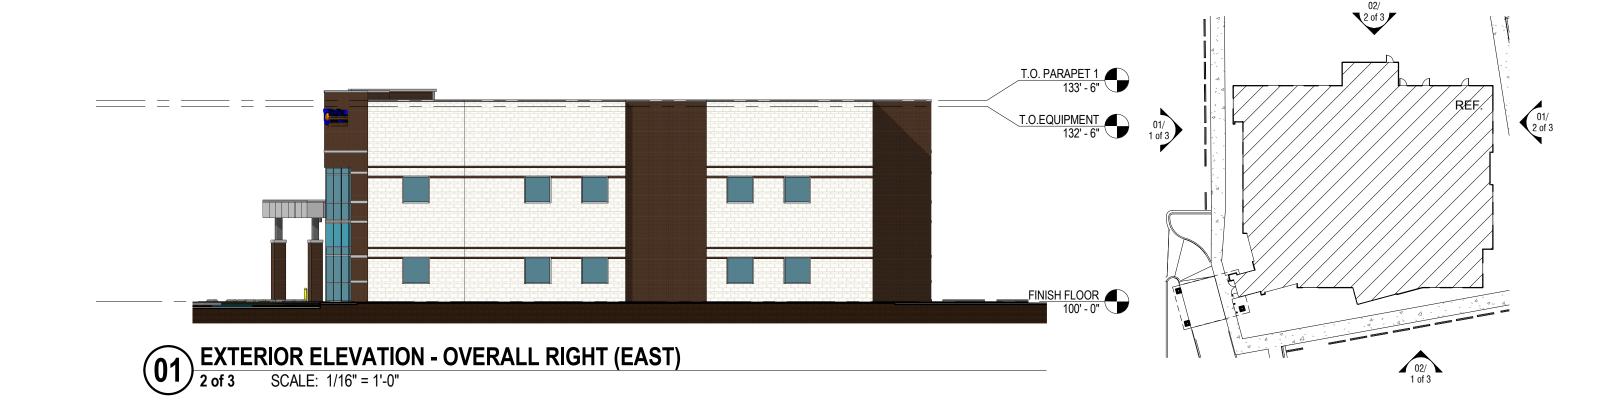

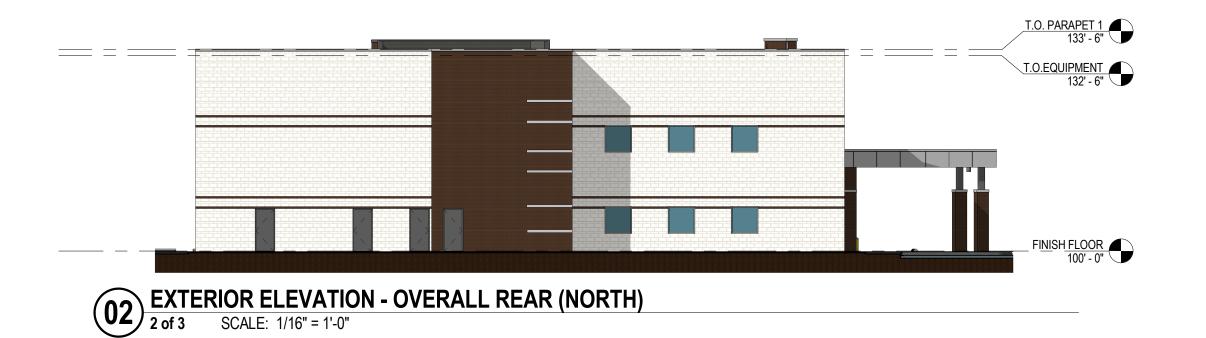

North Elevation	Area(sf) 9	6
Glass	126	3.8%
Brick	828	25.1%
Stone-look Tilt-wall	2,278	69.0%
ACM	71	2.1%
Total	3,303	100.0%
East Elevation	Area(sf) 9	6
Glass	298	10.0%
Brick	882	29.5%
Stone-look Tilt-wall	1,779	59.5%
ACM	30	1.0%
ACIVI	50	2.070

CASE: DS#17-003

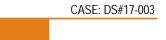



EXHIBIT C - 2 of 3









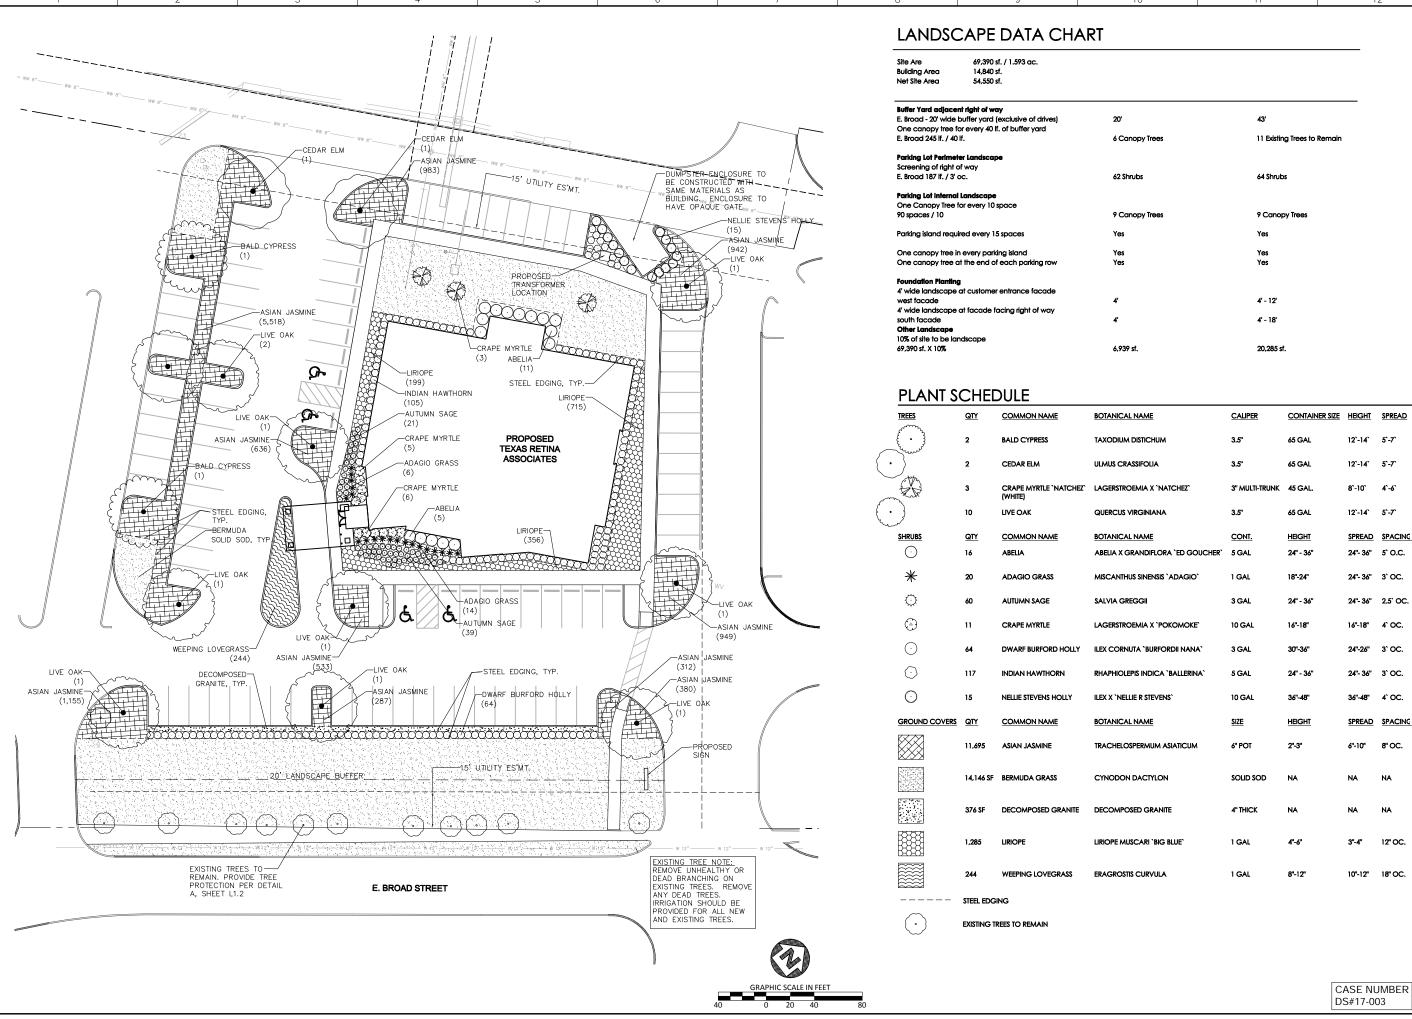

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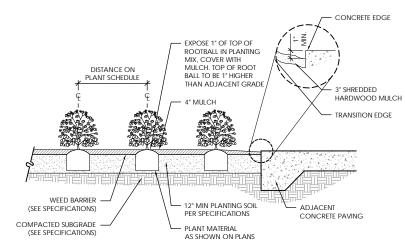
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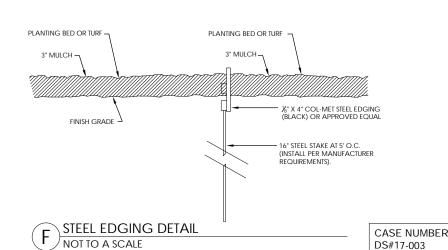
ESIGNED BY CHECKED BY 11/02/2017 SCALE: 1"=40'

PAGE 1 OF 3

WHERE THE TRUNK FLARE IS NOT VISIBLE SHALL BE OP OF ROOT BALL 2" HIGHER THAN GROUNE - 4" - 6" EARTH SAUCER WIDE ROUGHSIDED HOLE CUT AND REMOVE ALL ROPES, BURLAP AND WIRE FROM TOP 1/3 OF ROOTBALL. (BROKEN ROOTBAL WILL CAUSE TREE TO BE REJECTED) PLACE ROOT BALL ON UNEXCAVATED OR TAMPED OMPACTED SURGRADE 2. DO NOT HEAVILY PRUNE THE TREE AT PLANTING 2. DO NOT HEAVILY PRIVILE THE INEE AT PLANTING.
PRUNE ONLY CROSSOVER LIMBS, CO-DOMINANT
LEADERS, AND BROKEN OR DEAD BRANCHES MAY BE
PRUNED; HOWEVER, DO NOT REMOVE THE TURMINAL Multi-trunk tree planting & Staking Detail NOT TO A SCALE



SHRUB PLANTING DETAIL NOT TO A SCALE



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DESIGNED BY CHECKED BY 11/02/2017 CALE: NTS

PAGE 2 OF 3

REFER TO EXISTING CONDITIONS AND DEMOLITION PLAN FOR EXISTING TREES TO REMAIN

SNOW FENCE, ORANGE VINYL CONSTRUCTION FENCE, CHAIN LINK FENCE OR APPROVED EQUAL.

METAL T-POST AT EDGE OF ROOT PROTECTION ZONE

EXISTING GRADE TO REMAIN UNDISTURBED

TREE PROTECTION FENCING DETAIL

A TREE PROTECT

CITY OF MANSFIELD NOTES:

- The dumpster enclosure should be constructed with the same materials used on the building and must be equipped with an opaque gate. Construction details should be provided to demonstrate compliance with this requirement. Screening shrubs are also required around the dumpster enclosure.
- 2. Switch gear devices, electrical transformers and telephone line pedestals located more than five (5) feet from a building, gas meters, and satellite dishes shall be screened by a screening wall or by a hedgerow of dense evergreen shrubbery or plant materials to form a visual screen using plant materials approved by the Landscape Administrator.
- Tree protection will be required. Do not store equipment, materials or park vehicles under existing trees.
 See Chapter 99 (Mansfield Natural Resource Management Ordinance) for additional requirements.
- 4. All landscaping shall be maintained in a healthy and live-growing condition at all times.
- 5. Landscaping Maintenance: The property owner, tenant or agent, shall be responsible for the maintenance of all required landscaping in a healthy, neat, orderly and live-growing condition at all times. This shall include mowing, edging, pruning, fertilizing, irrigation, weeding, and other such activities common to the maintenance of landscaping. Landscaped areas shall be kept free of trash, litter, weeds and other such materials not a part of the landscaping. Plant materials that die shall be replaced with plant materials of similar variety and size.

IO. DATE REVISION DESCRIPTION

EXHIBIT D

DUNAWAY

PUNAWAY

PARA - Sule 400 - Fort Worth, Tend? 78107

The PUNAWAY

PROTECTION EXHIBIT

TEXAS RETINA ASSOCIATES
2925 E. BROAD STREET
MANSFIELD TEXAS

TREE

LANDSCAPE

11/2/2017

DRAWN BY:

DESIGNED BY:

CHECKED BY:

DATE:

11/02/2017


SCALE:

NTS


SHEET:

PAGE 3 OF 3


CASE NUMBER DS#17-003

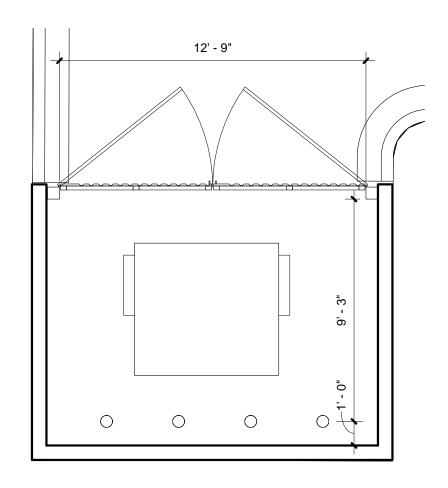




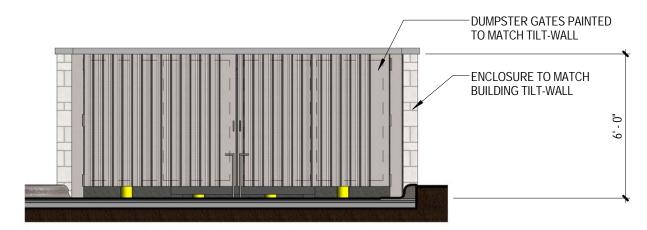

DUMPSTER ENCLOSURE - FRONT SCALE: 1/4" = 1'-0"

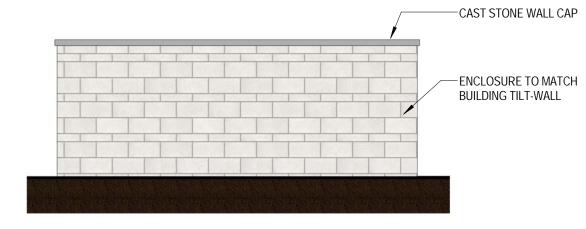

DUMPSTER ENCLOSURE - REAR SCALE: 1/4" = 1'-0"

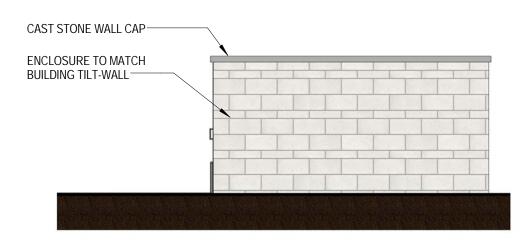



CASE: DS#17-003

ENVIRONMENTS FOR HEALTH ARCHITECTURE