

VICINITY MAP

SITE CALCULATIONS				
	PERMI	TTED	PROV	IDED
TOTAL UNITS (+/-)	275 &	12 TH	287	
1 BEDROOM	N.	4	118	41.1%
2 BEDROOM	N	4	142	49.5%
3 BEDROOM	N.	4	15	5.2%
2 STORY TOWNHOMES	N.	4	12	4.2%
AVERAGE UNIT SIZE	N	4	1,165 SF	
COMMERCIAL/RETAIL	N	Δ.	10,108 SF	
GROSS ACREAGE	N.	4	15.89	ACRES
GROSS DENSITY	N,	4	18.06	UNITS/ACRE
TOTAL ROW DEDICATION (FOR PRIVATE STREETS)	N	4	1.11	ACRES
ROW SOUTH PROPERTY LINE (½ OF 67' ROW FOR MIXED USE PRIVATE STREET)	N	4	0.55	ACRES
ROW WEST PROPERTY LINE (½ OF 62' ROW FOR PRIVATE INTERNAL NEIGHBORHOOD STREET)	N	٩	0.56	ACRES
NET ACREAGE TOTAL	N	4	14.78	ACRES
ACREAGE MULTIFAMILY LOT	N	4	13.51	ACRES
NET DENSITY MULIFAMILY	N	4	21	UNITS/ACRE
OPEN SPACE (ACRES / %)	N	Δ.	6.9 ACRES	±51.2%
HEIGHT (STORIES / FEET)	4	55'-0"	4	<55'
ACREAGE COMMERCIAL LOT	N	4	1.27	ACRES
OPEN SPACE (ACRES / %)	N	4	0.41 ACRES	±32.6%

PARKING CALCULATIONS PARKING REQUIRED				
MULTIFAMILY LOT				
1 BEDROOM	118	118	1.0	00
2 BEDROOM	142	213	1.5	50
3 BEDROOM	15	30	2.0	00
2 STORY TOWNHOMES	12	24	2.0	00
TOTAL		385	1.34	
COMMERCIAL LOT				
RETAIL (±5,608 SF)	1	21	1 PER 250 (FIRST 3000 SF)	1 PER 300 (AFTER 3000)
RESTAURANT (± 4,500 SF)	1	45	1 PER 100 SF	
TOTAL		66		

PARKING PROVIDED				
	SPACES			
CATEGORY	STANDARD	ADA	TOTALS	RATIO
MULTIFAMILY LOT				
RESIDENTIAL STANDARD	396	14	410	
RESIDENTIAL LEASING	11	2	13	
ATTACHED GARAGE	17	1	18	
ATTACHED GARAGE TOWNHOME	24	0	24	
ON-STREET	36	0	36	
TOTAL MULTIFAMILY	484	17	501	1.75
COMMERCIAL LOT	62	4	66	
TOTAL COMMERCIAL	62	4	66	

- DIMENSION SHOWN ARE TO FACE OF CURB UNLESS STATED OTHERWISE.
- EXISTING OFFSITE UTILITIES (ALONG 287 & PROPERTY BOUNDARY) ARE BASED ON SURVEY(S) BY SPOONER & ASSOCIATES AND DATA RECEIVED FROM OTHERS.
- THE PROPOSED SHAPE/SIZE OF REGIONAL DETENTION POND IS PRELIMINARY IN NATURE AND SUBJECT TO MODIFICATION AT FINAL DESIGN PHASE.
- RIGHT-OF-WAY DEDICATION PER OR-2065-17 FOR PRIVATE STREETS.
- ALL FIRE LANES ARE 26-FEET WIDE FACE TO FACE, UNLESS NOTED OTHERWISE. ALL FIRE LANE CURB RADII ARE 28-FEET.
- 6. ALL DRIVE AISLES (NON-FIRE LANES) ARE 24-FEET, FACE TO FACE UNLESS NOTED OTHERWISE. ALL CURB RADII ARE 10-FEET.

DEVELOPMENT PLAN AMENDMENT


FOR

LEASING/ CLUBHOUSE/AMENITY AREA

AREA B TRIKE INVESTORS "PD"

ENTRY/EXIT TO BUILDING

MANSFIELD, JOHNSON COUNTY, TEXAS

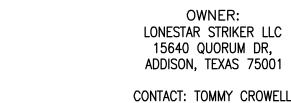



PHONE: (214)-363-1998

BURGESS & NIPLE OWNER: LONESTAR STRIKER LLC

3 SUGAR CREEK CENTER BLVD, STE 610, SUGAR LAND, TEXAS 77478 PHONE: (281) 980 - 7705 TBPE FIRM REGISTRATION NO. F-10834

CONTACT: JOSEPH T. REUE, P.E.

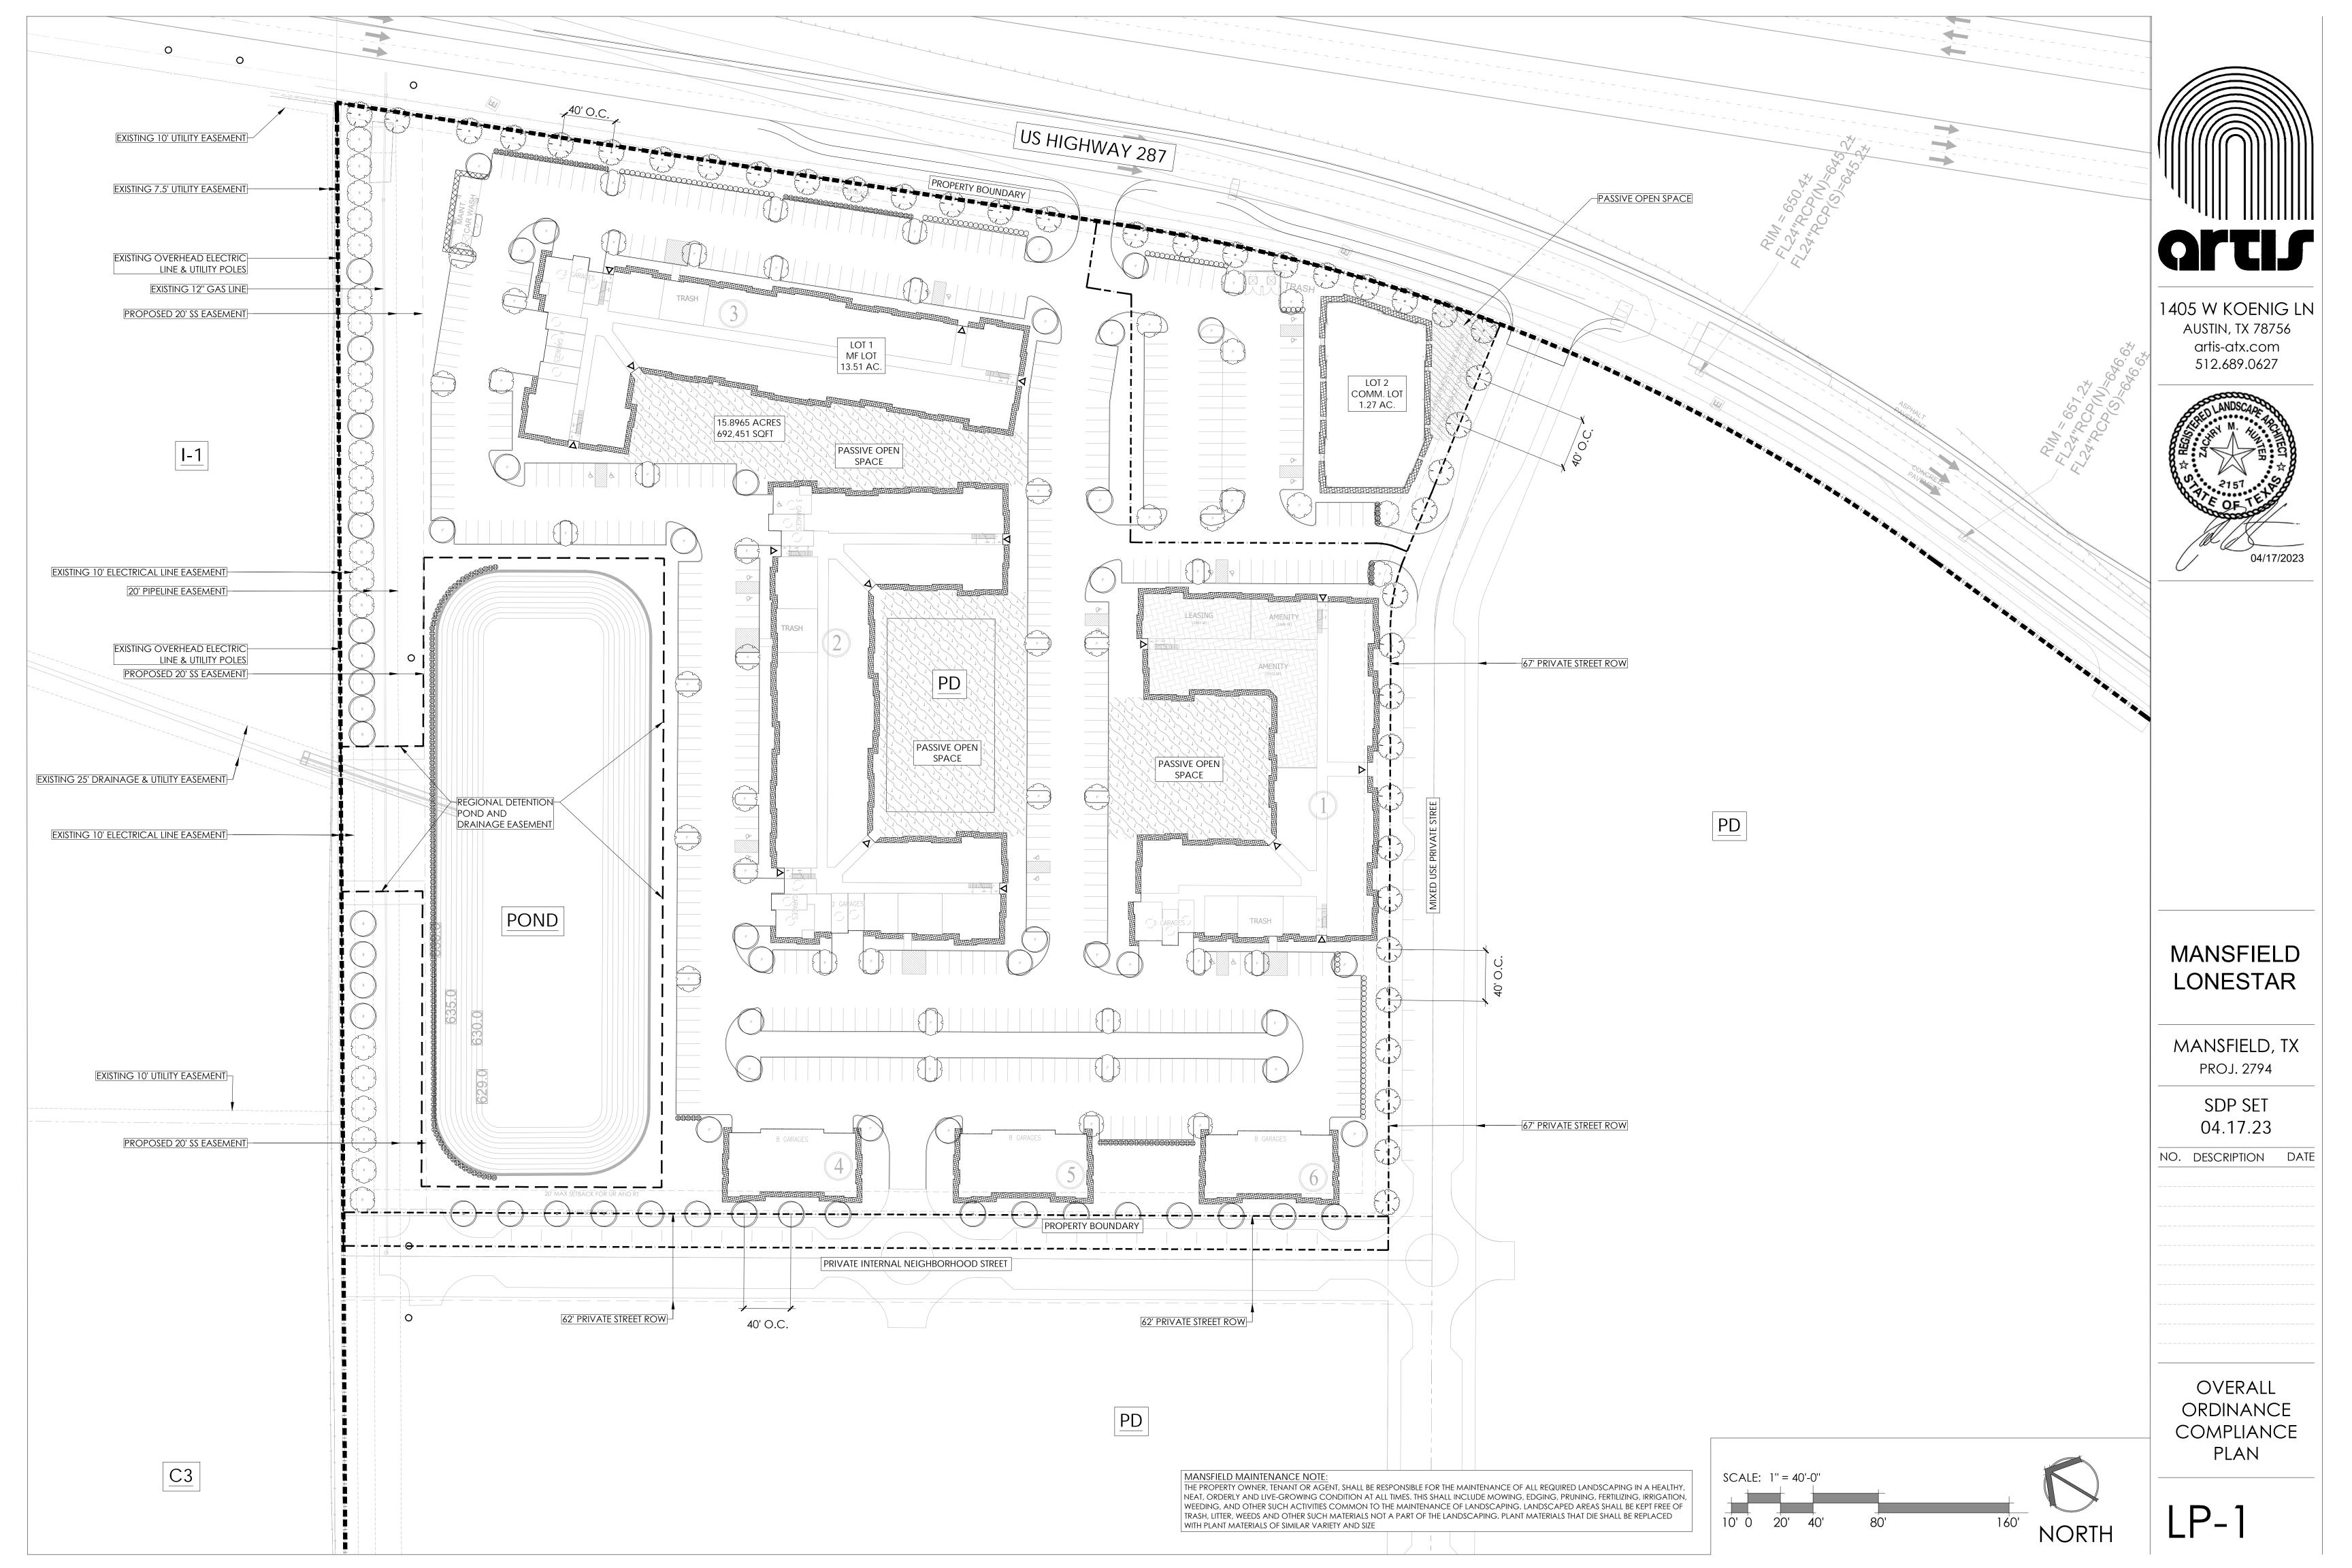

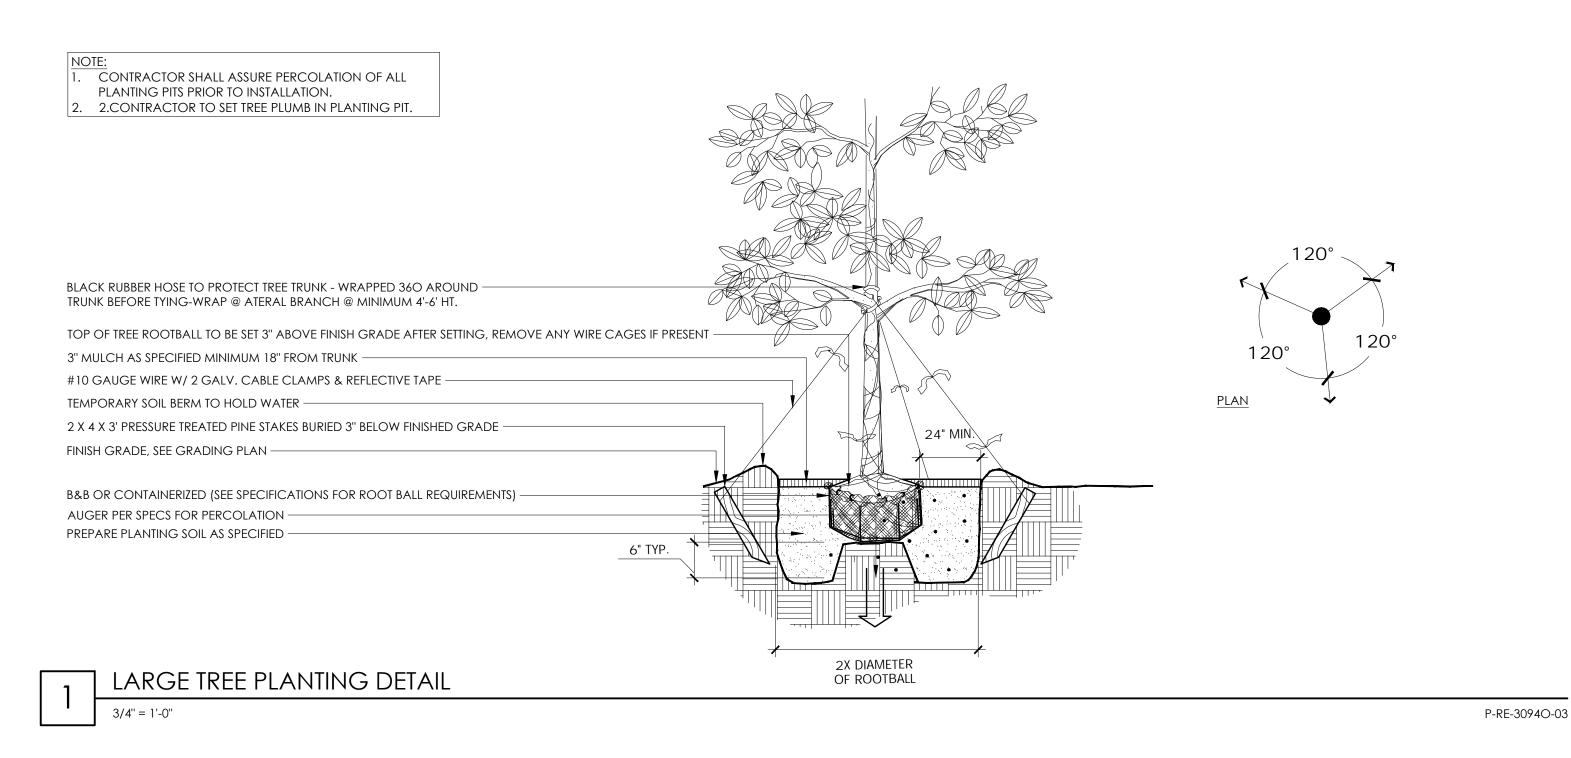

NOTE:

CONTRACTOR SHALL ASSURE PERCOLATION OF ALL PLANTING PITS/BEDS PRIOR TO INSTALLATION

AZALEAS & GARDENIA SHALL BE PLANTED 2" HIGH ABOVE

FINISH GRADE, DO NOT MOUND SOIL ON ROOTBALL

EXCAVATE ENTIRE BED SPECIFIED FOR GROUNDCOVER BED -MINIMUM DEPTH OF 8" APPROVED PLANTING SOIL PER SPECS FOR GROUNDCOVER BED -TEMPORARY SOIL BERM TO HOLD WATER -3" MINIMUM OF MULCH AS SPECIFIED -PLANT MATERIAL SHALL BE PLANTED 2" HIGH WITH -SOIL MOUNDS UP TO THE TOP OF THE ROOT BALL FINISHED GRADE (SEE GRADING PLAN) -PREPARE PLANTING SOIL AS SPECIFIED.WHEN GROUNDCOVERS AND 4" TYP SHRUBS USEDIN MASSES EXCAVATE ENTIRE BED TO RECEIVE APPROVED PLANTING SOIL AND PLANT MATERIAL -EXCEPT WHEN SPECIFIED, SEE PLANT 4" MIN. 2X DIAMETER OF ROOTBALL

SHRUB AND GROUND COVER PLANTING DETAIL

3/4" = 1'-0" P-RE-3094O-02

BUFFER YARD	
LF ALONG I-1 DEVELOPMENT (1 TREE PER 25 LF)	849.5'
REQUIRED BUFFER TREES	34 TREES
PROPOSED BUFFER TREES	34 TREES

PARKING LANDSCAPING	
SURFACE PARKING SPOTS - MULTIFAMILY	459
REQUIRED PARKING TREES (1 CANOPY TREE FOR EVERY 10 SPACES)	46 TREES
PROPOSED PARKING TREES	46+ TREES
SURFACE PARKING SPOTS - COMMERCIAL	66
REQUIRED PARKING TREES (1 CANOPY TREE FOR EVERY 10 SPACES)	7 TREES
PROPOSED PARKING TREES	7+ TREES

441,767 SF
44,177 SF
44,200+ SF
10,102 SF
1,010 SF
1,100+ SF

PLANT SCHEDULE

LIVINI 2CHEDOLE					
BUFFER TREES	CODE	QTY	BOTANICAL / COMMON NAME	CONT	CAL
B	QMB	13	Quercus muehlenbergi / Chinquapin Oak Cal. measured 6" A.F.G. and 7' Ht Min.	·	3" Cc
B c	UCB	21	Ulmus crassifolia / Cedar Elm Cal. measured 6" A.F.G. and 7' Ht Min.		3" Cc
PARKING TREES	CODE	<u>QTY</u>	BOTANICAL / COMMON NAME	CONT	CAL
P	QMP	29	Quercus muehlenbergi / Chinquapin Oak Cal. measured 6" A.F.G. and 7' Ht Min.		3" Cc
P	UCP	46	Ulmus crassifolia / Cedar Elm Cal. measured 6" A.F.G. and 7' Ht Min.		3" Cc
STREET TREES	CODE	<u>QTY</u>	BOTANICAL / COMMON NAME	CONT	CAL
E CONTRACTOR OF THE PARTY OF TH	AG	41	Acer grandidentatum / Big Tooth Maple Cal. measured 6" A.F.G. and 7' Ht Min.		4" Cc
	QM	17	Quercus muehlenbergi / Chinquapin Oak Cal. measured 6" A.F.G. and 7' Ht Min.	٠	4" Cc
SCREENING SHRUB	CODE	<u>QTY</u>	BOTANICAL / COMMON NAME	CONT	
	AGS	216	Abelia grandiflora / Glossy Abelia 3' Ht. Min., and 3' Min. at Maturity	5 gal	
	IB	105	llex burfordii 'nana' / Dwarf Burford Holly 2' Ht. Min., and 3' Min. at Maturity	5 gal	
FOUNDATION PLANTING	CODE	QTY	BOTANICAL / COMMON NAME	CONT	
	RFP	16,098 sf	/ Residential Foundation Planting	-	
	CFP	1,628 sf	/ Commerical Foundation Planting	-	
PASSIVE OPEN SPACE	CODE	QTY	BOTANICAL / COMMON NAME	CONT	
	RPOS	52,973 sf	/ Residential Passive Open Space	-	
	CPOS	3,565 sf	/ Commercial Passive Open Space	-	

NOTES

ORNAMENTAL TREES SHALL HAVE THREE TRUNKS OR CANES WITH A MINIMUM CALIPER OF ONE INCH PER TRUNK AS MEASURED SIX INCHES ABOVE GRADE AT TIME OF PLANTING. ORNAMENTAL TREES SHALL BE SELECTED FROM THE RECOMMENDED PLANT LIST IN THIS SECTION. ORNAMENTAL TREES SHALL HAVE A MINIMUM CROWN SPREAD OF 15 FEET AT MATURITY. ORNAMENTAL TREES HAVING A MATURE CROWN SPREAD OF LESS THAN 15 FEET MAY BE SUBSTITUTED BY GROUPING THE TREES TO CREATE THE EQUIVALENT CROWN SPREAD OF 15

CANOPY TREES SHALL BE A MINIMUM CALIPER OF THREE INCHES AS MEASURED SIX INCHES ABOVE GRADE AND SEVEN FEET IN HEIGHT AT TIME OF PLANTING. CANOPY TREES SHALL BE SELECTED FROM THE RECOMMENDED PLANT LIST IN THIS SECTION.
UNLESS OTHERWISE APPROVED BY THE LANDSCAPE ADMINISTRATOR, TREE PLANTINGS SHALL NOT INCLUDE MORE THAN 50% OF THE SAME TREE SPECIES.

CANOPY TREES SHALL HAVE A MINIMUM CROWN SPREAD OF 25 FEET AT MATURITY
NON-DWARF VARIETY SHRUBS SHALL BE A MINIMUM OF THREE FEET IN HEIGHT MEASURED ABOVE GRADE AT TIME OF PLANTING.
DWARF VARIETY SHRUBS SHALL BE A MINIMUM OF TWO FEET IN HEIGHT MEASURED ABOVE GRADE AT TIME OF PLANTING
PARKING LOT, VEHICULAR USE AND MANEUVERING AREAS MUST BE VISUALLY SCREENED FROM THOROUGHFARES AND CIVIC
SPACES (MINIMUM 3' AT MATURITY)

HEDGES REQUIRED BY THE PROVISIONS OF THIS SECTION SHALL BE PLANTED AND MAINTAINED TO FORM A CONTINUOUS, UNBROKEN, SOLID VISUAL SCREEN OF 3' IN HEIGHT MEASURED ABOVE GRADE WITHIN 18 MONTHS OF PLANTING ALL LANDSCAPED AREAS SHALL BE IRRIGATED IN ACCORDANCE WITH THE REQUIREMENTS OF THIS SECTION. NATURAL AREAS OR AREAS IDENTIFIED AS "NO DISTURBANCE ZONES" NEED NOT BE IRRIGATED

GENERAL MANSFIELD NOTES:

GRASS SEED, SOD AND OTHER MATERIALS SHALL BE CLEAN AND REASONABLY FREE OF WEEDS AND NOXIOUS PESTS AND INSECTS.

THE SOIL SHALL BE PREPARED IN A MANNER CONSISTENT WITH ACCEPTED PLANTING PROCEDURES PRIOR TO THE INSTALLATION OF SOD,
GRASS SEED OR OTHER MATERIALS.

IN THE MF-1, MF-2, OP, C-1, C-2, C-3, D, S, I-1, I-2, FR, SE, AND PD DISTRICTS, PLASTIC, RUBBER OR NON-DURABLE EDGING SHALL BE PROHIBITED. CONCRETE, METAL, AND OTHER DURABLE EDGING SHALL BE PROVIDED BETWEEN PLANTING BEDS AND OTHER LANDSCAPED AREAS.

WHERE TREES ARE NOT ABLE TO STAND ON THEIR OWN, TREES SHALL BE STAKED WITH AN AT GRADE ROOT BALL SECURING SYSTEM. THE SYSTEM SHALL SECURELY ANCHOR THE ROOT BALL, WHILE ALLOWING THE TRUNK AND CROWN TO MOVE NATURALLY. THE SYSTEM SHALL NOT USE MATERIALS AND METHODS THAT PENETRATE OR DAMAGE THE ROOT BALL. GRADE ROOT BALL SECURING SYSTEMS MUST BE REMOVED AFTER ONE GROWING SEASON. ABOVE GRADE STAKING SYSTEMS SUCH AS "T" POSTS WITH WIRES, HOSES, STRAPS, OR GUY WIRES WRAPPED AROUND THE TREE TRUNK, SHALL NOT BE ALLOWED UNLESS AUTHORIZED BY THE LANDSCAPE ADMINISTRATOR FOR MATURE TREES OVERHANGING OR ADJACENT TO STREETS, FIRE LANES OR OTHER ACCESS WAYS, A MINIMUM 14 FOOT VERTICAL CLEARANCE SHALL BE MAINTAINED FOR MATURE TREES OVERHANGING OR ADJACENT TO WALKWAYS AND PATHS, A MINIMUM 9' VERTICAL CLEARANCE SHALL BE


MAINTAINED.

MANSFIELD MAINTENANCE NOTE:

THE PROPERTY OWNER, TENANT OR AGENT, SHALL BE RESPONSIBLE FOR THE MAINTENANCE OF ALL REQUIRED LANDSCAPING IN A HEALTHY, NEAT, ORDERLY AND LIVE-GROWING CONDITION AT ALL TIMES. THIS SHALL INCLUDE MOWING, EDGING, PRUNING, FERTILIZING, IRRIGATION, WEEDING, AND OTHER SUCH ACTIVITIES COMMON TO THE MAINTENANCE OF LANDSCAPING. LANDSCAPED AREAS SHALL BE KEPT FREE OF TRASH, LITTER, WEEDS AND OTHER SUCH MATERIALS NOT A PART OF THE LANDSCAPING. PLANT MATERIALS THAT DIE SHALL BE REPLACED WITH PLANT MATERIALS OF SIMILAR VARIETY AND SIZE



1405 W KOENIG LN AUSTIN, TX 78756 artis-atx.com 512.689.0627

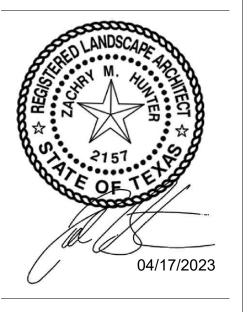

MANSFIELD LONESTAR

MANSFIELD, TX PROJ. 2794

> SDP SET 04.17.23

NO. DESCRIPTION DATE

ORDINANCE
CALCULATIONS &
SCHEDULE

LP-2





BUILDING 1000 - EAST ELEVATION SCALE: 3/32" = 1'-0"

GEHEBER

ASSOCIATES ARCHITECTURE

1325 LOGAN CIRCLE NW. ATLANTA, GA 30318 T: 404.228.1958 F: 404.228.8350

LEWIS

Davis Development

PROJECT:

CLIENT:

Mansfield Lonestar

DRAWING TITLE:


Preliminary Rendering

DRAWN BY:

Brian Tomlin

03/20/2023 **AS NOTED** PROJECT NUMBER: 23005

#Project Status

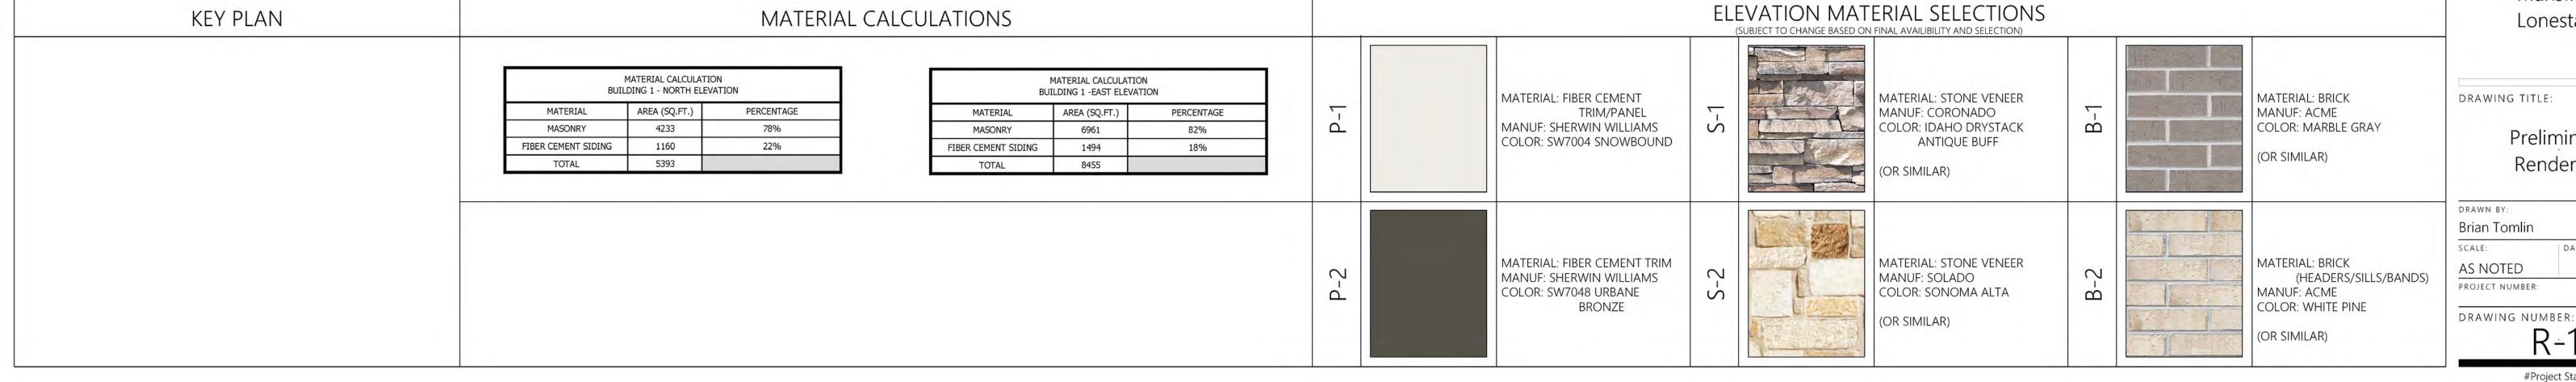





BUILDING 1000 - WEST ELEVATION SCALE: 3/32" = 1'-0"

CLIENT:

Davis Development

GEHEBER

ASSOCIATES ARCHITECTURE

1325 LOGAN CIRCLE NW. ATLANTA, GA 30318

T: 404.228.1958 F: 404.228.8350

LEWIS

PROJECT:

Mansfield Lonestar

DRAWING TITLE:

Preliminary Rendering

DRAWN BY:

03/20/2023 PROJECT NUMBER: 23005

DRAWING NUMBER:

#Project Status

ELEVATION MATERIAL SELECTIONS **KEY PLAN** MATERIAL CALCULATIONS MATERIAL CALCULATION BUILDING 1 - SOUTH ELEVATION MATERIAL CALCULATION BUILDING 1 - WEST ELEVATION MATERIAL: FIBER CEMENT MATERIAL: STONE VENEER MATERIAL: BRICK P-1 B-1 MATERIAL AREA (SQ.FT.) PERCENTAGE MATERIAL AREA (SQ.FT.) PERCENTAGE TRIM/PANEL MANUF: CORONADO MANUF: ACME COLOR: MARBLE GRAY MANUF: SHERWIN WILLIAMS COLOR: IDAHO DRYSTACK 6770 MASONRY 5172 78% MASONRY 74% COLOR: SW7004 SNOWBOUND ANTIQUE BUFF FIBER CEMENT SIDING 1449 22% FIBER CEMENT SIDING 2412 26% (OR SIMILAR) 6621 9182 TOTAL TOTAL OR SIMILAR) Brian Tomlin SCALE: MATERIAL: FIBER CEMENT TRIM MATERIAL: STONE VENEER MATERIAL: BRICK AS NOTED P-2 2 (HEADERS/SILLS/BANDS) MANUF: SHERWIN WILLIAMS COLOR: SW7048 URBANE MANUF: SOLADO COLOR: SONOMA ALTA ė MANUF: ACME S **BRONZE** COLOR: WHITE PINE (OR SIMILAR) (OR SIMILAR)









1325 LOGAN CIRCLE NW. ATLANTA, GA 30318 T: 404.228.1958 | F: 404.228.8350





BUILDING 3000 - EAST ELEVATION SCALE: 3/32" = 1'-0"

> Davis Development

PROJECT:

CLIENT:

Mansfield Lonestar

DRAWING TITLE:

Preliminary

Rendering

DRAWN BY:

Brian Tomlin

03/20/2023 AS NOTED PROJECT NUMBER: 23005

DRAWING NUMBER:

#Project Status

ELEVATION MATERIAL SELECTIONS **KEY PLAN** MATERIAL CALCULATIONS MATERIAL CALCULATION MATERIAL CALCULATION BUILDING 3 - EAST ELEVATION **BUILDING 3 - NORTH ELEVATION** MATERIAL: FIBER CEMENT MATERIAL: BRICK MATERIAL: STONE VENEER AREA (SQ.FT.) PERCENTAGE _ B-1 MANUF: CORONADO COLOR: IDAHO DRYSTACK MATERIAL AREA (SQ.FT.) PERCENTAGE TRIM/PANEL MANUF: ACME COLOR: MARBLE GRAY MASONRY 3557 74% Δ MANUF: SHERWIN WILLIAMS 82% COLOR: SW7004 SNOWBOUND ANTIQUE BUFF FIBER CEMENT SIDING 1243 26% FIBER CEMENT SIDING 2311 18% (OR SIMILAR) TOTAL 4800 TOTAL 13126 OR SIMILAR) MATERIAL: FIBER CEMENT TRIM MATERIAL: STONE VENEER MATERIAL: BRICK P-2 2 (HEADERS/SILLS/BANDS) MANUF: SHERWIN WILLIAMS MANUF: SOLADO COLOR: SW7048 URBANE COLOR: SONOMA ALTA ė MANUF: ACME S **BRONZE** COLOR: WHITE PINE (OR SIMILAR) (OR SIMILAR)





1325 LOGAN CIRCLE NW. ATLANTA, GA 30318 T: 404.228.1958 | F: 404.228.8350





BUILDING 2000 - WEST ELEVATION

P-2

SCALE: 3/32" = 1'-0"

Davis Development

PROJECT:

Mansfie
Lonesta

DRAWING TITLE:

Preliminary Rendering

DRAWN BY: Brian Tomlin

SCALE: 03/20/2023 **AS NOTED**

PROJECT NUMBER: 23005 DRAWING NUMBER:

KEY PLAN MATERIAL CALCULATIONS MATERIAL CALCULATION BUILDING 3 - SOUTH ELEVATION MATERIAL CALCULATION BUILDING 3 - WEST ELEVATION **PERCENTAGE** MATERIAL AREA (SQ.FT.) **MATERIAL** AREA (SQ.FT.) PERCENTAGE 3735 81% MASONRY 80% MASONRY FIBER CEMENT SIDING 2422 20% FIBER CEMENT SIDING 885 19% 12195 4620 TOTAL

MATERIAL: FIBER CEMENT TRIM/PANEL Ь-MANUF: SHERWIN WILLIAMS COLOR: SW7004 SNOWBOUND

S

MATERIAL: FIBER CEMENT TRIM

BRONZE

MANUF: SHERWIN WILLIAMS COLOR: SW7048 URBANE

MANUF: CORONADO COLOR: IDAHO DRYSTACK ANTIQUE BUFF OR SIMILAR)

(OR SIMILAR)

ELEVATION MATERIAL SELECTIONS

MATERIAL: STONE VENEER

MATERIAL: STONE VENEER

3 MANUF: SOLADO COLOR: SONOMA ALTA ė

B-1

MATERIAL: BRICK MANUF: ACME COLOR: WHITE PINE

(HEADERS/SILLS/BANDS) (OR SIMILAR)

MATERIAL: BRICK

COLOR: MARBLE GRAY

MANUF: ACME

(OR SIMILAR)

#Project Status



FINISH	DESCRIPTION	LOCATION	COLOR / MANUF.	NOTES
KEY				
ST-1	3-STEP STUCCO	EXTERIOR WALLS	S.W. 7010 WHITE DUCK	
ST-2	3-STEP STUCCO	REF ELEVATIONS	S.W. 6107 NOMADIC DESERT	
S-1	NATURAL THIN STONE VENEER	EXTERIOR WALLS		
S-2	STACK STONE - NANTUCKET	EXTERIOR WALLS	EL DORADO	
EIFS	EIFS	PARAPET	S.W. 7027 HICKORY SMOKE	
STF-1	ALUMINUM STOREFRONT	ALL TENANT SPACES	CLEAR ALUMINUM	
MTL-1	METAL AWNING	PAC-CLAD	MUSKET GRAY	
MTL-2	METAL AWNING	VARIOUS LOCATIONS	SILVER	

SHEET NOTES

UTILITY BOXES AND CONDUIT TO BE PAINTED TO MATCH
ADJACENT BUILDING MATERIAL

MECHANICAL UNITS SHALL BE SCREENED IN

ACCORDANCE WITH ZONING ORDINANCES

DEPARTMENT APPROVAL

ALL SIGNAGE SUBJECT TO BUILDING INSPECTION

© 2022 NCA PARTNERS, INC. ALL RIGHTS RESERVED. THESE PLANS HEREIN ARE THE PROPERTY OF NCA PARTNERS, INC. AND ARE PROTECTED UNDER APPLICABLE COPYRIGHT LAWS.

5646 MILTON ST. SUITE 610 DALLAS, TX 75206 214.361.9901 214.361.9906 FAX ncapartners.com

MANSFIELD RETAIL


\setminus	DATE	DESCRIPTION
	4-5-2023	OWNER REVIEW
	4-13-2023	CITY SUBMITTAL


PRELIMINARY
THIS DOCUMENT SHALL NOT BE
USED FOR REGULATORY
APPROVAL, PERMIT, OR
CONSTRUCTION. RELEASED
UNDER THE AUTHORITY OF
NICHOLAS K. CADE, TBAE
LICENSE #9301

NCA JOB #: 23010

COLOR ELEVATIONS


A3.00

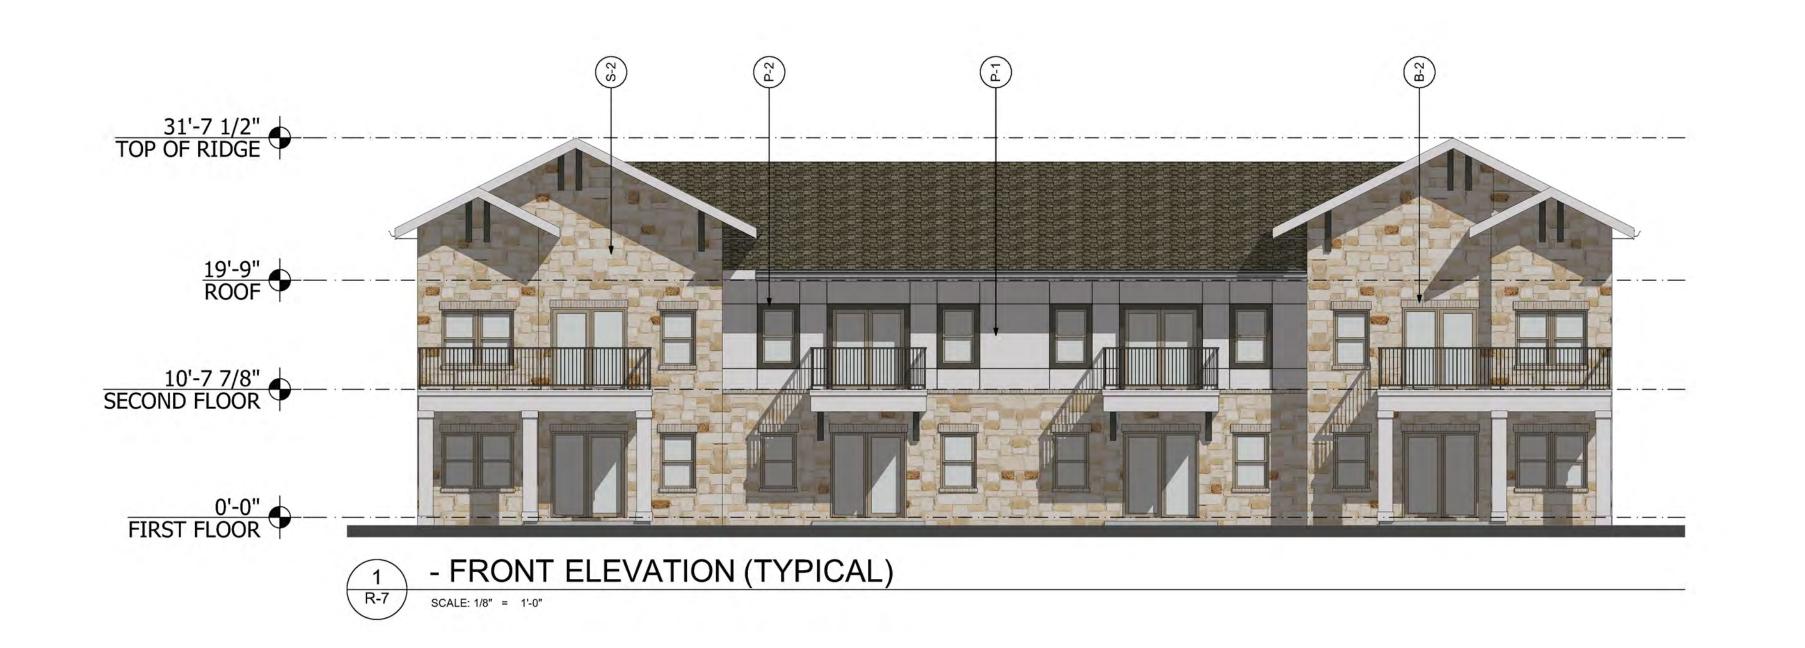


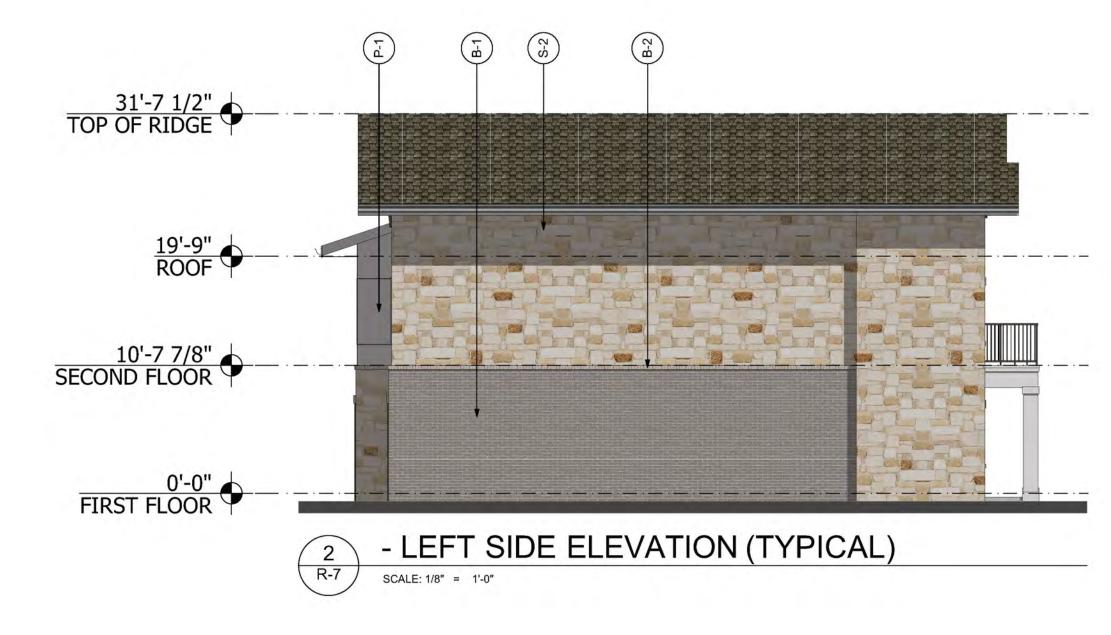



1325 LOGAN CIRCLE NW. ATLANTA, GA 30318 T: 404.228.1958 | F: 404.228.8350

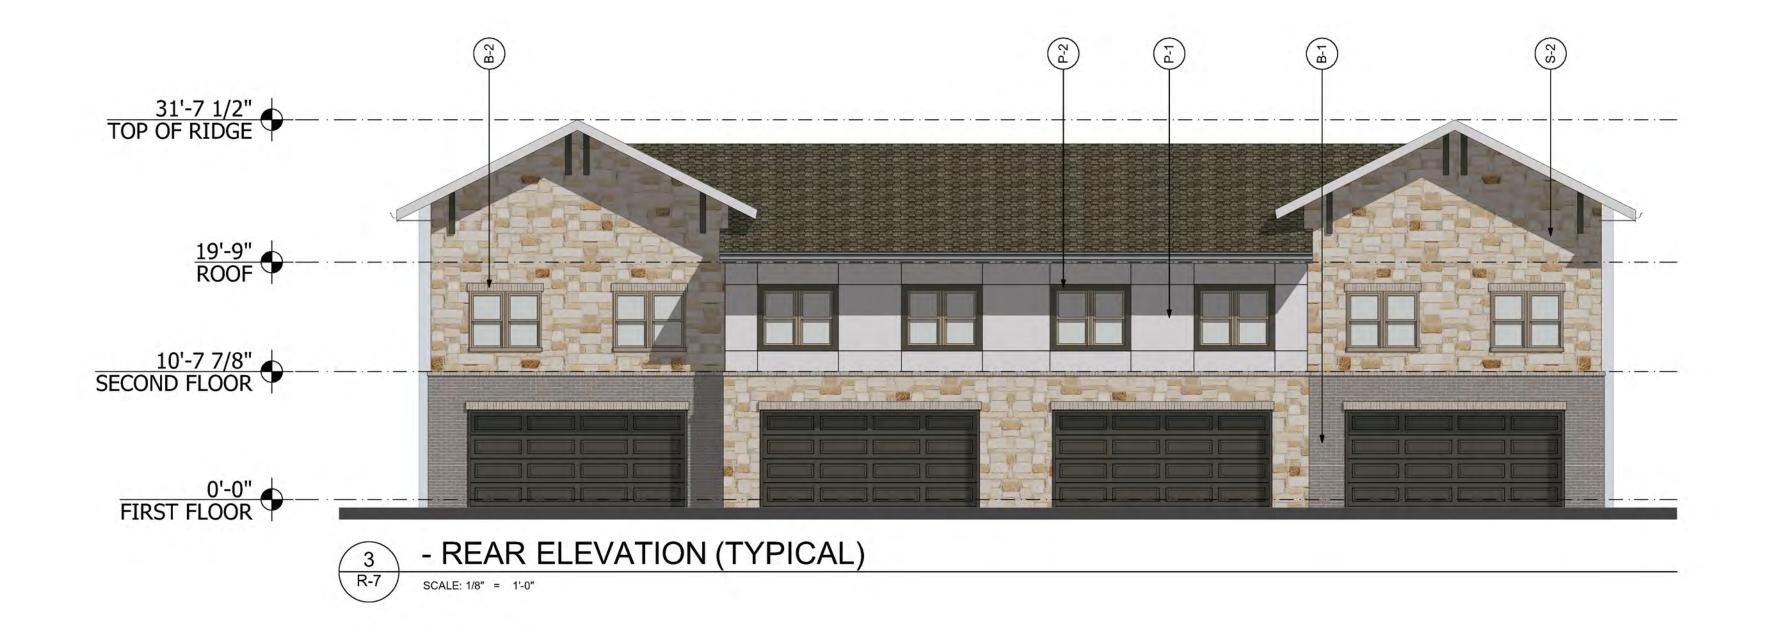

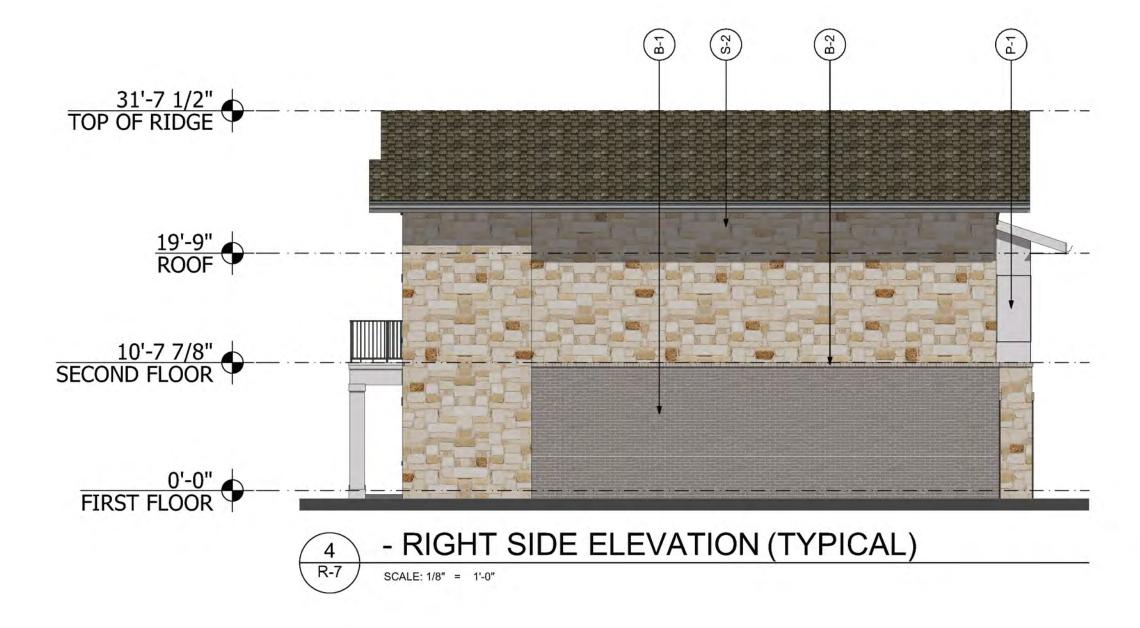

CLIENT:

Davis Development

PROJECT:

Mansfield Lonestar

DRAWING TITLE:

Preliminary

Rendering

DRAWN BY: Brian Tomlin SCALE:

DATE: 03/20/2023 **AS NOTED** PROJECT NUMBER: 23005

DRAWING NUMBER:

#Project Status

KEY PLAN MATERIAL CALCULATIONS MATERIAL CALCULATION BUILDING 4 - LEFT ELEVATION MATERIAL CALCULATION **BUILDING 4 - FRONT ELEVATION** MATERIAL AREA (SQ.FT.) PERCENTAGE **MATERIAL** AREA (SQ.FT.) MASONRY 1611 75% MASONRY 1260 98% FIBER CEMENT SIDING 532 25% 2% FIBER CEMENT SIDING 20 2143 1280 TOTAL TOTAL

> MATERIAL CALCULATION **BUILDING 4- REAR ELEVATION** AREA (SQ.FT.) PERCENTAGE MATERIAL MASONRY 82% 1451 FIBER CEMENT SIDING 324 18% 1775 TOTAL

PERCENTAGE

MATERIAL CALCULATION **BUILDING 4 - RIGHT ELEVATION** AREA (SQ.FT.) PERCENTAGE MATERIAL 1260 98% MASONRY FIBER CEMENT SIDING 20 2% 1280 TOTAL

MATERIAL: FIBER CEMENT TRIM MANUF: SHERWIN WILLIAMS COLOR: SW7048 URBANE S **BRONZE**

TRIM/PANEL

MATERIAL: FIBER CEMENT

MANUF: SHERWIN WILLIAMS

COLOR: SW7004 SNOWBOUND

4

2

4

MATERIAL: STONE VENEER MANUF: SOLADO COLOR: SONOMA ALTA (OR SIMILAR)

ELEVATION MATERIAL SELECTIONS

MATERIAL: STONE VENEER

COLOR: IDAHO DRYSTACK

ANTIQUE BUFF

MANUF: CORONADO

OR SIMILAR)

2 ė

B-1

MATERIAL: BRICK (HEADERS/SILLS/BANDS) MANUF: ACME COLOR: WHITE PINE (OR SIMILAR)

MATERIAL: BRICK

COLOR: MARBLE GRAY

MANUF: ACME

(OR SIMILAR)