

01 NORTH ELEVATION
SCALE: 3/32" = 1'-0"

BRICK - FIELD 01 BRICK - FIELD 02 BRICK - FIELD 03 CEMENTITIOUS PANEL SIDING

01.1 04 06.2 01.2

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T.O. PARAPET 43'-4 7/8"

136' 4 7/8" T.O. PLATE

T.O.D. UL3

T.O. CONC. 100' - 0"

MATERIAL / FENESTRATION PERCENTAGES

GLASS/WINDOW/DOOR

CASE NUMBER _SUP #21 - 001 HENSLEY LAMKIN RACHEL, INC. 14881 QUORUM DR#550 DALLAS,TX-75254 CONTACT PERSON -JUAN TORRES

(sr.proj manager) EMAIL - juan@hlrinc.net

BRUCE W. RACHEL, AIA TX LICENCE NO. 14373 PRELIMINARY DRAWING NOT FOR CONSTRUCTION


Project Title:

NAHVI ROAD

EXHIBIT C

MANSFIELD,TX.


PAGE 1 OF 15

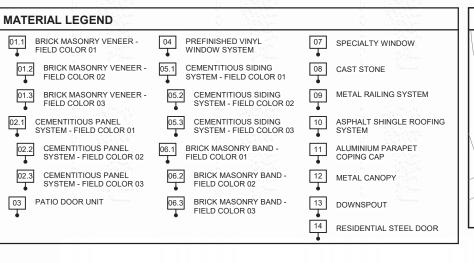

BUILDING TOTAL: MATERIAL / FENESTRATION PERCENTAGES

BRICK - FIELD 01 BRICK - FIELD 02 BRICK - FIELD 03 CEMENTITIOUS PANEL SIDING

74.6% 58.6% 11.2% 4.8% 19.1% 6.3%

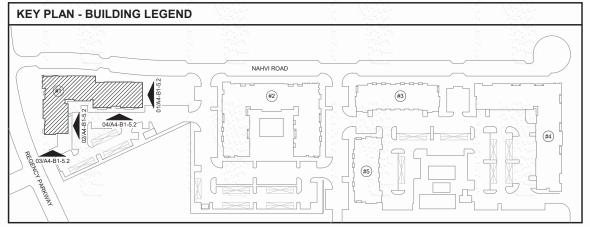


ROOF MOUNTED EQUIPMENT SCREEN NOTE: All roof-mounted equipment shall be fully screened by building parapets at least 1' taller than the tallest piece of equipment on all facades facing public or private streets. All roof-mounted equipment shall be fully screened by a guardrail screening system painted to match the roof at least 1' taller than the tallest piece of equipment on all other facades. (Ref. to Page 12 of 15 for additional details)



GLASS/WINDOW/DOOR 02.1 05.1 10 T.O.P. UL3 122' - 3 3/4" T.O.P. UL2 120'-9" T.O.P. UL1 T.O. CONC. 100' - 0"

02 EAST ELEVATION 01
SCALE: 3/32" = 1'-0"

MATERIAL / FENESTRATION PERCENTAGES WALLS BRICK BRICK - FIELD 01 BRICK - FIELD 02 BRICK - FIELD 03 CEMENTITIOUS PANEL SIDING

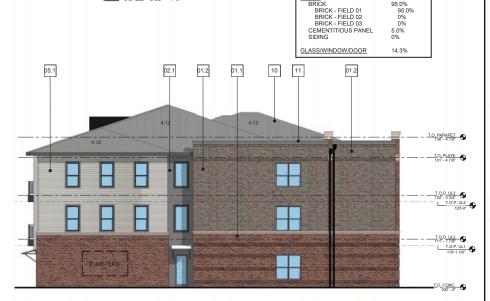

01 EAST ELEVATION 02

MATERIAL / FENESTRATION PERCENTAGES WALLS BRICK BRICK - FIELD 01 BRICK - FIELD 02 BRICK - FIELD 03 CEMENTITIOUS PANEL SIDING

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(sr.proj manager) EMAIL - juan@hlrinc.net



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MANSFIELD,TX.

Project ID: #20410

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HLR ARCHITECTS

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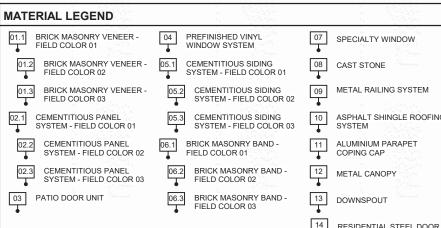
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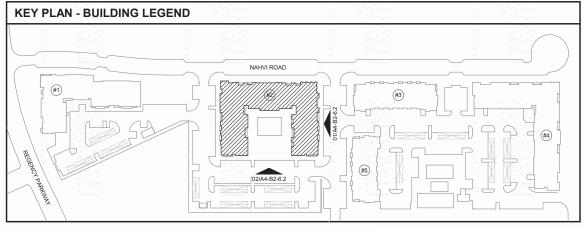
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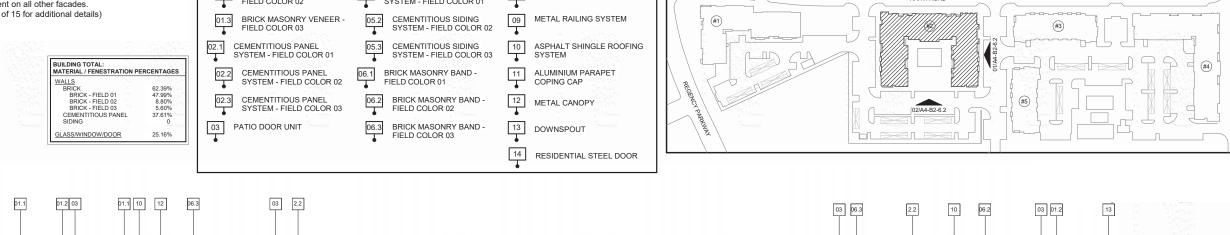
Sheet No

PAGE 3 OF 15

All roof-mounted equipment shall be fully screened by building parapets at least 1' taller than the tallest piece of equipment on all facades facing public or private streets. All roof-mounted equipment shall be fully screened by a quardrail screening system painted to match the roof at least 1' taller than the tallest piece of equipment on all other facades. (Ref. to Page 12 of 15 for additional details)











MATERIAL / FENESTRATION PERCENTAGES WALLS
BRICK
BRICK - FIELD 01
BRICK - FIELD 02
BRICK - FIELD 03
CEMENTITIOUS PANEL 78.0% 53.8% 13.9% 10.3% 22.0%

GLASS/WINDOW/DOOR

CASE NUMBER _SUP #21 - 001 HENSLEY LAMKIN RACHEL. INC. 14881 QUORUM DR#550 DALLAS,TX-75254 CONTACT PERSON -JUAN TORRES (sr.proj manager) EMAIL - juan@hlrinc.net



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(Ref. to Page 12 of 15 for additional details)


BUILDING TOTAL: MATERIAL / FENESTRATION P	ERCENTAGES
WALLS BRICK - FIELD 01 BRICK - FIELD 02 BRICK - FIELD 03 CEMENTITIOUS PANEL SIDING	62.39% 47.99% 8.80% 5.60% 37.61%
GLASS/WINDOW/DOOR	25.16%

MATERIAL LEGEND BRICK MASONRY VENEER -04 PREFINISHED VINYL 07 SPECIALTY WINDOW WINDOW SYSTEM FIELD COLOR 01 05.1 BRICK MASONRY VENEER -CEMENTITIOUS SIDING 08 CAST STONE FIELD COLOR 02 SYSTEM - FIELD COLOR 01 BRICK MASONRY VENEER -CEMENTITIOUS SIDING METAL RAILING SYSTEM 05.2 FIELD COLOR 03 SYSTEM - FIELD COLOR 02 02.1 CEMENTITIOUS PANEL SYSTEM - FIELD COLOR 01 CEMENTITIOUS SIDING SYSTEM - FIELD COLOR 03 ASPHALT SHINGLE ROOFING SYSTEM 02.2 CEMENTITIOUS PANEL BRICK MASONRY BAND -ALUMINIUM PARAPET SYSTEM - FIELD COLOR 02 FIELD COLOR 01 COPING CAP 12 METAL CANOPY CEMENTITIOUS PANEL BRICK MASONRY BAND -SYSTEM - FIELD COLOR 03 FIELD COLOR 02 PATIO DOOR UNIT BRICK MASONRY BAND -FIELD COLOR 03 13 DOWNSPOUT

14

02.1

03

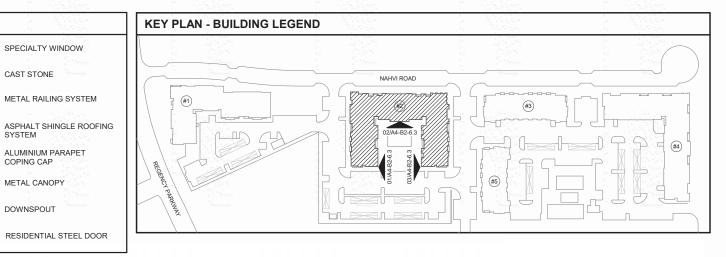


2.2

02.1

10



03 WEST ELEVATION 03
SCALE: 3/32" = 1'-0"

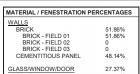



01 EAST ELEVATION 01
SCALE: 3/32" = 1'-0"

 MATERIAL / FENESTRATION PERCENTAGES

 WALLS
 BRICK
 51.86%

 BRICK - FIELD 01
 51.86%

 BRICK - FIELD 02
 0

 BRICK - FIELD 03
 0

 CEMENTITIOUS PANEL
 48.14%

27.37%

CASE NUMBER_SUP #21 - 001
HENSLEY LAMKIN RACHEL, INC.
14881 QUORUM DR#550
DALAS TX-75254
CONTACT PERSON -JUAN TORRES
(sr.proj manager)
EMAIL - Juan@hinc.net



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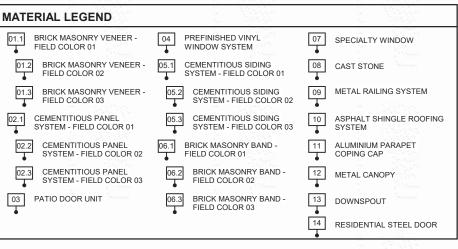
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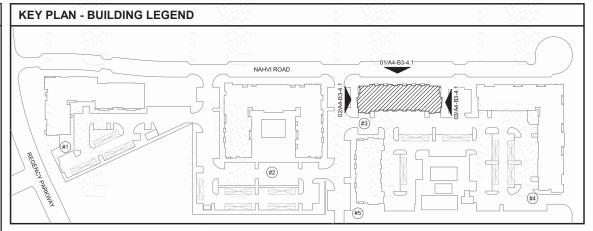
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03 EAST ELEVATION
SCALE: 3/32" = 1'-0"

MATERIAL / FENESTRATION PERCENTAGES WALLS BRICK BRICK - FIELD 01 BRICK - FIELD 02 CEMENTITIOUS PANEL SIDING 22.5%



MATERIAL / FENESTRATION PERCENTAGES WALLS BRICK BRICK - FIELD 01 BRICK - FIELD 02 CEMENTITIOUS PANEL SIDING 8.6% 6.9%



01 NORTH ELEVATION
SCALE: 3/32" = 1'-0"

02 WEST ELEVATION
SCALE: 3/32" = 1'-0"

ATERIAL / FENESTRATION PERCENTAGES				
/ALLS	Total Control			
BRICK	77.2%			
BRICK - FIELD 01	69.7%			
BRICK - FIELD 02	7.4%			
CEMENTITIOUS PANEL	22.8%			
SIDING	0.0%			
	1 47 25 200			
LASS/WINDOW/DOOR	24.7%			



BUILDING TOTAL: MATERIAL / FENESTRATION PERCENTAGES

HENSLEY LAMKIN RACHEL, INC. DALLAS,TX-75254 CONTACT PERSON -JUAN TORRES (sr.proj manager) EMAIL - juan@hlrinc.net



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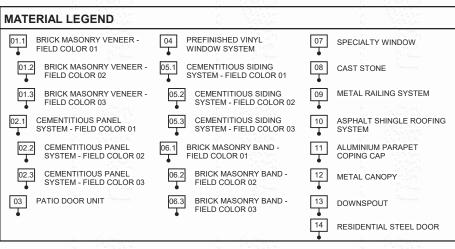
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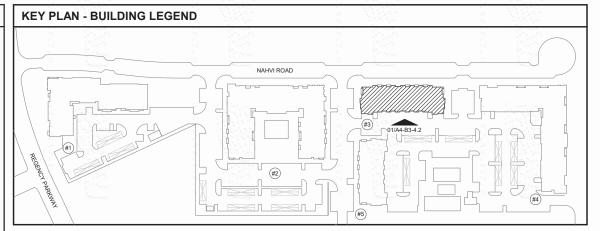
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#20410

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WALLS BRICK	65.4%
BRICK - FIELD 01	51.7%
BRICK - FIELD 02	13.7%
CEMENTITIOUS PANEL	15.9%
SIDING	18.7%
GLASS/WINDOW/DOOR	22.5%



South elevation
SCALE: 3/32" = 1'-0"

MATERIAL / FENESTRATION	PERCENTAGES
WALLS	
BRICK	34.6%
BRICK - FIELD 01	28.2%
BRICK - FIELD 02	6.4%
CEMENTITIOUS PANEL	23.9%
SIDING	41.5%
GLASS/WINDOW/DOOR	19.7%



CASE NUMBER _SUP #21 - 001

HENSLEY LAMKIN RACHEL, INC. 14881 QUORUM DR#550 DALLAS,TX-75254 CONTACT PERSON -JUAN TORRES (sr.proj manager) EMAIL - juan@hlrinc.net



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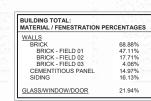
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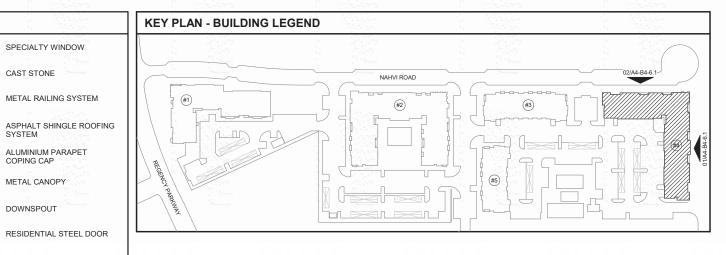
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01 EAST ELEVATION
SCALE: 3/32" = 1'-0"

14







87.7% 63.5% 18.1% 6.1% 12.3%

26.6%

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DALLAS,TX-75254 CONTACT PERSON -JUAN TORRES (sr.proj manager) EMAIL - juan@hlrinc.net

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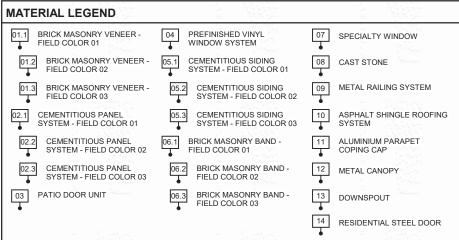
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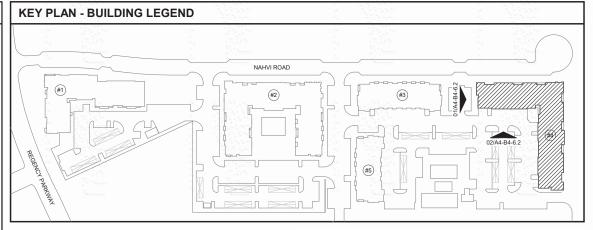
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ROOF MOUNTED EQUIPMENT SCREEN NOTE: All roof-mounted equipment shall be fully screened by building parapets at least 1' taller than the tallest piece of equipment on all facades facing public or private streets. All roof-mounted equipment shall be fully screened by a guardrail screening system painted to match the roof at least 1' taller than the tallest piece of equipment on all other facades. (Ref. to Page 12 of 15 for additional details)



01.1 06.3 10 01.2 01.2 12 T.O. PARAPET 148' - 0 3/4" T.O.P. UL3 TOD UL3 T.O.D. UL2 111' - 7 7/8"

	100
32.33%	100
26.40%	15
5.93%	
0%	100
20.79%	19
46.88%	P.5
	100
25.56%	15
	26.40% 5.93% 0% 20.79% 46.88%

MATERIAL / FENESTRATION PERCENTAGES

1 WEST ELEVATION-1
SCALE: 3/32" = 1'-0"

MATERIAL / FENESTRATION PE	RCENTAGES
WALLS	
BRICK	82.94%
BRICK - FIELD 01	53.12%
BRICK - FIELD 02	29.82%
BRICK - FIELD 03	0%
CEMENTITIOUS PANEL	17.06%
SIDING	0%
GLASS/WINDOW/DOOR	14.52%



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2 SOUTH ELEVATION-1 SCALE: 3/32" = 1'-0"

BUILDING TOTAL: MATERIAL / FENESTRATION PERCENTAGES


68.88% 47.11% 17.71% 4.06% 14.97% 16.13%


21.94%

WALLS
BRICK
BRICK - FIELD 01
BRICK - FIELD 02
BRICK - FIELD 03

CEMENTITIOUS PANEL SIDING

WALLS
BRICK - FIELD
BRICK - FIELD
BRICK - FIELD
CEMENTITIOUS P
SIDING

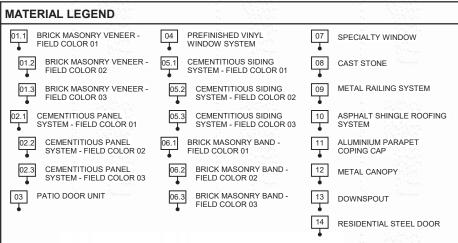

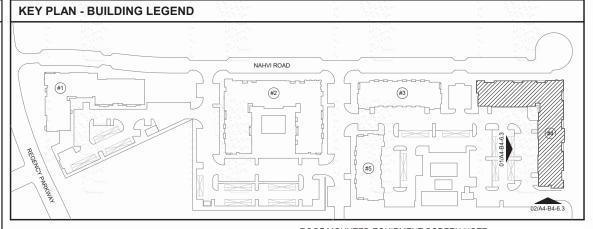

least 1' taller than the tallest piece of equipment on all facades facing public or private streets. All roof-mounted equipment shall be fully screened by a guardrail screening system painted to match the roof at least 1' taller than the tallest piece of equipment on all other facades. (Ref. to Page 12 of 15 for additional details)

ROOF MOUNTED EQUIPMENT SCREEN NOTE: All roof-mounted equipment shall be fully screened by building parapets at



MATERIAL / FENESTRATION PERCENTAGES WALLS				
BRICK - FIELD 01	53.12%			
BRICK - FIELD 02	29.82%			
BRICK - FIELD 03	0%			
CEMENTITIOUS PANEL	17.06%			
SIDING	0%			
GLASS/WINDOW/DOOR	14.52%			



MATERIAL / FENESTRATION PERCENTAGES WALLS
BRICK
BRICK - FIELD 01
BRICK - FIELD 02
BRICK - FIELD 03
CEMENTITIOUS PANEL
SIDING 29.42% 24.93% 4.49% 0% 20.64% 49.94%

T.O.C. (99'-0") CASE NUMBER _SUP #21 - 001 HENSLEY LAMKIN RACHEL, INC. 14881 QUORUM DR#550 DALLAS,TX-75254 CONTACT PERSON -JUAN TORRES

(sr.proj manager) EMAIL - juan@hlrinc.net



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BUILDING TOTAL: MATERIAL / FENESTRATION PERCENTAGES


21.94%


WALLS
BRICK
BRICK - FIELD 01
BRICK - FIELD 02
BRICK - FIELD 03

CEMENTITIOUS PANEL SIDING

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(Ref. to Page 12 of 15 for additional details)



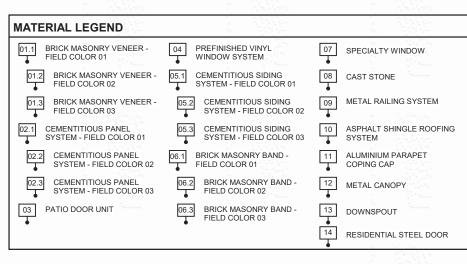

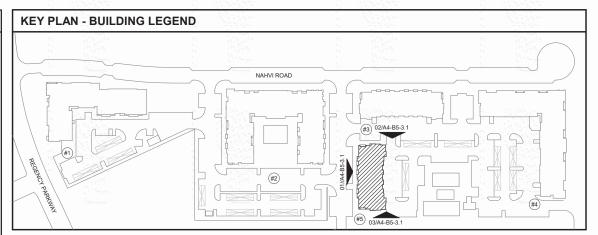

O3 SOUTH ELEVATION
SCALE: 3/32" = 1'-0"


MATERIAL (FENERTRATION)	DEBOENTAGEO
MATERIAL / FENESTRATION	PERCENTAGES
WALLS BRICK BRICK - FIELD 01 BRICK - FIELD 02 CEMENTITIOUS PANEL SIDING	65.5% 55.1% 10.4% 8.3% 26.2%
GLASS/WINDOW/DOOR	22.5%





02 NORTH ELEVATION
SCALE: 3/32" = 1'-0"

01 WEST ELEVATION
SCALE: 3/32" = 1'-0"

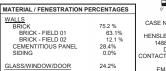

CASE NUMBER _SUP #21 - 001

HENSLEY LAMKIN RACHEL, INC.
14881 QUORUM DR#550

DALLAS, TX-75254

CONTACT PERSON JUAN TORRES
(s.rp) manager)

EMAIL - juan@hirinc.net

BUILDING TOTAL: MATERIAL / FENESTRATION PERCENTAGES

> BRICK - FIELD 01 BRICK - FIELD 02



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JLB PARTNERS


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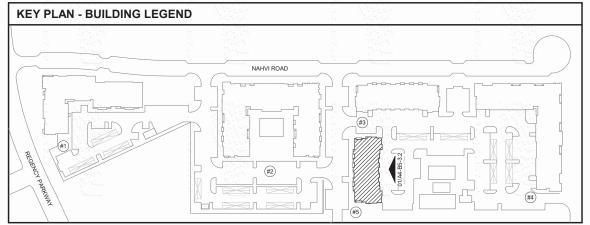
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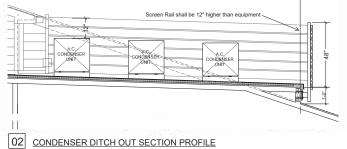
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(Ref. to Page 12 of 15 for additional details)








1) SCREEN WILL BE PAINTED TO MATCH ADJ. ROOF SHINGLE COLOR

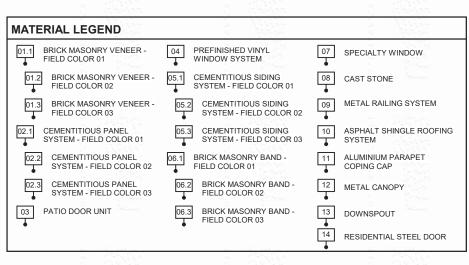2) 1" MAX GAP BETWEEN FC TRIM BOARDS

3) FC TRIM BOARDS AND GUARDRAIL TO BE PAINTED TO CLOSELY MATCH ADJ. ROOF SHINGLE COLOR

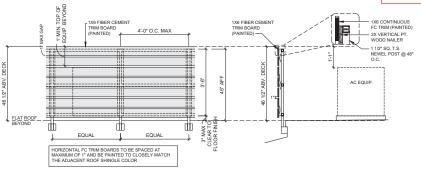

03 ELEVATION VIEW

SECTION VIEW



01 EAST ELEVATION
SCALE: 3/32" = 1'-0"

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HENSLEY LAMKIN RACHEL, INC.
14881 OUORUM DR#550
DALLAS; TX-75254
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NAHVI ROAD

EXHIBIT C


MANSFIELD,TX.

JB PARTNERS

Project ID:

Sheet No.

PAGE 12 OF 15

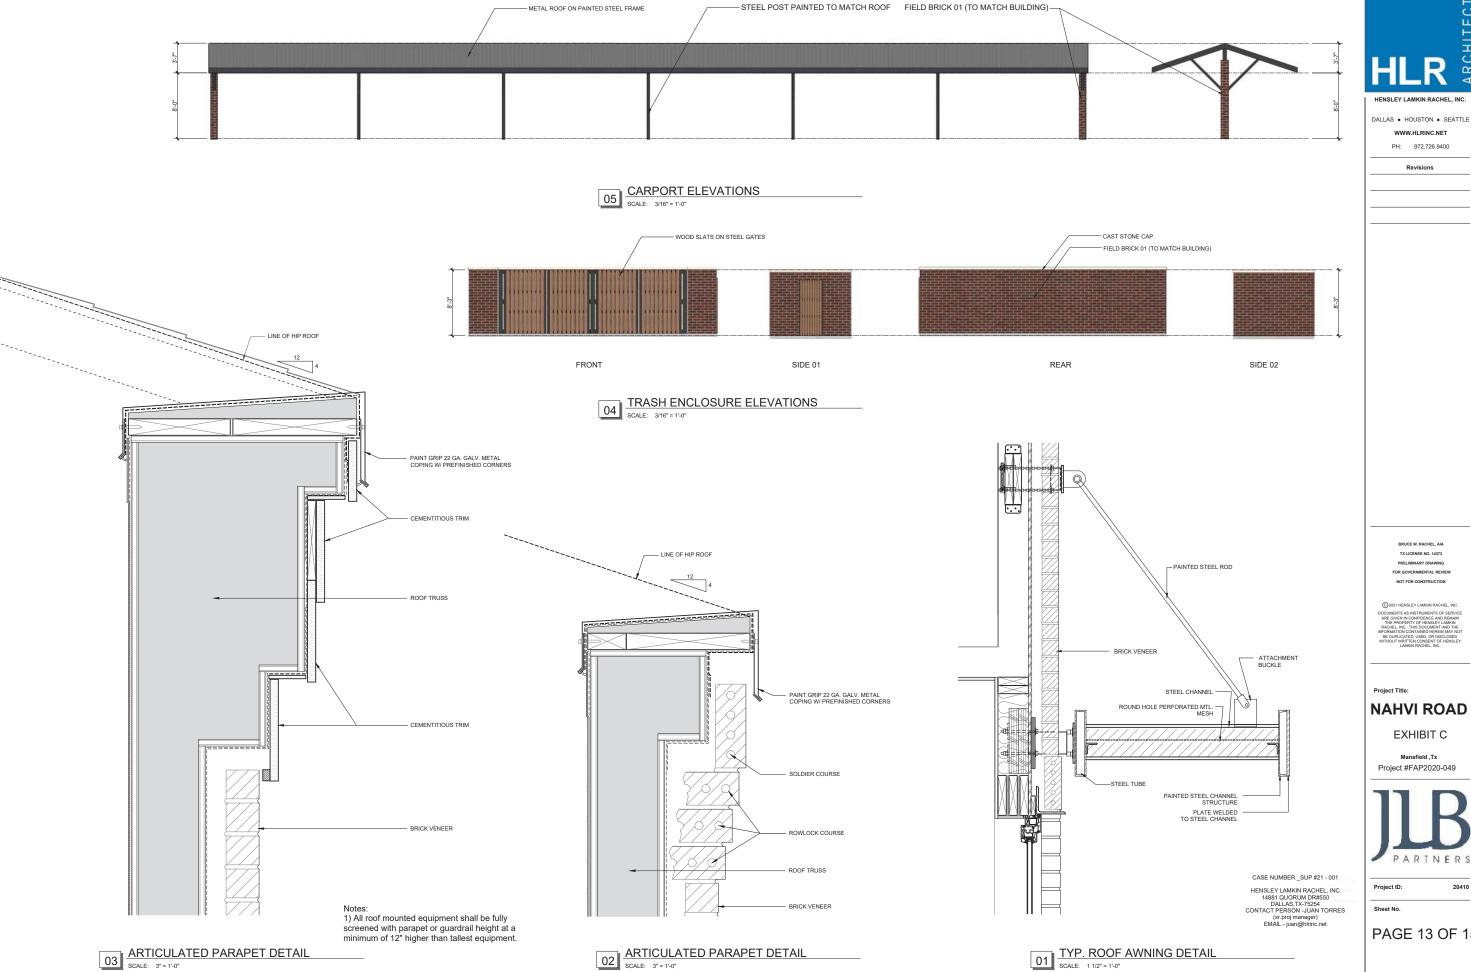

WWW.HLRINC.NET

PH: 972.726.9400

Project Title:

NAHVI ROAD

EXHIBIT C

Project #FAP2020-049

PAGE 13 OF 15



CONCEPT RENDER - BLDG 1 - INTERSECTION OF ROBERT ROAD AND RECENCY PARKWAY

CASE NUMBER _SUP #21 - 001

HENSLEY LAMKIN RACHEL, INC. 14881 QUORUM DR#550

DALLAS, TX-75254

CONTACT PERSON -JUAN TORRES (sr.pro) manager)

EMAIL - juan@hinnc.net



HENSLEY LAMKIN RACHEL, IN

DALLAS • HOUSTON • SEATTLE

WWW.HLRINC.NET

PH: 972.726.9400

_ ..

BRUCE W. RACHEL, AIA

TX LICENCE NO. 14373

PRELIMINARY DRAWING

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C 2020 HENSLEY LAMKIN RACHEL, INC DCUMENTS AS INSTRUMENTS OF SERV RRE GIVEN IN CONFIDENCE AND REMA THE PROPERTY OF HENSLEY LAMKIN RACHEL, INC. THIS DOCUMENT AND TR

Project Title:

NAHVI ROAD

EXHIBIT C

MANSFIELD,TX.




Project ID:

Sheet No.

PAGE 14 OF 15



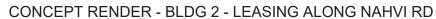

CASE NUMBER _SUP #21 - 001
HENSLEY LAMKIN RACHEL, INC.
14881 GUORUM DR#550
DALLAS,TX-75254
CONTACT PERSON _JUAN TORRES
(ST_OP) Imanager)
EMAIL - juan@hlrinc.net



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TX LICENCE NO. 14373
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NAHVI ROAD

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MANSFIELD,TX.




Project ID

Sheet No

PAGE 15 OF 15



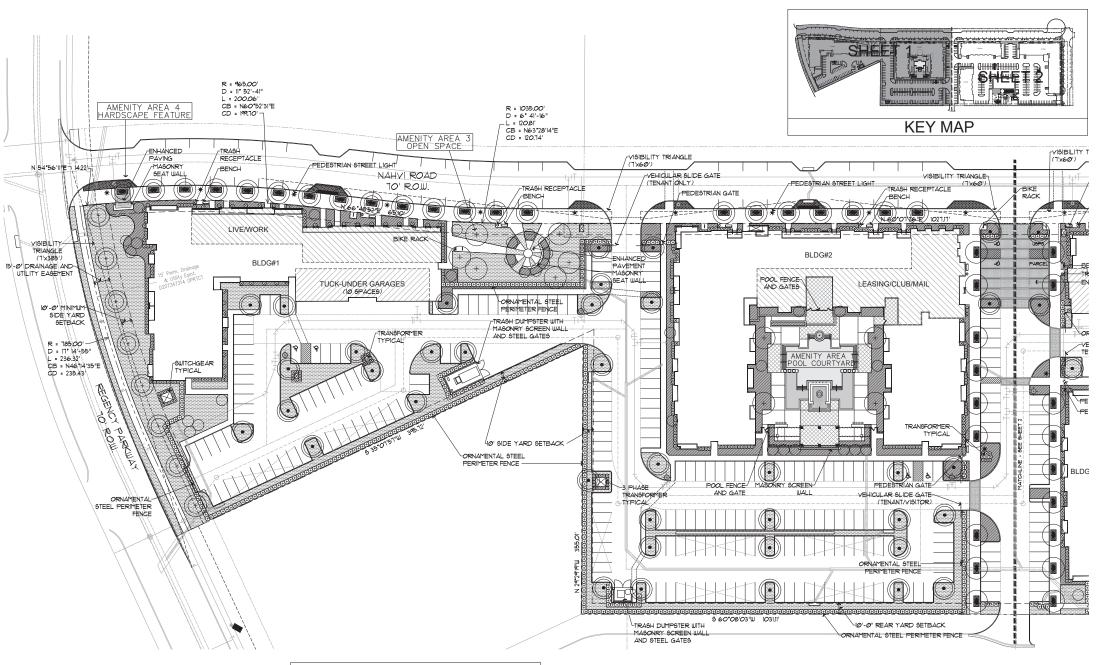

MATERIAL NOTES:

GATE AND FENCE LOCATIONS ARE SCHEMATIC AND SUBJECT TO CHANGE.

2. AMENITY AREA I - POOL COURTYARD (APPROX. 10500 SF)

CLUB AND FITNESS SPACES INTEGRATE WITH COURTYARD

COVERED OPEN-AIR LOUNGE SPACE RESORT STYLE POOL WITH SUN SHELF AND WATER FEATURES

LOUNGE CHAIRS AND OUTDOOR FURNITURE
GRILLING STATION WITH BAR COUNTER
ENHANCED PAVEMENT POOL DECK

SYNTHETIC TURF LAWN AREAS

3. AMENITY AREA 2 - DOG PARK/RESIDENT ACTIVITY ZONE (APPROX. 132009F FENCED DOG PARK WITH PET STATIONS LAUN AREA FOR RESIDENT STRUCTURED RECREATIONAL

SHARED COVERED PAVILION BETWEEN THE TWO ADJACENT

SPACES
OUTDOOR FURNITURE AND BENCH SEATING

FESTIVE STRING LIGHTING SHADE TREES AND ENHANCED PLANTING

. AMENITY AREA 3 - OPEN SPACE (APPROX. 4500SF

PASSIVE ZONE ADJACENT TO STREET FRONTAGE AND

ACCESSIBLE TO THE PUBLIC

ACCESSIBLE TO THE PUBLIC INTIMATE HARD SURFACE SITTING AREA BENCH SEATING AND MASONRY SEAT WALL SHADE TREES AND ENHANCED PLANTING

PEDESTRIAN SCALED LIGHT FIXTURES

ENHANCED PAVEMENT

6. AMENITY AREA 4 - HARDSCAPE FEATURE MASONRY SEAT WALL WITH MEMORIAL PLAQUE

ENHANCED PAVEMENT

6. DETAILS SPECIFIC TO EACH AMENITY AREA TO BE PROVIDED WITH CONSTRUCTION PLANS.

GENERAL NOTES:

LANDSCAPING MAINTENANCE: THE PROPERTY OWNER, TENANT OR AGENT EAUDECAPTION TRAINING THE PROPERTY TOWNER, TRAINING AS WHALL BE RESPONSIBLE FOR THE MAINTENANCE OF ALL REQUIRED LANDSCAPING IN A HEALTHY, NEAT, ORDERLY AND LIVE-GROWING CONDITION AT ALL TIMES. THIS SHALL INCLUDE MOWING, EDGING, PRUNING, FERTILIZING, IRRIGATION, WEEDING, AND OTHER SUCH ACTIVITIES COMMON TO THE MAINTENANCE OF LANDSCAPING ACTIVITIES CONTROL TO THE TRAINERANCE OF LANDSCAPING.

LANDSCAPED AREAS SHALL BE KEPT FREE OF TRASH, LITTER, WEEDS

AND OTHER SUCH MATERIALS NOT A PART OF THE LANDSCAPING.

PLANT MATERIAL THAT DIE SHALL BE REPLACED WITH PLANT MATERIALS OF SIMILAR VARIETY AND SIZE.

IRRIGATION: ALL LANDSCAPE AREAS SHALL BE IRRIGATED BY AN UNDERGROUND AUTOMATIC SYSTEM THAT MAY INCLUDE A DRIP IRRIGATION SYSTEM SHALL BE DESIGNED, INSTALLED, MAINTAINED, ALTERED REPAIRED, SERVICED AND


OPERATED IN A MANNET HAT WILL PROMOTE WATER CONSERVATION.

FIRE APPARATUS CLEARANCE: FIRE DEPARTMENT RISER ROOM ACCESS
SHALL REMAIN CLEAR OF SHRIBS OR OTHER LANDSCAPE MATERIAL

THAT MAY CAUSE OBSTRUCTION. THREE (3) FOOT CLEARANCE SHALL BE MAINTAINED AROUND FIRE DEPARTMENT CONNECTIONS AND FIRE HYDRANT TYPICAL

N MEIGHT 18 ALLOWED WITHIN THESE TRIANGLES.

IN HEIGHT 18 ALLOWED WITHIN THESE TRIANGLES.

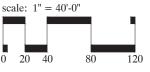







LOCATION MAP

CONCEPT PLANT SCHEDULE MAY INCLUDE BUT NOT LIMITED TO STREET TREE (5' CALIPER MINIMUM/3.5' CALIPER MINIMUM AT REGENCY PARKUMAY)
Acer grandidentatum / Bigtooth Maple
Ulmus crassifolia / Cedar Elim Quercus fusiformis / Live Oak Quercus Shumardii / Shumard Red Oak Liquidambar styraciflua / Sweet Gum Taxodium distichum / Bald Cypress

Ulmus americana / American Elm

Ulmus parvifolia / Lacebark Elm

PARKING LOT TREE (3.5" CALIPER MINIMUM) Acer grandidentatum / Bigtooth Maple Ulmus crassifolia / Cedar Elm Quercus fusiformis / Live Oak Quercus Shumardii / Shumard Red Oak Liquidambar styraciflua / Sweet Gum Taxodium distichum / Bald Cypress Ulmus americana / American Elm Ulmus parvifolia / Lacebark Elm

ADDITIONAL CANOPY TREE (3' CALIPER MINIMUM)
Acer grandidentatum / Bigtooth Maple
Ulmus crassifolia / Cedar Elm Quercus fusiformis / Live Oak Quercus Shumardii / Shumard Red Oak Liquidambar styraciflua / Sweet Gum Taxodium distichum / Bald Cypress Ulmus americana / American Eli Ulmus parvifolia / Lacebark Elm

SMALL TREE (2' CALIPER MINIMUM) Cersis canadensis texensis / Texas Redbud llex decidua / Possumhaw Holly
llex opaca 'savamah' / Savamah Holly
llex vomitoria / Yaupon Holly
Koeireuteria paniculata / Golden Rain Tree Lagerstroemia inclica / Crape Myrtle Myrica cerifera / Souther Wax Myrtle Prunus caroliniana / Carolina Laurel Cherry Prunus mexicana / Mexican Plum Vitex angus-castus / Chase Tree

<u>DENSE EVERGREEN SHRUBS</u> (5 GALLON MINIMUM) Eleagnus ebbengii / Eleagnus Ilex x attenuata 'Foster' / Foster Holly ilex cornuta / Chinese Holly liex cornuta / Chinese Holly liex cornuta 'Burfordii Nana / Dwarf Burford Holly liex x 'Nellie R Stevens' / Nellie R Stevens Holly Ilex vomitoria 'Nana' / Dwarf Yaubon Juniperus chinensis 'Seagreen' Seagreen Juniper Myrica pusilla / Dwarf Wax Myrtle

SHRUBS (3 GALLON MINIMUM) Abelia x grandiflora / Glossy Abelia
Hesperaloe parviflora / Red Yucca
Ilex cornuta 'Burfordii Nana / Dwarf Burford Holly Juniperus sabina 'Tamariscifolia' / Tam Juniper Leucophyllum frutescens / Texas Sage Ligustrum sinense "Variegata" / Varigated Chinese Privet Spirea sp. / Dwarf Spiraea

PERENNIAL (1 GALLON MINIMUM) 484

PLANTING AREA (INCLUDING SHRUBS, GROUNDCOVER 17,140 sf AND/OR PERENNIALS)

TURF (SOLID SOD)

EVERGREEN GROUNDCOVER (1 GALLON MINIMUM) 432Ø sf

> SUP #21-001 LANDSCAPE PLAN - EXHIBIT D JLB MANSFIELD

HANNOI LELD
HANNOI

ENVIRO DESIGN

1424 GREEN/LLE AVENUE, SUITE 200

DALLAS, TX 1523

PHONE: (214) 981-300

CONTACT: STEVEN REDDY

REDDY®ENVIRODESIGN-DAILAGO

733

ENVIRO

DESIGN





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CONSTRUCTION

REVISIONS 03-04-2021 03-18-2021 03-26-2021 04-09-2021

SFIEL JLB PARTNERS LLC MANSFIELD, TEXAS AN Ξ JLB

SCALE

1" = 40'-0'

DATE

02-01-2021

LANDSCAPE PLAN

SHEET EXHIBIT D 1 OF 4

LOCATION MAP

VISIBILITY TRIANGLE

BENCH

TRASH RECEPTACLE

VEHICULAR BLIDE GATE

PEDESTRIAN GATE PERIMETER FENCE

MAINTENANCE

VEHICLE

PEDESTRIAN GATE

BLDG#5

PARCEL

6////

TRASH RECEPTACLE

BIKE RACK

ORNAMENTAL STEEL PERIMETER FENCE

BLDG#3

TUCK-UNDER GARAGES

(15 SPACES)

TRANSFORMER

VISIBILITY TRIANGLE (T'x60')

MAIL

ANSFORMER-TYPICAL


GATE

GATE

SETBACK

:RIMETER FENCE

SITOR)

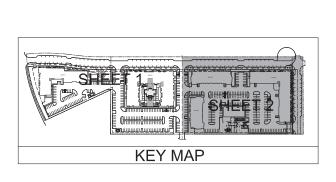

BENCH

TRASH RECEPTACLE

BIKE RACK

STEEL PERIMETER

FENCE

TRANSFORMER

TYPICAL

AMENITY AREA 2

DOG PARK/RESIDEN

ACTIVITY ZONE

(H)

5 60 03 03 111 103111

(+)

TRASH RECEPTACLE

BENCH BIKE RACK

PEDESTRIAN

RECYCLE CENTER WITH MASONRY SCREEN WALL

TRASH DUMPSTER WITH MASONRY SCREEN WALL AND STEEL GATES

AND STEEL GATES

10'-0' REAR YARD SETBACK

ORNAMENTAL STEEL PERIMETER FENCE-

GATE

NAHVI ROAD

10' R.O.W.

TUCK-UNDER GARAGES

(10 SPACES)

3 PHASE TRANSFORMER TYPICAL

BLDG#4

PEDESTRIAN GATE

VEHICIII AR SI IDE GATE-

TRASH RECEPTACLE

_

TRIANGLE (T'x60')

BIKE RAÇÎK

TRIANGLE

TRASH RECEPTACLE

ORNAMENTAL STEE PERIMETER FENCE

CONCEPT PLANT SCHEDULE

MAY INCLUDE BUT NOT LIMITED TO

STREET TREE (5' CALIPER MINIMUM/3.5' CALIPER MINIMUM AT REGENCY PARKWAY) Acer grandidentatum / Bigtooth Maple Ulmus crassifolia / Cedar Elm Quercus fusiformis / Live Oak Quercus Shumardii / Shumard Red Oak Liquidambar styraciflua / Sweet Gum Taxodium distichum / Bald Cypress Ulmus americana / American Elm Ulmus parvifolia / Lacebark Elm

PARKING LOT TREE (35" CALIPER MINIMUM) Acer grandidentatum / Bigtooth Maple Ulmus crassifolia / Cedar Elm Quercus fusiformis / Live Oak Quercus Shumardii / Shumard Red Oak Liquidambar styracifiua / Sweet Gum Taxodium distichum / Bald Cypress Ulmus americana / American Elm

Ulmus parvifolia / Lacebark Elm

ADDITIONAL CANOPY TREE (3* CALIFER MINIMUM)
Acer grandidentatum / Bigtooth Maple
Ulmus crassifolia / Cedar Elm
Quercus Niciformis / Live Oak
Quercus Shumardii / Shumard Red Oak Liquidambar styraciflua / Sweet Gum Taxodium distichum / Bald Cypress Ulmus americana / American Elm Ulmus parvifolia / Lacebark Elm

SMALL TREE (2º CALIPER MINIMUM)

Cersis canadensis texensis / Texas Redbud

Ilex decidua / Possumhaw Holly ilex decicula / Possimnali Holly ilex opaca 'savarnah' / Savarnah Holly ilex vomitoria / Yaupon Holly Koelreuteria paniculata / Golden Rain Tree Lagerstroemia indica / Crape Myrite Myrica cerifera / Souther libx Myrite Prunus caroliniana / Carolina Laurel Cherry Prunus mexicana / Mexican Plum Vitex angus-castus / Chase Tree

DENSE EVERGREEN SHRUBS (5 GALLON MINIMUM) Eleagnus ebbengii / Eleagnus Ilex x attenuata "Foster" / Foster Holly Ilex cornuta / Chinese Holly Ilex cornuta 'Burfordii Nana / Dwarf Burford Holly illex x Neille R Stevens '/ Neille R Stevens Holly illex x venitoria Nana' / Duarf Yaupon Juniperus chinensis 'Seagreen' Seagreen Juniper Myrica pusilla / Duarf Wax Myrtle

SHRUBS (3 GALLON MINIMUM) Abelia x grandifiora / Glossy Abelia
Hesperalce parvifiora / Red Yucca
Ilex comuta 'Burfordi Nana / Dwarf Burford Holly
Juniperus sabina 'Tamariscifolia' / Tam Juniper
Leucophyllum frutescens / Texas Sage
Ligustrum isnese 'Variegata' / Yarigated Chinese Privet
Spirea sp. / Dwarf Spiraea

PERENNIAL (I GALLON MINIMUM)

PLANTING AREA (INCLUDING SHRUBS, GROUNDCOVER TURF (SOLID SOD) 57.14Ø sf

EVERGREEN GROUNDCOVER (1 GALLON MINIMUM) 4,32Ø sf

NOTE: REFERENCE EXHIBIT D SHEET I FOR GENERAL NOTES AND MATERIAL NOTES.

SUP #21-001 LANDSCAPE PLAN - EXHIBIT D


JLB MANSFIELD

BLOCK A, LOT I
BLOCK A, LOT I
IN THE CITY OF MANSFIELD, TARRANT COUNTY,
TEXAS
E. McANIER SURVEY, ABST. NO. 10/05
56/0364 Sq. Ft. (Gross) / 12/63 Acres (Gross)
Current Zoning: PD-1558-The Reserve-Workplace Subdistrict

LANDSCAPE ARCHITECT
ENVIROD DESIGN
1424 GREENVILLE AVENUE, SUITE 200
DALLAS, TX TB331
PHONE: (214) 387-3010
CONTACT: STEVEN REDDY
SREDDY®ENVIRODESIGN-DALLAS.COM

STEDDY®ENVIRODESIGN-DALLAS.COM

OUNER / APPLICANT
JLB REALTY, LLC
3890 W. NORTHUEST HIGHUAY, TITH FLOOR
DALLAS, TEXAS T5220
CONTACT: BRITTON CHURCH
BCHURCH-9LBPARTNIERS.COM
PHONE: (214) 271-8480

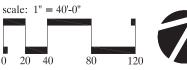



ENVIRO DESIGN





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REVISIONS

SFIELD JLB PARTNERS LLC MANSFIELD, TEXAS MAN JLB

SCALE

1" = 40'-0'

DATE

02-01-2021

LANDSCAPE

SHEET EXHIBIT D 2 OF 4

LANDSCAPE REQUIREMENTS	
LANDSCAPE IMPROVEMENTS FOR THE PROPERTY SHALL CONFORM TO APPLICABLE SECTION (INCLUDED BELOW) OF "THE RESERVE PLANNED DEVELOPMENT DISTRICT STANDARD-WORKPLACE SUBDISTRICT" AS ADOPTED BY THE CITY OF MANSFIELD.	
SECTION 8 - PARKING AREAS	
8.4 <u>SURFACE PARKING LANDSCAPING</u> - PARKING LOTS THAT CONTAIN TEN (10) OR MORE PARKING SPACES SHALL PROVIDE LANDSCAPING AND SCREENING IN ACCORDANCE WITH SECTION 1300 LANDSCAPING AND SCREENING REQUIREMENTS OF THE MANSFIELD ZONING ORDINANCE.	PROVIDED
86 SURFACE PARKING PERIMETER SCREENING - ALL SURFACE PARKING LOTS SHALL BE SCREENED FROM STREET VIEW SUCH SCREENING SHALL TAKE THE FORM OF THREE (3) FOOT PLANTING OF DENSE EVERGREEN HEDGE AT THE TIME OF INSTALLATION MEASURED ABOVE THE GRADE OF THE PARKING LOT.	PROVIDED
SECTION 10 - SERVICE AND EQUIPMENT AREAS	
102 SERVICE AREA SCREENING - WHEN SERVICE AREAS ARE NOT ABLE TO BE PLACED WITHIN THE BUILDING ENVELOPE, THEY SHALL BE SCREENED BY MASONRY WALLS SIX (6) FEET IN HEIGHT WITH ADJACENT PLANTINGS OF DENSE EVERGREEN MATERIAL THREE (3) FEET IN HEIGHT AT NOTALLATION, TRANSFORMERS, SWITCHGEAR, AIR CONDITIONERS, AND OTHER GROWN MOUNTED EQUIPMENT OR UTILITY FUNCTIONS MUST BE SCREENED FROM VIEW WITH EVERGREEN PLANTINGS SIX (6) FEET IN HEIGHT AT INSTALLATION.	PROVIDED
SECTION 13 - STREETSCAPE AND OPEN SPACE	
13. FRONT YARDS - SIDEWALKS AND LANDSCAPING SHALL BE PROVIDED BETWEEN THE STREET AND BUILDING FACADE TO OFFER AN INVITING WALKING EXPERIENCE, PLANT MATERIALS SHOULD CONSIST OF SHADE TREES, ORNAMENTAL TREES, SHRUBS, EVERGREEN GROUNDCOVERS, VINES, AND SEASONAL COLOR, AND MAY BE OMITTED AT BUILDING ENTRIES, SEATING AREAS, AND ADJACENT TO COMMERCIAL USES.	PROVIDED
132 STREETSCAPES - STREET TREES SHALL BE PLANTED AT AN AVERAGE OF THIRTY (30) FEET ON CENTER ACROSS EACH BLOCK FACE AND THREE AND A HALF (35) FEET FROM THE BACK OF CURB, TREES TO HAVE A MINIMUM CALIPER OF FIVE (5) INCHES AT INSTALLATION, AND SHALL NOT BE CLOSER THAN TEN (10) FEET FROM A STREET LIGHT OR FIRE HYDRANT.	PROVIDED
135 STREET TREES ALONG REGENCY PARKWAY - STREET TREES SHALL BE PLANTED AT AN AVERAGE FORTY (40) FEET ON CENTER TREES SHALL HAVE A MINIMM CALIPER OF THREE AND A HALF (35) INCHES AT INSTALLATION.	PROVIDED
13.6 TREE_PLANTERS - STREET TREES TO BE CENTERED WITHIN FIVE (5) FOOT BY TEN (16) FOOT PLANTERS AS LEAVE-OUTS WITHIN THE SIDEWALK AND SURROUNDED WITH ETHER A TWELVE (12) INCH HIGH ORNAMENTAL STEEL FENCE OR BRICK TURN-UP EDGE. THESE PLANTERS WILL ALSO CONSIST OF EVERGREEN GROUNDCOVER AND PERBINIAL PLANTINGS FOR AESTHETIC INTEREST. THE STREET-FACING EDGE OF ALL PLANTERS SHALL BE PLACED ONE AND A HALF (15) FEET FROM THE FACE OF THE CURB.	PROVIDED
13.6 OPEN SPACE - THE PROVISIONS OF ADEQUATE AND APPROPRIATE OPEN SPACE AREAS ADD VALUE TO DEVELOPMENT AND ARE ENCOURAGED IN ALL DEVELOPMENT IN THE SUB-DISTRICT, THE OPEN SPACE PROVIDED SHOULD BE APPROPRIATELY DESIGNATED AND SCALED, OPEN SPACES MAY BE IN THE FORM OF POCKET PARKS, PLAZAS, SQUARES, LINEAR PARKS, ENVIRONMENTAL PRESERVES, PRIVATE OPEN SPACES, SIDEWALKS, ACTIVE SPORTS FIELDS, STRUCTURED RECREATIONAL ACTIVITY AREAS, ETC.	PROVIDED
13.9 <u>§TREET BENCHES</u> - \$TREET BENCHES \$HALL BE PROVIDED AT AVERAGE INTERVALS OF ONE HUNDRED AND FIFTY (150) FEET ALONG ALL BLOCK FACES EXCEPT ALONG REGENCY PARKWAY, STREET BENCHES SHALL BE PLACED FACING THE SIDEWALK AND CURB, AND PARALLEL TO THE BUILDINGS.	PROVIDED
13.10 <u>STREET LIGHTS</u> - STREET LIGHTS SHALL BE PROVIDED FOUR (4) FEET FROM FACE OF CURB AT AVERAGE INTERVALS OF NINETY (90) FEET ALONG ALL BLOCK FACES EXCEPT REGENCY PARKWAY, LIGHT FIXTURE SHALL BE MOUNTED TEN (10) TO TWELVE (12) FEET FROM FINISH GRADE AND SHALL BE METAL HALIDE TYPE.	PROVIDED
13.11 <u>BICYCLE RACKS</u> - BICYCLE RACKS SHALL BE PROVIDED AT AVERAGE INTERVALS OF ONE HUNDRED AND FIFTY (150) FEET ALONG ALL BLOCK FACES EXCEPT REGENCY PARKWAY, AND CLUSTERED AT STREET LIGHT OR BUILDING ENTRY LOCATIONS.	PROVIDED
13.12 <u>LITTER CONTAINERS</u> - LITTER CONTAINERS SHALL BE PROVIDED AT AVERAGE INTERVALS OF ONE HUNDRED AND FIFTY (150) FEET ALONG ALL BLOCK FACES EXCEPT REGENCY PARKWAY, AND CLUSTERED AT STREET LIGHT OR BUILDING ENTRY LOCATIONS.	PROVIDED
SECTION 1300 - LANDSCAPING AND SCREENING REQUIREMENTS	
Q. PARKING LOT PERIMETER LANDSCAPING: (1) IN THE MF-1, MF-2, OP, C-1, C-2, C-3, 1-1, AND 1-2 ZONING DISTRICTS AND ALL NONRESIDENTIAL DEVELOPMENT SUCH AS CHIRCHES, SCHOOLS, AND PUBLIC FACILITIES IN ANY ZONING DISTRICT, ALL PARKING LOT, VEHICULAR USE AND MANEUVERING AREAS THAT ARE NOT SCREENED BY ONSITE BUILDINGS SHALL DE SCREENED ROM YIELD OF PUBLIC STREETS IN ACCORDANCE WITH THE FOLLOWING REQUIREMENTS:	PROVIDED
(a) THE SCREENING SHALL BE A MINIMUM HEIGHT OF THREE (3) FEET AT MATURITY (IN THE CASE OF PLANTS) ABOVE THE GRADE OF THE PARKING LOT, VEHICLE USE AND/OR MANEUVERING AREAS.	PROVIDED
(b) THE SCREENING SHALL CONSIST OF ONE OF A COMBINATION OF THE FOLLOWING, 1) SCREENING SHRUBS, AND/OR 2) SODDED BERMS	SHRUBS
(c) THE SCREENING MAY OCCUR WITHIN THE STREET LANDSCAPE SETBACK.	N/A
(d) WHEEL STOPS SHALL BE PROVIDED FOR PARKING SPACES ADJACENT TO THE SCREENING TO PROHIBIT ANY VEHICLE FROM OVERHANGING THE PLANTING AREA.	N/A
R. PARKING LOT INTERNAL LANDSCAPING: ANY PARKING LOT THAT CONTAINS TEN (IØ) OR MORE PARKING SPACES SHALL PROVIDE INTERNAL LANDSCAPING EXCEPT AS PRESCRIBED HEREN BELOW.	
(1) A RATIO OF ONE CANOPY TREE FOR EVERY TEN (IØ) PARKING SPACES SHALL BE PROVIDED THROUGHOUT ANY SURFACE PARKING LOT.	PROVIDED (510 SURFACE/ 10=51)
(2) PLANTING AREAS FOR THE TREES WITHIN THE PARKING ROWS OF A SURFACE PARKING LOT SHALL BE ACHIEVED BY ONE OR BOTH OF THE FOLLOWING:	
(a) A CONTIGUOUS LANDSCAPE MEDIAN STRIP, AT LEAST SIX (6) FEET WIDE (BACK-OF-CURB TO BACK-OF-CURB) BETWEEN ROWS OF PARKING SPACES. TREES SHALL BE PLACED AT INTERVALS NO GREATER THAN FORTY (40) FEET APART OF FRACTION THEREOF.	N/A
(b) LANDSCAPE (BLANDS, AT LEAST THE MINIMUM SIZE OF A REGULAR PARKING SPACE OF NINE BY EIGHTEEN FEET (9' X 18') OR ONE HUNDRED SIXTY-TWO (162) SQUARE FEET, NO MORE THAN FIFTEEN (15) CONTIGUOUS SPACES SHALL BE LOCATED TOGETHER WITHOUT A TREE-18LAND.	PROVIDED
(3) PARKING LOTS THAT ARE DESIGNED WITH PLANTED OR RAISED LANDSCAPE ISLANDS SHALL DESIGN THE ISLANDS SO AS NOT TO INTERFERE WITH THE OPENING OF CAR DOORS IN ADJACENT SPACES.	PROVIDED
(4) EVERY REQUIRED LANDSCAPE ISLAND MUST INCLUDE ONE (1) CANOPY TREE.	PROVIDED *(NORTH/SOUTH DRIVE TO NCORPORATE TREES IN TREE WELLS IN SIDEWALK IN LEIU OF TREES IN PARKING ISLANDS AS APPROVED BY CITY STAFF)
9. PARKING END CAPS: ONE (1) LANDSCAPE ISLAND SHALL BE LOCATED AT THE TERMINUS OF EACH ROW OF PARKING AND SHALL CONTAIN ONE (1) TREE. ROWS WITH HEAD-TO HEAD PARKING ARRANGEMENT SHALL HAVE TWO (2) ISLANDS AND TWO (2) TREES.	PROVIDED

		, , , ,	RT - BUFFER YARDS/	02.00		
LOCATION OF BUFFERYARD OR SETBACK	REQUIRED/ PROVIDED	LENGTH	BUFFER YARD OR SETBACK WIDTH/ TYPE	CANOPY TREES	ORNAMENTAL TREES	SCREENING WALL/ DEVIC HEIGHT AND MATERIAL
NORTH (NAHVI ROAD)	REQUIRED (1 TREE/30 LF)	1,404261	LOCAL STREET 10' R.O.W.	47	N/A	N/A
	PROVIDED	1,404261	LOCAL STREET 10' R.O.W.	*38	N/A	N/A
EAST (FUTURE STREET)	REQUIRED (1 TREE/ 30 LF)	329.14'	LOCAL STREET 60' ROW.	11	N/A	N/A
	PROVIDED	329.14	LOCAL STREET 60' ROW.	*8	N/A	N/A
50UTH	REQUIRED	1031.11'	10' REAR YARD SETBACK	N/A	N/A	N/A
	PROVIDED	1031.11'	10' REAR YARD SETBACK	N/A	N/A	N/A
WEST (INSET)	REQUIRED	355.01	10' SIDE YARD SETBACK	N/A	N/A	N/A
	PROVIDED	355.01	10' SIDE YARD SETBACK	N/A	N/A	N/A
SOUTH (INSET)	REQUIRED	395.721	10' SIDE YARD SETBACK	N/A	N/A	N/A
	PROVIDED	395.721	10' SIDE YARD SETBACK	N/A	N/A	N/A
WEST REGENCY PARKWAY)	REQUIRED (1 TREE/40 LF)	312.451	IØ' MIN. SIDE YARD SETBACK	8	N/A	N/A
	PROVIDED	312.451	10' MIN. SIDE YARD SETBACK	8	N/A	N/A

OTHER COMMENTS: N/A

*STREET TREE QUANTITY REDUCED BY CITY STAFF TO ACCOMMODATE VISIBILITY TRIANGLE

	summ	ARY CHART - INTER	OR LAND	3CAPE		
	LAND9CAPE AREA (SF)	% OF LANDSCAPE AREA	CANOPY TREES	ORNAMENTAL TREES	SHRUBS	GROUNDCOVER (SF)
REQUIRED	44,44Ø SF	10%	N/A	N/A	N/A	N/A
PROVIDED	44,44Ø SF	10%	N/A	N/A	N/A	N/A
NOTE ANY CREDITS	USED IN CALCULATIONS: N/A					
OTHER COMMENTS: 1	V/A					

SUMMARY CHART - INTERIOR PARKING LOT LANDSCAPING				
NUMBER OF REQUIRED PARKING SPACES	4Ø7			
NUMBER OF PROVIDED PARKING \$PACES (INCLUDES TANDEM PARKING/EXCLUDES ON-STREET PARKING)	510			
NUMBER OF TREES REQUIRED (1 TREE/ 10 SPACES)	51			
NUMBER OF TREES PROVIDED	77			
NOTE ANY CREDITS USED IN CALCULATIONS: N/A				
OTHER COMMENTS: N/A				

CONCEPT PLANT SCHEDULE MAY INCLUDE BUT NOT LIMITED TO

<u>STREET TREE</u> (5' CALIPER MINIMUM/3.5' CALIPER MINIMUM AT REGENCY PARKWAY) Acer grandidentatum / Bigtooth Maple Ulmus crassifolia / Cedar Elm Quercus fusiformis / Live Oak Quercus Shumardii / Shumard Red Oak Liquidambar styracifiua / Sweet Gum Taxodium distichum / Bald Cypress Ulmus americana / American Elm Ulmus parvifolia / Lacebark Elm

PARKING LOT TREE (3.5" CALIPER MINIMUM) Acer grandidentatum / Bigtooth Maple Ulmus crassifolia / Cedar Elm umus crassifuir / Cedar Em Quercus Pusiformis / Live Oak Quercus Phumardii / Shumard Red Oak Liquidambar styracifiua / Sweet Gum Taxodium Gistichum / Bald Cypress Umus americana / American Elim Ulmus parvifolia / Lacebark Elm

ADDITIONAL CANOPY TREE (3* CALIFER MINIMUM)
Acer grandidentatum / Bigtooth Maple
Ulmus crassifolia / Cedar Elm
Quercus Bruiformis / Live Oak
Quercus Shumardii / Shumard Red Oak Liquidambar styraciflua / Sweet Gum Taxodium distichum / Bald Cypress Ulmus americana / American Elm Ulmus parvifolia / Lacebark Elm

9MALL TREE (2" CALIPER MINIMUM) Cersis canadensis texensis / Texas Redbud Ilex decidua / Possumhaw Holly ilex opaca 'savannah' / Savannah Holiu llex opaca 'savanna'r / savannan Holiy llex vomitoria / Taupon Holiy Koeireuteria paniculata / Golden Rain Tree Lagerstroemia indica / Crape Myrtle Myrica cerifera / Souther ilbax Myrtle Prunus caroliniana / Carolina Laurel Cherry Prunus mexicana / Mexican Plum Vitex angus-castus / Chase Tree

DENSE EVERGREEN SHRUBS (5 GALLON MINIMUM) DENDE EYENGREEN OFFUDD 12 DANGED 11 THE BAT //
Eleagnus elobengii / Eleagnus Eleagnu llex vomitoria Nana' / Dwarf Yaupon Juniperus chinensis 'Seagreen' Seagreen Juniper Myrica pusilla / Dwarf Wax Myrtle

SHRUBS (3 GALLON MINIMUM)
Abelia x grandiflora / Glossy Abelia
Hesperaloe parviflora / Red Yucca
liex comuta "Burfordili Nana / Duarf Burford Holly 733 Juniperus sabina 'Tamariscil'olia' / Tam Juniper Leucophyllum frutescens / Texas Sage Ligustrum sinense 'Variegata' / Varigated Chinese Privet Spirea sp. / Dwarf Spiraea

PERENNIAL (I GALLON MINIMUM)

PLANTING AREA (INCLUDES SHRUBS, GROUNDCOVERS 17.14Ø sf

EVERGREEN GROUNDCOVER (1 GALLON MINIMUM) 4,320 sf

TURF (SOLID SOD)

SUP #21-001 LANDSCAPE REQUIREMENTS & SUMMARY TABLES - EXHIBIT D

JLB MANSFIELD

57,14Ø sf

BLOCK A, LOT I

IN THE CITY OF MANSFIELD, TARRANT COUNTY,
TEXAS

E. McANIER SURVEY, ABST, NO. 10/05
56/0549 49, Ft. (Gross) / 12/69 Acres (Gross)

Current Zoning: PD-1558-The Reserve-Workplace Subdistrict

CONTACT: STEVEN REDDY SREDDY@ENVIRODESIGN-DALLAS.COM

LANDSCAPE ARCHITECT OUNER / APPLICANT
ENVIRO DESIGN
1424 GREENVILLE AVENUE, SUITE 200 3890 W. NORTHUEST HIGHWAY, THY FLOOR
DALLAS, TX-1523 UNDER 1230 CONTACT: BRITTON CHURCH BCHURCH@JLBPARTNERS.COM PHONE: (214) 271-8480

SCALE N/A

MANSFIELD

JLB

JLB PARTNERS LLC MANSFIELD, TEXAS

ENVIRO DESIGN

FOR PRELIMINARY REVIEW ONLY NOT FOR PERMITTING OR CONSTRUCTION

REVISIONS

DATE 02-01-2021

> TITLE LANDSCAPE PLAN


SHEET

EXHIBIT D 3 OF 4

PERIMETER FENCE

3/4" = 1'-0"

ORNAMENTAL STEEL FENCE AND GATES TO HAVE "DECO-GUARD" (CLASSIC) TO A ININIMIM HEIGHT OF 4-0" ABOVE BOTTOM RAIL. "DECO-GUARD" TO BE NITALLED ALONG THE ENTIME LENGTH OF PENCE THAT HAS GATE SLIDING BEHIND IT. MAXIMUM HORIZONTAL OFFINING IN "DECO-GUARD" TO BE 2 ½", INSTALLED ON INSIDE FACE OF FENCE.

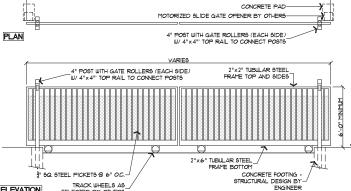

NOTES:

1. THIS DETAIL IS FOR DESIGN INTENT PURPOSES ONLY.

2. CONTRACTOR TO SUBMIT GATE HARDWARE AND FABRICATION SHOP DEAININGS FOR APPROVAL BY OWNER AND FABRICATION SHOP DEAININGS FOR APPROVAL BY OWNER AND LANDSCAPE ARCHITECT PRICE TO CONSTRUCTION.

3. REFER TO CIVIL PLAN FOR GATE LOCATIONS.

4. REFER TO CIVIL PLANS FOR FINAL DRIVEWAY WIDTH.

5. CONTRACTOR TO VESTIFY GATE OFFERATIOR SPECIFICATIONS WITH FINAL DESIGN AND WEIGHT OF GATES.

6. CONTRACTOR TO NISTAL SLIDE GATES AND GATE OPERATIONS FER HAMPACTURERS DETAIL AND SPECIFICATIONS. ALL VEHICLLAR GATE NOTALLATION AND SPECIFICATIONS. ALL VEHICLLAR GATE NOTALLATION AND FOR THE HAMPACTURERS DETAIL AND STANDARD AND SPECIFICATIONS.

1. PRIME AND PAINT SILDE GATE TO MATCH BUILDING RAILINGS.

6. GATE HEIGHT TO BE 6"-O" FROM TOP OF CURB GRADES.

1. VERIFY FIRE DEPARTMENT REGUIREMENTS FOR EMERGENCY OPPENNE.

10. SINGLE SLIDE VEHICLLAR GATE TO BE SIMILAR TO THIS DETAIL.

3/4" = 1'-0"

-FINISH GRADE

1/4" = 1'-0"

VEHICULAR SLIDE GATE

TRACK WHEELS AS_ SELECTED BY OTHERS

ELEVATION

NOTES:

I. PRINE AID PAINT GATE TO MATCH BUILDING RAILINGS.

I. PRINE AID PAINT GATE TO MATCH BUILDING RAILINGS.

I. RENFORCING AND FOOTING DETAILS FOR FENCE POSTS BY STRUCTURAL ENGINEER.

S. PROVIDE 3-6* ACCESS GATE WHERE SHOWN ON PLAN, HC ACCESSIBLE ENTRY LOOK FEATURE AS SELECTED BY OWNER SELF LATCHING AND LOCKING MECHANISH.

4. ENBURE 5-X5 CLEAR SPACE ON PILL SIDE OF GATES.

5. ALL STEEL CATTES AND GROUND SYCODTH.

6. CONTRACTOR TO SUBSTI SHOP DRAWINGS FOR APPROVAL PRIOR TO CONSTRUCTION.

1. ALL GATES OF THE TAIL APPLICABLE STATE AND LOCAL CODES AND AND ASTANDARDS AND GUIDELINES.

6. CREMATION OF GATE TO COMPLY UITH ADA REQUIREMENTS, INCLIDING OFFERABLE WITH OWE HAND, USING SLEF HAXIMM PRESSURE WITHOUT TIGHT GRASPING, PINCHING OR TWISTING OF THE WIRIST.

2. INSURE SYCOTI SURFACE (STEEL PLATE) IS PROVIDED FOR ANSI 4042 STEEL PAITE TO BE FLUSH WITH GATE FORCETS AND ANY CAVITIES AT TOP OF PLATE TO BE CAPPED, ENSURE HORIZONTAL/VERTICAL JOINTS ARE LESS THAN 106. 2" SQ. STEEL POST SELF-LATCHING AND LOCKING MECHANISM CURINDE PEDESTRIAN GATE TO HAVE SHIPLEX TYPE LOCK. OR EQUAL) WITH LEVER HANDLE AS SELECTED BY CHARE HOSDE OF GATE TO HAVE LOCK AS SELECTED BY CHARE PROVIDE METAL MESH FOR SECURITY AROUND LOCK. MECHANISM IF REQUIRED WITH SELECTION OF LOCK. 3 90. STEEL PICKETS 2 6 0.C. 2" 5Q. STEEL BOTTOM RAIL - STEEL PLATE ON PUSH SIDE OF GATE WALKWAY (REFERENCE PLANS) -1 1 SAND CUSHION CONCRETE FOOTING (STRUCTURAL - DESIGN BY ENGINEER), EMBED STEEL POST 2'-6" MINIMUM. d' 18" MIN. FROM EDGE OF GATE ON PULL 9 SIDE AND 12" MIN. FROM EDGE OF GATE ON PUSH SIDE 5'-O" X 5'-O" MIN. LANDING FOR HANDICAP ACCESS (ON BOTH SIDES OF GATE - REFERENCE PLAN)

KANT-SLAM' SELF CLOSING GATE MECHANISM (OR APPROVED EQUAL) UITH (2) SELF CLOSING GATE HINGES

3'-6" GATE (3'-0" CLEAR MINIMUM)

TOP OF GATE
TO BE LEVEL
2" SQ. STEEL TOP RAIL

PERIMETER GATE

3/4" = 1'-0"

SUP #21-001 LANDSCAPE PLAN - EXHIBIT D

JLB MANSFIELD

BLOCK A, LOT I
IN THE CITY OF MANSFIELD, TARRANT COUNTY,
TEXAS
E. MCANIER SURVEY, ABST. NO. 1005

560,584 Sq. Ft. (Gross) / 12,869 Acres (Gross) Current Zoning: PD-1558-The Reserve-Workplace Subdistrict

LANDSCAPE ARCHITECT
ENVIRO DESIGN
1424 GREENVILLE AVENUE, SUITE 200
24890 W NORTHUEST HIGHWAY, THI FLOOR
DALLAS, TX 15/23
PHONE: (214) 931-3000
CONTACT: SRITTON CHURCH
CONTACT: TEXTON CHURCH
SEEDDYSENVEDDESCON
SEEDDYSENVEDDESCON
SEEDDYSENVEDDESCON
SEEDDYSENVEDDESCON
SEEDDYSENVEDDESCON SREDDY@ENVIRODESIGN-DALLAS.COM

PHONE: (214) 271-8480

File

TITLE LANDSCAPE PLAN SHEET

EXHIBIT D 4 OF 4

SCALE

AS NOTED

DATE

02-01-2021

DESIG

ENVIRO]

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NOT FOR PERMITTING

CONSTRUCTION

REVISIONS

03-04-2021

SFIE

MA

JLB PARTNERS LLC MANSFIELD, TEXAS







PROPOSED WALL SIGN 'B' FACING NAHVI RD



HLR ARCHITECTS

Ν

DALLAS • HOUSTON • SEATTLE

WWW.HLRINC.NET

PH: 972.726.9400

Davidalana

BRUCE W. RACHEL, AIA
TX LICENCE NO. 14373
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Project Title:

NAHVI ROAD

EXHIBIT E

MANSFIELD,TX.



Project ID:

Sheet No.


PAGE 1 OF 1

#20410



TYPICAL WALL SIGN
SCALE: 1/4" = 1'-0"



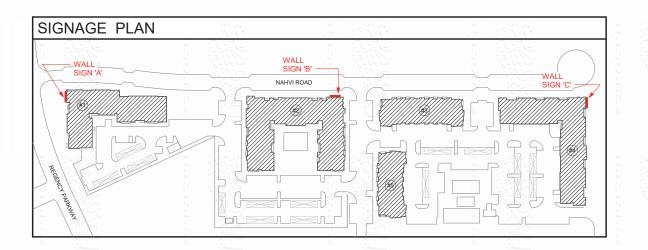

SIGNAGE AND MATERIALS PLAN - EXHIBIT E

CASE NUMBER _SUP #21 - 001

NOTES:
ALL SIGNAGE TO COMPLY WITH SECTION 11
OF THE WORKPLACE SUB-DISTRICT OF THE
RESERVE PLANNED DEVELOPMENT DISTRICT
DESIGN STANDARDS. SETBACKS FOR
MONUMENT SIGNS SHALL COMPLY WITH 7100
OF THE ZONING ORDINANCE. SIGN
DIMENSIONS TO BE DETERMINED AT A LATER
DATE.

HENSLEY LAMKIN RACHEL, INC. 14881 QUORUM DR#550 DALLAS, TX-75254 CONTACT PERSON -JUAN TORRES (sr.proj manager) EMAIL - juan@hlrinc.net