



0.99 acres - 1 Commercial Lot

Suite 700


Dallas, Tx 75201

www.brussodesigns.com

FRONT



METAL: 102.1 SQ.FT. STONE: 428.2 SQ.FT SIDING: 253.1 SQ.FT. STUCCO: 62.1 SQ.FT. TOTAL: 845.5 SQ.FT.

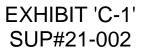


002-21
07/16/21
Author
_SUP#21-002_

SK-301

MASONRY PERCENTAGE: (STONE) 15%



PATIO METAL: 176.6 SQ.FT. STONE: 141.7 SQ.FT. SIDING: 109.9 SQ.FT. STUCCO: 498.3 SQ.FT. TOTAL: 926.5 SQ.FT.

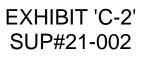

BRD Project No.	002-21
Date	07/16/2
Drawn by	Author
Case No.	SUP#2





Suite 700

Dallas, Tx 75201



REAR METAL: 102.1 SQ.FT. STONE: 428.2 SQ.FT. SIDING: 253.1 SQ.FT. STUCCO: 62.1 SQ.FT. TOTAL: 845.5 SQ.FT.

### EXHIBIT 'C-3' SUP#21-002

### EXTERIOR ELEVATIONS

BRD Project No.	002-21
Date	07/16/2
Drawn by	Autho
Case No.	Check

# SK-302

Scale





1	Drive-Thru Elevation	(SOUTH)



6/23/2021 6:28:09 PM

214.459.3292 P www.brussodesigns.com

# Java Lounge Coffee Shop

Being a portion out of the Samuel West Survey, Abstract 1648 City of Mansfield, Tarrant County, Texas and 06-22-2021 0.99 acres - 1 Commercial Lot

No.	Description	Date
2	SUP Submittal	06/02/21
3	SUP Submittal	06/22/21
4	SUP Submittal	07/16/21



DRIVE THRU METAL: 76.3 SQ.FT. STONE: 527.3 SQ.FT. SIDING: 352.8 SQ.FT. STUCCO: 0 SQ.FT. TOTAL: 956.4 SQ.FT.


### EXHIBIT 'C-4' SUP#21-002


### EXTERIOR ELEVATIONS

BRD Project No.	002-21
Date	07/16/2
Drawn by	Author
Case No.	Checke

# SK-303

Scale

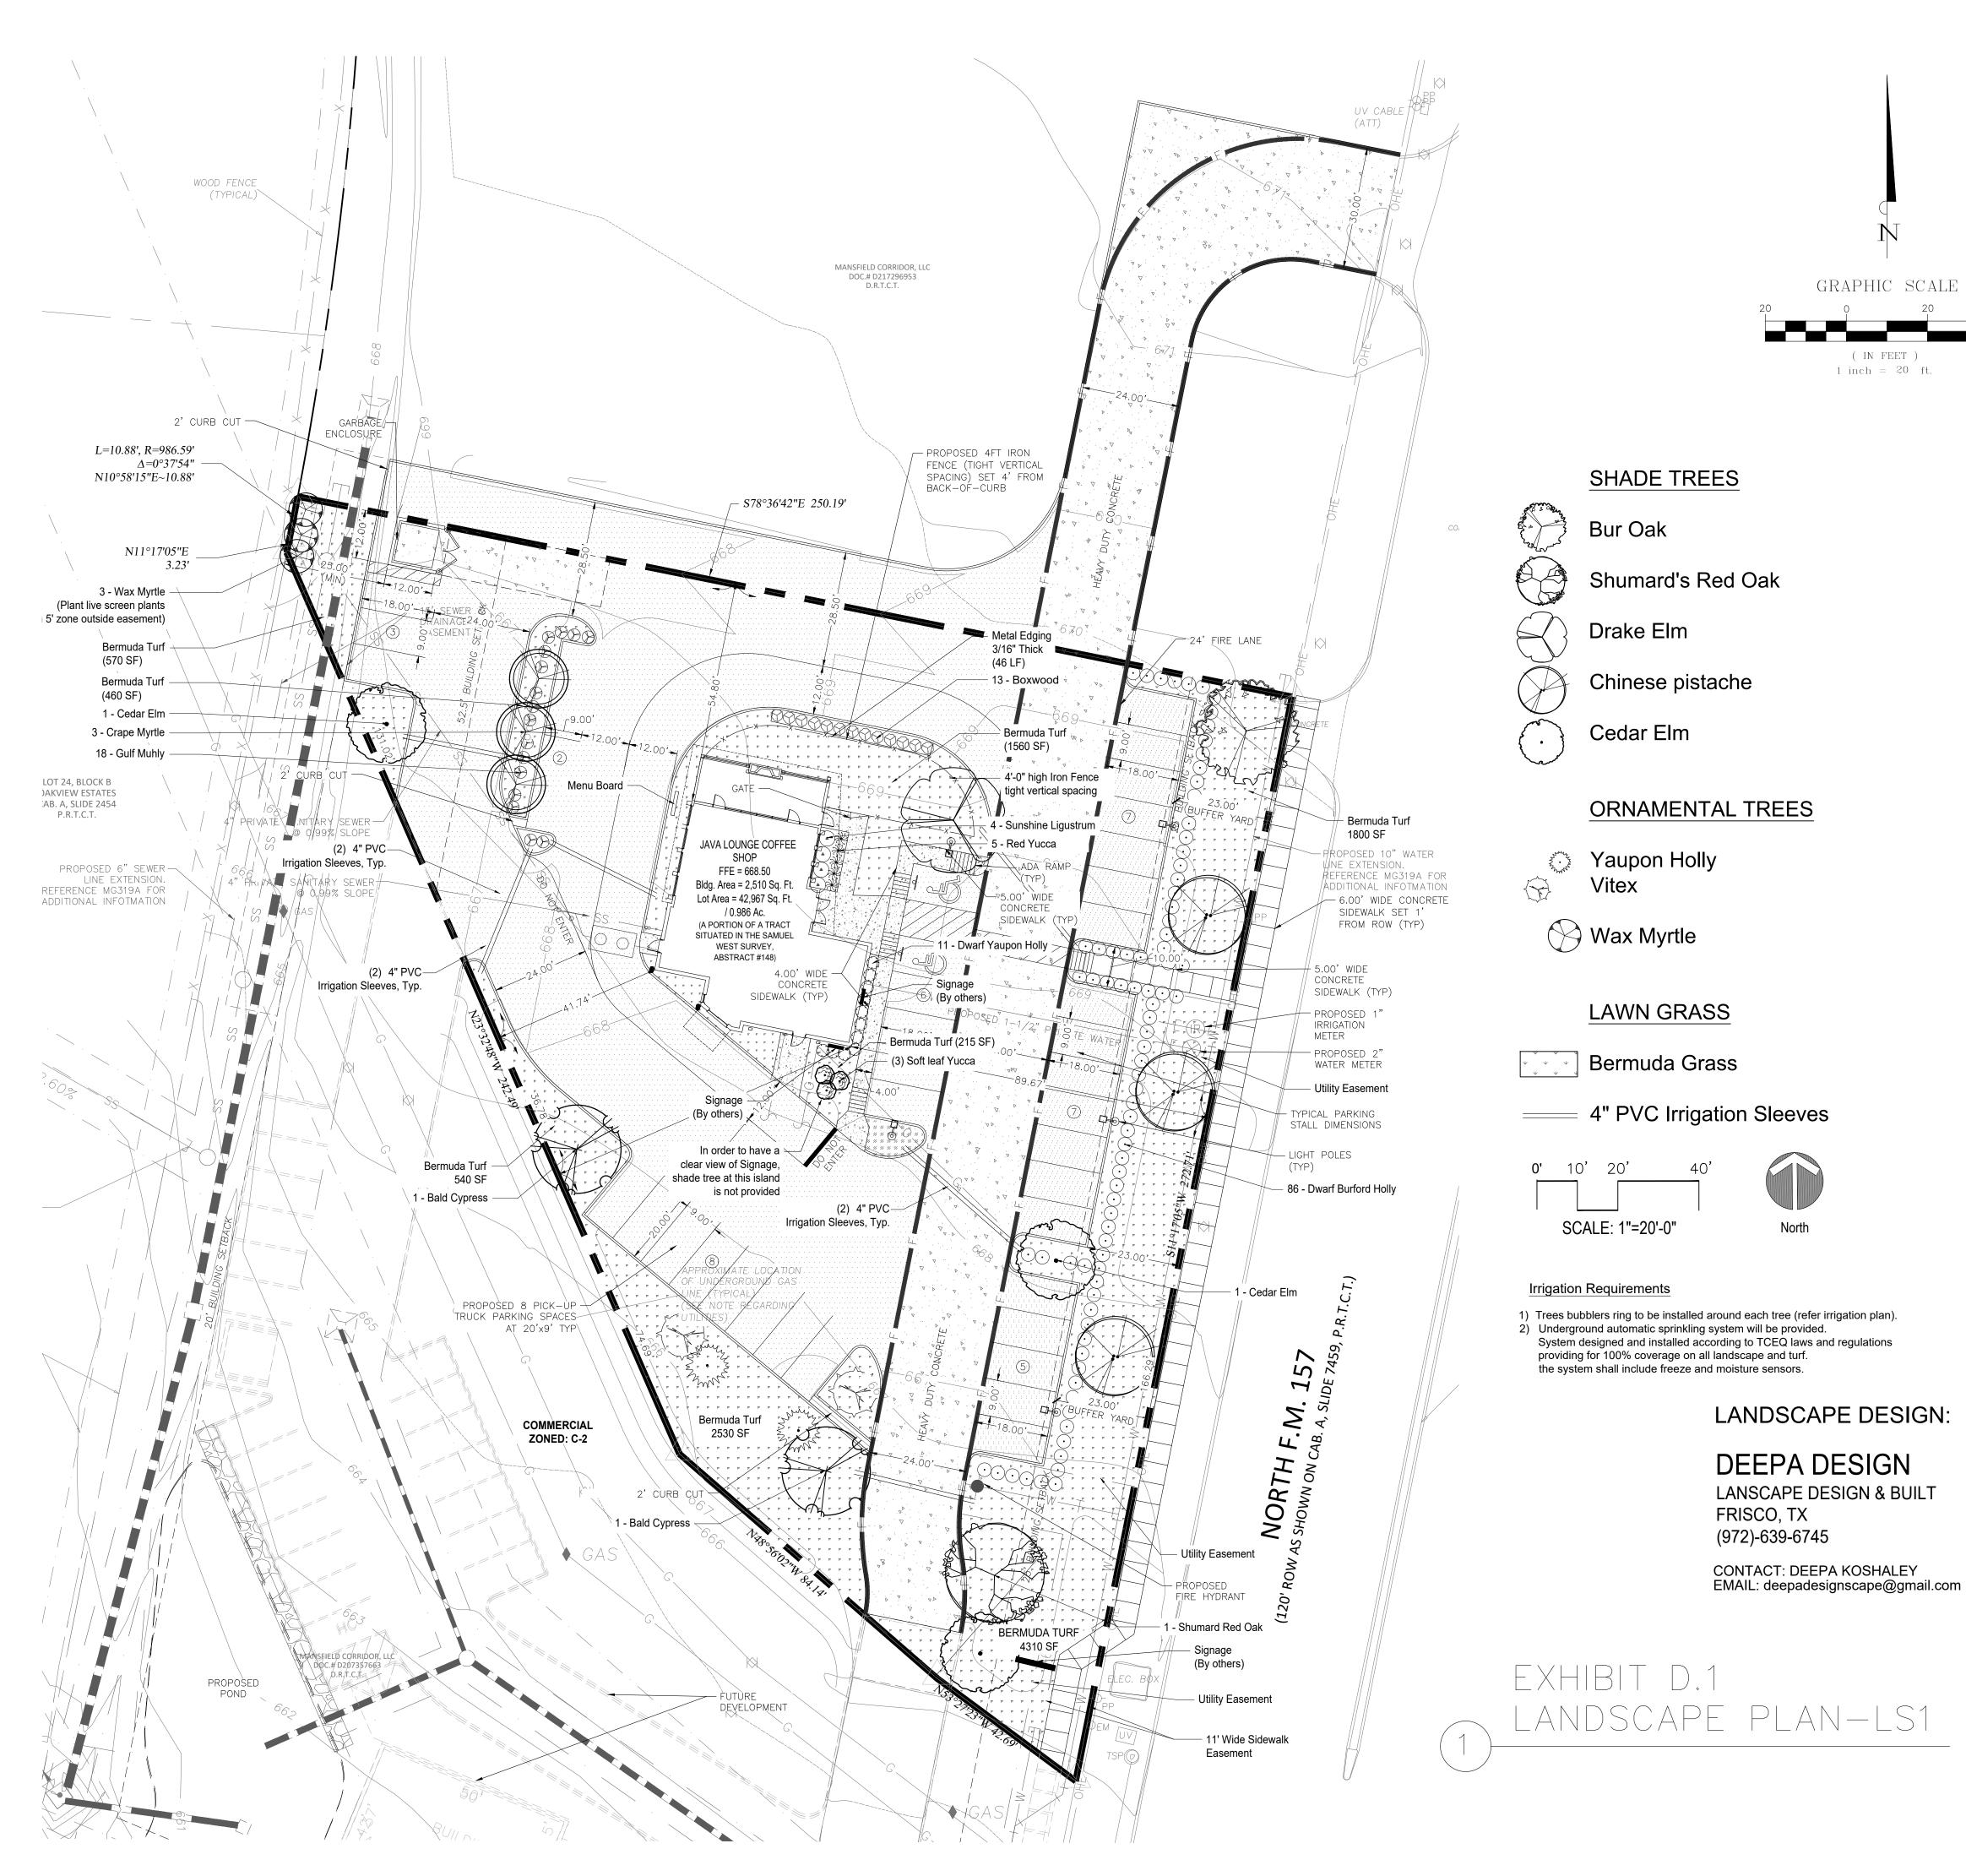

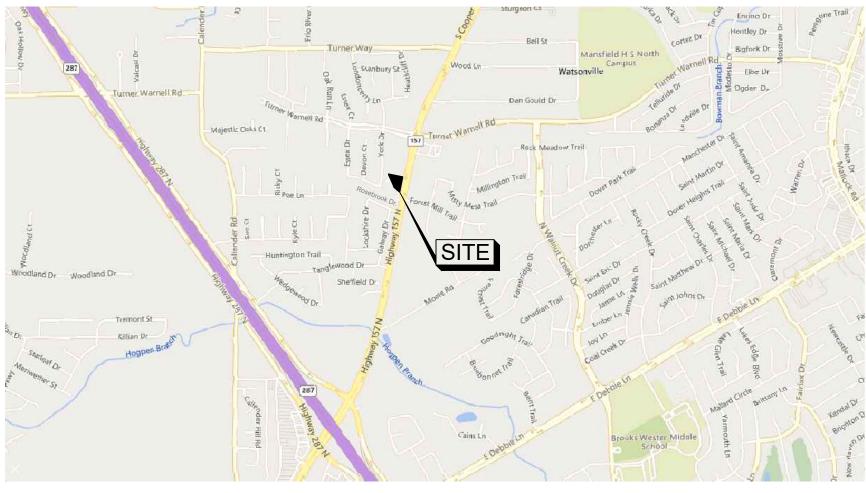

### VICINITY MAP N.T.S.

BOTANICAL NAME	COMMON NAME	QUANTITY	SIZE	NOTES
SHADE TREE				
Quercus macrocarpa	Bur Oak	1 EA.	3.5" cal., 7' Height	B. & B., Single trunk, Well branched with Central Leader
Quercus shumardii	Shumard's Red Oak	1 EA.	3.5" cal., 7' Height	B. & B., Single trunk, Well branched with Central Leader
Ulmus parvifolia 'Drake'	Drake Elm	1 EA.	3.5" cal., 7' Height	B. & B., Single trunk, Well branched with Central Leader
Ulmus crassifolia	Cedar Elm	3 EA.	3.5" cal., 12'-14' Ht., 6'-7' Spread	B. & B., Single trunk, Well branched with Central Leader, 6' branching height
Taxodium distichum	Bald Cypress	2 EA.	3.5" cal., 12'-14' Ht., 6'-7' Spread	B. & B., Single trunk, Well branched with Central Leader, 6' branching height
Pistacia chinensis	Chinese pistache	3 EA.	3.5" cal., 7' Height	B. & B., Single trunk, Well branched with Central Leader
ORNAMENTAL TREES				
Ilex vomitoria	Yaupon Holly (Tree form)	2 EA.	6' Ht. Min	B & B., Multi-trunk, 3 to 5 canes, 2" cal. Canes min., Well branched. Speciman
Lagerstroemia indica - 'Watermelon Red'	Crape Myrtle - Watemelon Red	3 EA.	8'-10' Ht., 4'-5' Spread	B. & B., Multi-trunk, 3 to 5 canes, 1" cal. cane min. Well branched
Vitex agnus-castus	Texas Vitex	2 EA.	6' Ht. Min, 3' Spread Min.	B & B., Single trunk, Well branched, Speciman
SHRUBS				
llex cornuta 'Burfordii Nana'	Dwarf Burford Holly	86 EA.	5 gal., 24" min. Ht., 18" min. spread	Container, Well branched full to ground, Plant 30" on center
Hesperaloe parviflora	Red Yucca	5 EA.	5 gal.	
Ilex vomitoria 'Nana'	Dwarf Yaupon Holly	11 EA.	5 gal., 24" min. Ht., 18" min. spread	Container, Well branched full to ground, Plant 30" on center
Buxus microphylla japonica ' Winter Gem'	Winter Gem Boxwood	13 EA.	1 gal.	Container, Well branched full to ground, Plant 18" on center
Yucca recurvifolia	Soft Leaf Yucca	3 EA.	3 gal., Shrub-like	36" on center
Ligustrum sinense 'Sunshine'	Sunshine' Ligustrum	4 EA.	3 gal.	Container, Well branched full to ground, Plant 4' on center
Myrica cerifera hedge	Wax Myrtle	3 EA.	15 gal., 3" cal min. 6'-8' min. Ht.	
Muhlenbergia capillaris	Gulf Muhly	16 EA.	5 gal.	
MISCELLANEOUS				
Cynodon dactylon	Bermuda Grass/	12210 Sq. Ft.	Solid Sod	Hydromulch (if season allows), Staggered tight joints, sand filled and rolled
Metal Edging		450 Ln. Ft.	3/16" x 4" Green	Staked and set 1" above adjacent paving
Mulch			1" depth	Decomposed hardwood mulch



### DEVELOPER:

## DFL PROPERTIES ONE, LLC

2009 ESTO PARK RD. SOUTHLAKE, TX 76092 (817) 307-8105 CONTACT: MICHAEL DEESE EMAIL: MICHAEL@DEESE.LIFE

### OWNER:

## MANSFIELD CORRIDOR, LLC

1019 WALNUT FALLS CIRCLE MANSFIELD, TX 76063 (817)817) 456-4302 CONTACT: ROY ENGLISH EMAIL:JUDGEROYENGLISH@AOL.COM

## ENGINEER:

# MAZIDJI GROUP

11105 FERNALD AVE. DALLAS, TX 75218 (214) 663-1068 CONTACT: COSTA MAZIDJI, PhD, PE EMAIL: costa@mazidjigroup.com

# SPECIFIC USE PERMIT LANDSCAPE PLAN JAVA LOUNGE COFFEE SHOP BEING A PORTION OUT OF THE SAMUEL WEST SURVEY,

ABSTRACT 1648 CITY OF MANSFIELD, TARRANT COUNTY, TEXAS DATE OF PREPARATION 06/01/2021 0.99 ACRES 1 COMMERCIAL LOT CASE NUMBER: SUP # 21-002

- SOIL PREPARATION
- PART 1 GENERAL A. DESCRIPTION
- 1. PROVIDE COMPLETE GRADING AND SOIL PREPARATION, INCLUDING
- AMENDMENTS, AS SPECIFIED HEREIN.
- EXAMINATION 1. EXAMINE SITE TO VERIFY REQUIRED ROUGH GRADING HAS BEEN COMPLETED
- CORRECTLY PRIOR TO BED PREPARATION WORK. 2. EXAMINE SITE TO VERIFY THAT ALL INVASIVE PLANTS AND THEIR ROOTS HAVE BEEN REMOVED PRIOR TO BED PREPARATION WORK.
- APPROVALS 1. ALL 'APPROVED EQUAL' MATERIALS MUST BE APPROVED BY
- LANDSCAPE DESIGNER/ ARCHITECT.
- PART 2 PRODUCTS
- A. MATERIALS
- 1. COMPOST: 1.1 DECOMPOSED WOOD PRODUCT OR COMPOST
- 1.2 SOLE SOURCE "SOIL BUILDING SYSTEMS" 972-831-8181
- 2. FERTILIZERS AND SUPPLEMENTS:
- 2.1 A 6-2-4 GRANULAR FERTILIZER WITH A WATER SOLUBLE SLOW RELEASE ORGANIC BASE SUCH AS GREENSENSE, OR SUSTANE, OR APPROVED EQUAL.
- 3. MULCH
- 3.1 SHALL BE SHREDDED HARDWOOD MULCH, SHREDDED PINE BARK MULCH, SHREDDED NATIVE MULCH, OR APPROVED EQUAL MUST BE 1" OR 2" TYPE. THE  $1^{"}-2^{"}$  PINE BARK ARE NOT PERMITTED TO BE USED IN BEDS WITHIN 3 FEET OF THE HOTEL AS THE HEAT RELEASE FROM A MULCH FIRE COULD BE SUFFICIENT TO IGNITE THE MATERIALS.
- 3.2 COMBUSTIBLE GROUND COVER MATERIALS ARE NOT PERMITTED ADJACENT TO THE BUILDING FACADE. ONLY INORGANIC NON-COMBUSTIBLE MATERIALS SUCH AS BRICK CHIPS, PEA GRAVEL, AND LAVA ROCK, NOT PINE BARK NUGGETS, SHOULD BE PLACED IN BEDS WHICH ARE 3 FEET OF THE FULL HOTEL PERIMETER.
- PART 3 EXECUTION
- A. BED PREPARATION AND PREPARATION FOR SOD INSTALLATION
- 1. GENERAL
- 1.1. INSPECT ALL EXISTING CONDITIONS AND OTHER ITEMS OF WORK PREVIOUSLY COMPLETED. DO NOT PROCEED UNTIL DEFECTS ARE CORRECTED. 1.2. INSPECT THAT ALL INVASIVE PLANTS AND THEIR ROOTS HAVE BEEN
- REMOVED COMPLETELY. 1.3. ALL AREAS TO BE PREPARED WITH ORGANIC TECHNIQUES ONLY.
- 2. SHRUB BEDS:
- BREAK UP AND TILL EXISTING SOIL TO A DEPTH OF 6 INCHES. 2.1
- ADD A 3 INCH LAYER OF COMPOST TO THE BEDS. 2.2
- TILL EXISTING SOIL AND COMPOST TOGETHER TO A TOTAL OVERALL 2.3 DEPTH OF 6 INCHES.
- RAKE OUT ROCKS LARGER THAN 1" DIA. AND CLODS AND FINE GRADE 2.4. THE BEDS TO DRAIN IN APPROPRIATE DIRECTIONS.
- TOP-DRESS BED WITH A 3 INCH LAYER OF MULCH AFTER PLANTING. 2.5. 3. SOD AND SEEDS AREAS:
- 3.1. LIGHTLY CULTIVATE COMPACTED SOIL AND RAKE THE SOIL SMOOTH
- ADD 1/2 INCH COMPOST TO ALL AREAS. 3.2.
- 3.3. FINE GRADE TO DRAIN IN APPROPRIATE DIRECTIONS

### NOTES GENERAL LANDSCAPE

- I. LANDSCAPE CONTRACTORS IS RESPONSIBLE FOR LOCATING ALL UNDERGROUND UTILITIES AND STRUCTURES WHETHER OR NOT SHOWN ON THE PLANS, AND SHALL BE RESPONSIBLE FOR DAMAGE TO SAID UTILITIES OR STRUCTURES CAUSED BY HIS/HER CREW AND SUBCONTRACTORS.
- ALL LAWN AND LANDSCAPE BED AREAS ARE TO BE SEPARATED BY 14 GAUGE STEEL EDGING UNLESS OTHERWISE NOTED ON THE PLANS.
- CONTRACTOR SHALL STAKE OUT TREE LOCATIONS AND BED CONFIGURATION FOR APPROVAL BY OWNER PRIOR TO INSTALLATION.
- CONTRACTOR IS RESPONSIBLE FOR VERIFYING LOCATION OF ALL UNDERGROUND UTILITIES PRIOR TO CONSTRUCTION.
- 5. IT IS THE RESPONSIBITY OF THE CONTRACTOR TO ADVISE THE OWNERS REPRESENTATIVE OF ANY CONDITION FOUND ON-SITE WHICH PROHIBITS INSTALLATION AS SHOWN ON THESE PLANS.
- 6. ALL SHRUB AND GROUNDCOVER BEDS SHALL HAVE A MINIMUM OF (2") TWO INCHES OF HARDWOOD BARK MULCH
- LANDSCAPE EDGING SHALL BE LOCATED AS NOTED ON PLAN. 8. TREES SHALL BE PLANTED A LEAST FIVE (5') FEET FROM ANY UTILITY LINE, AND OUTSIDE ALL UTILITY EASEMENTS AND A THREE (3') CLEAR DIAMETER AROUND FIRE HYDRANTS, UNLESS PRIOR APPROVAL IS GRANTED.
- 9. ALL TREE PLANTED WITHING FIVE (5') FEET OF A CURB. WALK OR DRIVE MUST INCLUDE AN APPROVED RIGID PLASTIC ROOT BARRIER APPROVED BY THE CITY OF MANSFIELD.
- 10. TREES OVERHANGING WALKS AND PARKING AREAS SHALL HAVE A CLEAR TRUNK HEIGHT OF SEVEN (7') FEET.
- 11. TREES OVERHANGING VISIBILITY EASEMENTS OF RIGHT-OF-WAYS SHALL HAVE A MINIMUM CLEAR TRUNK HEIGHT OF SEVEN (7') FEET. 12. TREES OVERHANGING PUBLIC STREET PAVEMENT, DRIVE AISLES, AND FIRELANES
- WILL HAVE A MINIMUM CLEAR TRUNK HEIGHT OF FOURTEEN (14') FEET. 13. TREES PLANTED ON SLOPES WILL HAVE THE SOIL STAIN AT AVERAGE GRADE OF SLOPE.
- 14. NO SHRUBS SHALL BE PERMITTED WITHIN AREAS LESS THAN THREE (3') FEET IN WIDTH. ALL SUCH AREAS SHALL BE GRASS OR OTHER PERMANENT FIXED MATERIAL SUCH AS PAVERS.
- 15. MULTI-TRUNK AND ORNAMENTAL TREES WILL BE ALLOWED IN THE CITY'S RIGHT-OF-WAY WITH STAFF APPROVAL ONLY. MUST BE OUTSIDE AND VISIBILITY TRIANGLES.
- 16. IN MEDIANS, ALL LANDSCAPE MATERIAL, EXCLUSIVE OF TREES, SHALL NOT EXCEED TWO FEET SIX INCHES (2'-6") IN HEIGHT.
- 17. A VISIBILITY TRIANGLE MUST BE PROVIDED AT ALL INTERSECTIONS AS REQUIRED BY THE THROUGHFARE STANDARDS ORDINANCE. SHRUBS ARE NOT TO EXCEED TWO FEET SIX INCHES (2'-6") IN HEIGHT. TREES WILL HAVE A MINIMUM CLEAR TRUNK BRANCHING HEIGHT OF SEVEN (7') FEET.
- 18. ALL PLANT MATERIAL SHALL BE MAINTAINED IN A HEALTHY AND GROWING CONDITION, AND MUST BE REPLACED WITH PLANT MATERIAL OF SIMILAR VARIETY AND SIZE, IF DAMAGED, DESTROYED OR REMOVED.
- 19. LANDSCAPE AREAS SHALL BE KEPT FREE OF TRASH, LITTER AND WEEDS. 20. ALL SIGNAGE AND FENCING SHALL BE CONTINGENT UPON BUILDING INSPECTION DEPARTMENT APPROVAL
- 21. AN AUTOMATIC IRRIGATION SYSTEM SHALL BE PROVIDED TO MAINTAIN ALL LANDSCAPE AREAS. OVER SPRAY ON STREETS AND WALKS IS PROHIBITED. A PERMIT FROM THE BUILDING INSPECTION DEPARTMENT IS REQUIRED FOR EACH IRRIGATION SYSTEM. IMPACT FEES MUST BE PAID TO THE DEVELOPMENT SERVICES DEPARTMENT FOR SEPARATE IRRIGATION METERS PRIOR TO ANY PERMIT RELEASE.
- 22. SUBSURFACE DRAINAGE IN PARKING LOT MEDIANS; ALL MEDIANS THAT HAVE TREES PROPOSED WILL REQUIRE OVER-EXCAVATION TO REMOVE COMPACTED SOIL TO A DEPTH OF 4-FEET. A PERCOLATION TEST SHALL BE PERFORMED AFTER EXCAVATION TO DETERMINE IF FURTHER SUBSURFACE DRAINAGE IS REQUIRED. PROVIDE PERCOLATION RESULTS TO LANDSCAPE ARCHITECT.

- LANDSCAPE PLANTING PART 1 - GENERAL
- A. SPECIAL CONDITIONS

- TO OWNER'S REPRESENTATIVE.
- AND INSECT INFESTATION.
- REFERENCE STANDARDS
- AMERICAN NATIONAL STANDARDS INSTITUTE, INC.
- 3. HORTUS THIRD, CORNELL UNIVERSITY, 1967. C. PREPARATION
- 6. COORDINATION WITH IRRIGATION SYSTEM
- PLANTING OPERATIONS COMMENCE.
- TO THE IRRIGATION SYSTEM.
- INCLUDING TREES.
- PREVENT ROOT GRADING.
- DEVELOPMENT
- COLLAR INTACT.

- A PERIOD OF ONE YEAR.
- SHOULD BE REJECTED. WARRANTEE:
- THE DATE REPLACEMENT IS MADE
- OF INITIAL ACCEPTANCE.

PART 3 - EXECUTION

- PREPARATION FOR PLANT MATERIAL INSTALLATION Α 1. EXAMINE THE SUB-GRADE UPON WHICH THE WORK IS TO BE
- HAVE BEEN CORRECTED PRIOR TO PROCEEDING. TIME FOR PLANTING
- STAKE LOCATIONS FOR TREES PRIOR TO DIGGING HOLES.
- BE LEVEL WITH THE SURROUNDING GRADE.
- EXISTING GRADE OF SOIL
- REMOVE PRIOR TO MULCHING.

- OFF SITE, OR AS DIRECTED BY THE OWNER. SHRUBS, TALL GRASSES AND PERENNIAL PLANTING:
- TO INSTALLATION.
- SOD PLANTING:
- WATER ALL AREAS OF THE SOD UNTIL THOROUGHLY WET. TO OBTAIN A UNIFORM, SMOOTH FINISH,
- SEED PLANTING:
- APPLY SEED EVENLY AT THE RATE RECOMMENDED.



1. COMPLY WITH APPLICABLE FEDERAL, STATE, COUNTY AND LOCAL REGULATIONS REGULATIONS GOVERNING LANDSCAPE MATERIALS AND WORK

2. EMPLOY ONLY EXPERIENCE PERSONNEL FAMILIAR WITH REQUIRED WORK PROVIDE ADEQUATE SUPERVISION BY A QUALIFIED FOREMAN WITH A MINIMUM OF TEN (10) YEARS EXPERIENCE WITH PROJECTS OF SIMILAR COMPLEXITY 3. DO NOT MAKE SUBSTITUTIONS OF TREE, SHRUB AND GRASS MATERIALS. IF REQUIRED MATERIAL IS NOT OBTAINABLE, SUBMIT PROOF OF NON-AVAILABILITY

4. PROVIDE QUANTITY, SIZE, GENUS, SPECIES AND VARIETY OF TREES AND SHRUBS INDICATED AND SCHEDULED FOR LANDSCAPE WORK WHICH COMPLY WITH APPLICABLE REQUIREMENTS OF ANSI Z60.1 AMERICAN STANDARD FOR NURSERY STOCK, AND ANY APPLICABLE STATE AND FEDERAL LAWS CONCERNING DISEASE

1. AMERICAN STANDARDS FOR NURSERY STOCK, APPROVED NOV. 6, 1996 BY

2. SHINNERS & MAHLER'S, ILLUSTRATED FLORA OF NORTH CENTRAL TEXAS, BOTANICAL RESEARCH INSTITUTE OF TEXAS (BRIT), FORT WORTH, TEXAS, 1999.

4. COORDINATION WITH BUILDING AND ENGINEERING PROJECT ACTIVITIES. 5. COORDINATE THE WORK OF THIS SECTION WITH THAT OF REGULAR AND EMERGENCY WATER UTILITY ACTIVITIES ON THE SITE.

6.1. THE UNDERGROUND IRRIGATION SYSTEM MUST BE INSTALLED PRIOR TO COMMENCEMENT OF THE PLANTING OPERATIONS. 6.2. THE IRRIGATION SYSTEM SHALL BE OPERATIONAL AT THE TIME THAT

6.3. COORDINATE WORK WITH THE IRRIGATION CONTRACTOR TO PREVENT DAMAGE

D. ALL PLANT MATERIALS FOR THIS PROJECT SHALL BE NURSERY-GROWN,

1. CONTAINER GROWN PLANTS SHALL HAVE BEEN STEPPED-UP AS NECESSARY TO 2. CONTAINER GROWN PLANTS SHALL HAVE BEEN IN THE CONTAINER FOR A MINIMUM OF SIX (6) MONTHS PRIOR TO DELIVERY TO THE SITE TO ENSURE ADEQUATE ROOT

3. THE 'ROOT FLARE' OF ALL TREES AND SHRUBS SHALL NOT BE COVERED WITH SOIL. E. THE FOLLOWING TREE CARE PROCEDURES SHALL BE ADHERED TO: 1. DO NOT MAKE FLUSH CUTS OR LEAVE STUBS WHEN PRUNING. LEAVE THE BRANCH

2. DO NOT USE ANY TYPE OF PRUNING PAINT ON WOUNDS. 3. DO NOT USE ANY TYPE OF TREE WRAP, EXCEPT, TRUNKS MAY BE WRAPPED WITH BURLAP DURING PLANTING OPERATIONS ONLY. 4. DO NOT STAKE OR GUY ANY TREES. IN SPECIAL CASES, TREE STAKING MAY BE NECESSARY TO PRESERVE A TREE THAT CONTINUES TO BLOW OVER. THE CONTRACTOR WILL BE RESPONSIBLE FOR ANY TREES THAT NEED STAKING FOR

5. DO NOT HANDLE ANY TREE BY ITS TRUNK. ANY TREE HANDLED IN SUCH A MANNER

1. UNCONDITIONALLY WARRANT ALL PLANTS FOR A PERIOD OF ONE (1) YEAR AFTER THE DATE OF INSTALLATION INITIAL ACCEPTANCE. REPLACE MATERIALS NOT IN VIGOROUS, THRIVING CONDITION AS SOON AS WEATHER PERMITS AFTER NOTIFICATION BY OWNERS THAT THE PLANTS HAVE DIED OR ARE OTHER WISE NOT ACCEPTABLE. GUARANTEE REPLACEMENT PLANTS FOR ONE YEAR, STARTING FROM

2. WARRANTY EXCLUDES REPLACEMENT OF PLANTS BECAUSE OF INJURY BY STORM, NATURAL DROUGHT, DROWNING, HAIL FOR FREEZING, IF REASONABLE CARE WAS TAKEN TO ADEQUATELY PROTECT THE MATERIAL, AND IN THE OPINION OF THE OWNER'S REPRESENTATIVE THAT THE PROBLEM OCCURRED AFTER THE DATE

PERFORMED. VERIFY GRADE ELEVATIONS AND VERIFY THAT BEDS HAVE BEEN LEFT LOW BY OTHER TRADES. OBSERVE THE CONDITIONS UNDER WHICH THE WORK IS TO BE PERFORMED AND CONFIRM THAT UNSATISFACTORY CONDITIONS

CARE IS TO BE TAKEN SO THAT NO PLANTS SIT IN POTS IN THE SUMMER HEAT FOR MORE THAN 1 HOUR. IF PLANTING DURING HOT SEASONS (NOT PREFERRED) PLANTINGS TO BE DONE IN SMALL SECTIONS WITH STOCKPILED PLANTS TO BE PROTECTED FROM THE SUMMER HEAT (SHADE AREAS).

1. DIG PITS WITH ROUGH SIDES AND WHICH HAVE TAPERED WALLS, A MINIMUM OF TWICE THE WIDTH OF THE TREE BALL, A PEDESTAL SHOULD BE LEFT IN THE CENTER OF THE HOLE AND THE TREE BALL SET UPON THAT PEDESTAL. SET PLANTS IN THE CENTER OF THE HOLE AND ON THE PEDESTAL PLUM AND VERTICAL, AND AT SUCH A DEPTH THAT THE CROWN OF THE TREE BALL WILL

ALL PLANTS SHALL BE SET TO MEET THE SAME RELATIONSHIP TO THE FINISHED GRADE OF THE SURROUNDING SOIL THAT THEY BORE TO PREVIOUS

4. BACKFILL WITH EXISTING TOPSOIL AND WATER IMMEDIATELY. 5. FORM AND SHALLOW BASIN SLIGHTLY LARGER THAN THE PIT TO FACILITATE

6. COVER ALL TREE BALLS WITH MINIMUM OF 3 OF SPECIFIED MULCH. EXTEND MULCH OUT TO THE EDGE OF THE TREE PIT, BUT KEEP AWAY FROM TRUNKS. 7. ALL EXCAVATED MATERIAL UNACCEPTABLE FOR REUSE SHALL BE DISPOSED OF

REMOVE CONTAINER AND SET PLANT MATERIAL AT SUCH A LEVEL THAT AFTER SETTLEMENT. THE GROWN OF THE BALL WILL BE AT FINISHED GRADE GENTLY CUT OUTER ROOTS OF ANY ROOTBALLS THAT HAVE POT-BOUND PRIOR

COVER PLANTING BEDS WITH MINIMUM 3 LAYER OF SPECIFIED MULCH, SOD PLANTING.

LAY SOD IN AN ORDERLY MANNER TO COVER ALL BARE SOIL AREAS. ROLL SOD WITH A SOD ROLLER AFTER 24 HOURS AFTER LAYING AND WATERING SOD

4. FILL JOINTS WITH COMPOST IF NECESSARY TO FORM A UNIFORM GRASS LAYER. 5. KEEP SOD ADEQUATELY WATERED UNTIL SOD MAKES A FORM CONNECTION TO THE SOIL.

AREAS SHALL BE RAKED TO A DEPTH OF 1/2", SMOOTH AND FREE OF STONES AND DEBRIS.

3. RAKE AND WATER TO ESTABLISH A FIRM CONNECTION OF THE SEED TO THE SOIL. 4. KEEP SEED AREA MOIST (NOT WET) UNTIL SEED GERMINATES AND GRASS IS APPROX. 1/2" IN HEIGHT. KEEP AREA ADEQUATELY WATERED UNTIL A STAND OF THE GRASS IS ESTABLISHED. 6. RE-SEED TO ESTABLISH A THICK STAND OF GRASS IF NECESSARY


# EXHIBIT D.2 ANDSCAPE NOTES, DETAILS-LS2

LANDSCAPING MAINTENANCE:

The property owner, tenant or agent, shall be responsible for the maintenance of all required landscaping in a healthy, neat, orderly and live-growing condition at all times. This shall include mowing, edging, pruning, fertilizing, irrigation, weeding, and other such activities common to the maintenance of landscaping. Landscaped areas shall be kept free of trash, litter, weeds and other such materials not a part of the landscaping. Plant materials that die shall be replaced with plant materials of similar variety and size.

### <u>DISCLAIMER –</u>

- LANDSCAPE PLANT LIST IS AS PER APPROVED LIST BY CITY OF MANSFIELD
- AND ARE NATIVE/ ADAPTED TO DFW METROPLEX. • WE ARE NOT RESPONSIBLE FOR SURVIVAL OF THE TREES & PLANTS. • LANDSCAPE CONTRACTOR WILL BE RESPONSIBLE FOR OPERATIONAL IRRIGATION.

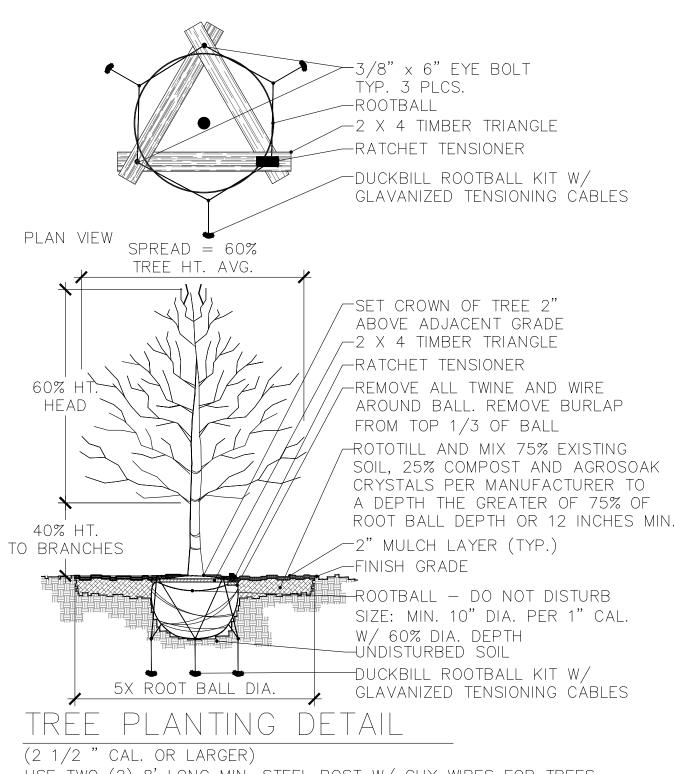

USE TWO (2) 8' LONG MIN. STEEL POST W/ GUY WIRES FOR TREES

SMALLER THAN 2-1/2" CAL. CHECK PERCOLATION RATE. INSTALL TREE SUMP IF UNACCEPTABLE

FOR GUARANTEE.

WRAP RED OAK, LIVE OAK & CADDO MAPLE TREE TRUNKS W/ BURLAP, STARTING AT BASE OF TRUNK EXTENDING UP TO BOTTOM BRANCHING.

### **TYPICAL 'TREE PLANTING PIT' BED PREPARATION** MINIMUMS: USE THE GREATER OF CALIPER OR BALL DIAMETER **B&B BALLS REQUIRE 10:1 BALL TO CALIPER RATIO MINIMUM** CONTAINER RALLS MAY RE SMALLER SO USE CALIPER SIZE


	CONI	AINER BALL	S MAY BE	SMALLER, S	<b>O USE CALIPER</b>
S	B=Sx10	BD=Bx 60%	PD=Bx 5	CD=TDx25%	TD= BDx75%
Tree Size	Min. Root	Min. Root	Tree Pit	Compost	Tree Pit
Caliper Inch	Ball Dia.	Ball Depth	Diameter	Min. Depth	Tilling Depth
* BELOW A	RE TYPICAL	EXAMPLES TO A	AID IN CALC	ULATIONS FOR O	OTHER SIZES
S = 3"	B = 30"	<b>BD</b> = 18"	PD = 150"	CD = 3.75"	TD = 13.5"
S = 6"	B = 60"	BD = 36"	PD = 300"	CD = 6.75"	TD = 27"

### LANDSCAPE DESIGN:

## **DEEPA DESIGN**

LANSCAPE DESIGN & BUILT FRISCO, TX (972)-639-6745

CONTACT: DEEPA KOSHALEY EMAIL: deepadesignscape@gmail.com

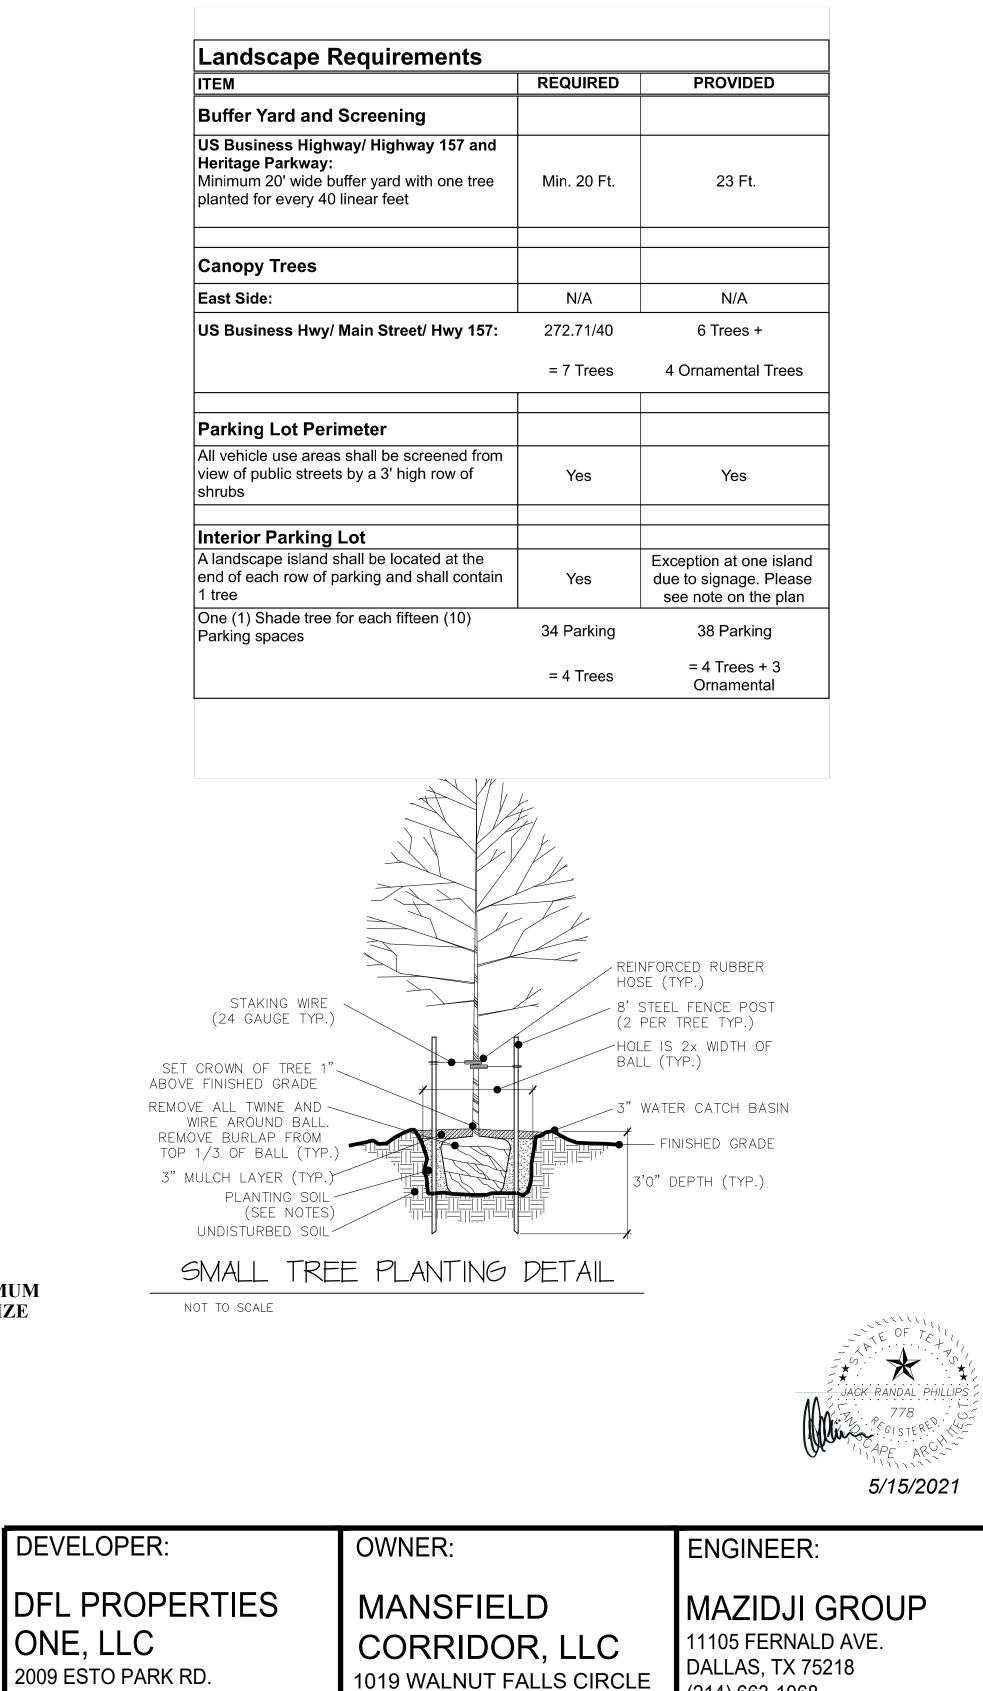


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MANSFIELD, TX 76063 (817)817) 456-4302 CONTACT: ROY ENGLISH EMAIL: JUDGEROYENGLISH@AOL.COM (214) 663-1068 CONTACT: COSTA MAZIDJI, PhD, PE EMAIL: costa@mazidjigroup.com

## SPECIFIC USE PERMIT LANDSCAPE PLAN JAVA LOUNGE COFFEE SHOP BEING A PORTION OUT OF THE SAMUEL WEST SURVEY, ABSTRACT 1648 CITY OF MANSFIELD, TARRANT COUNTY, TEXAS

DATE OF PREPARATION 06/01/2021 0.99 ACRES 1 COMMERCIAL LOT

CASE NUMBER: SUP # 21-002

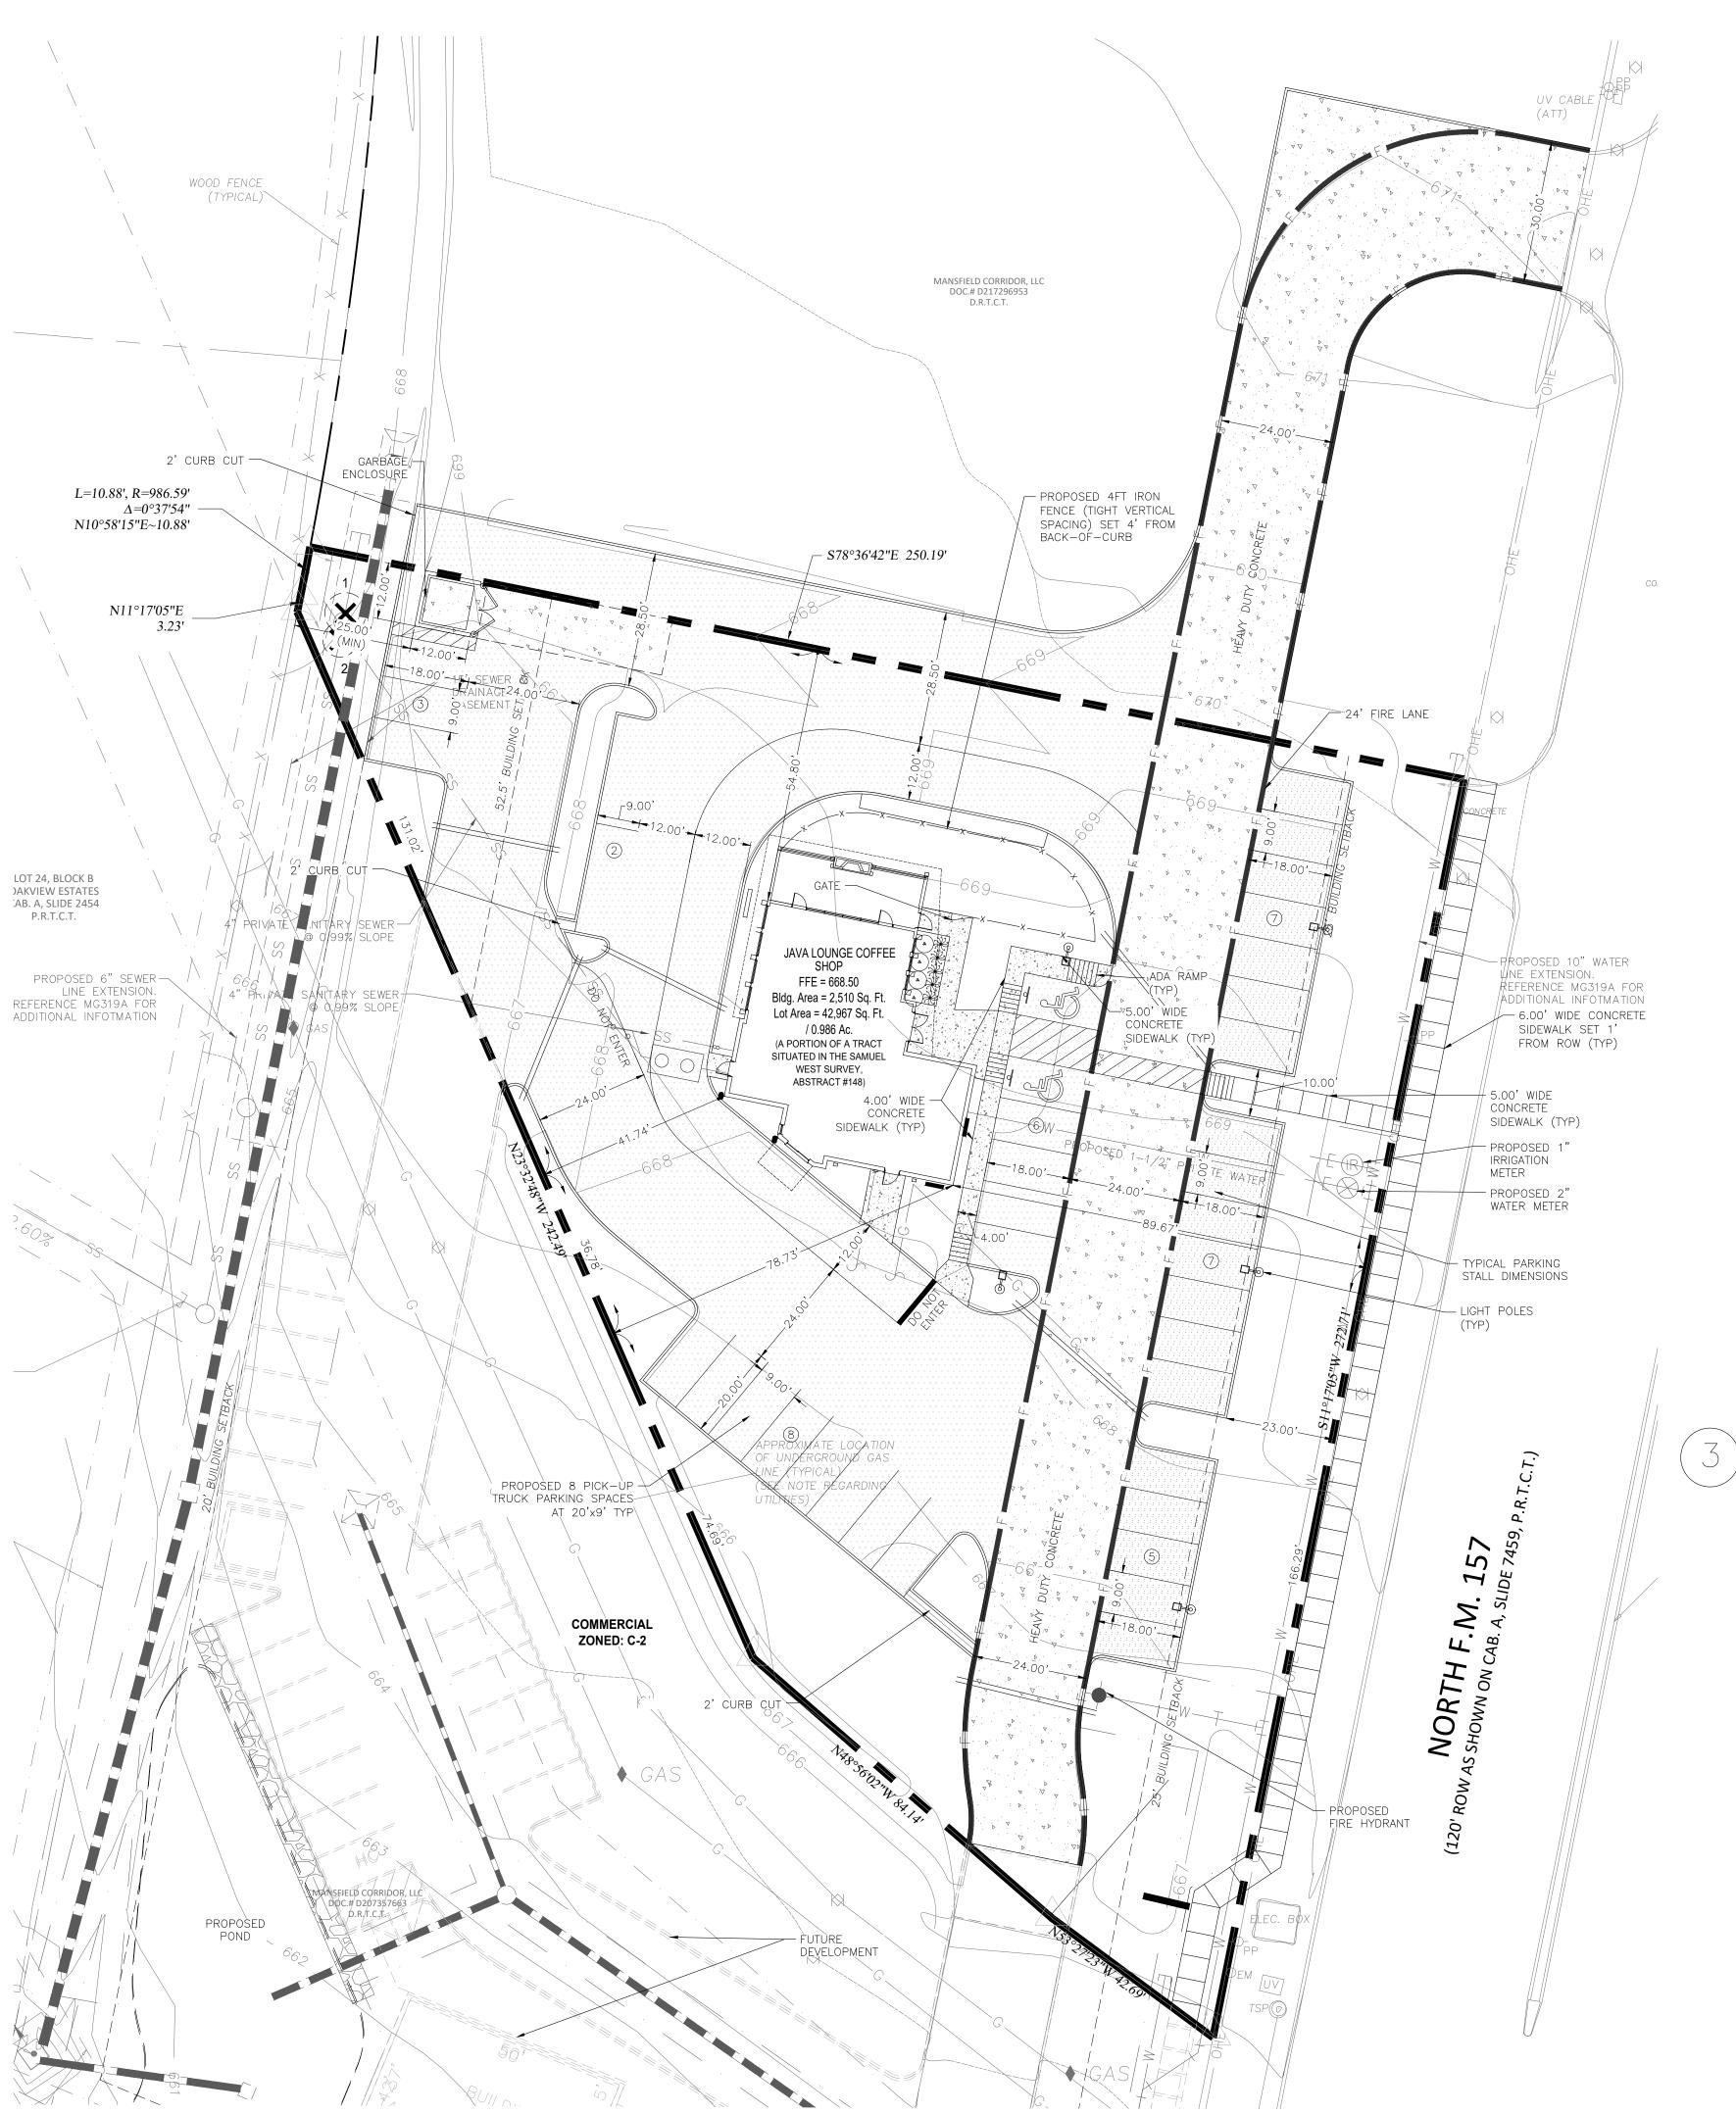

TR	TREE SURVEY							
	SPECIES	REMOVE (IN)	SAVE (IN)	PROTECTED?	TREES TO REPLACE	NOTES		
1	Lacebark Elm	27.5"	No	Yes	N/A	Tree in the middle of the existing storm water channel (blocking storm water flow)		
2	Honey Locust	5"	No	No	N/A	Tree in the middle of the existing storm water channel (blocking storm water flow)		



LEGEND

Tree to be removed

# EXHIBIT D.3 TREE SURVEY -LS3

### LANDSCAPE DESIGN:

DEEPA DESIGN LANSCAPE DESIGN & BUILT FRISCO, TX (972)-639-6745

CONTACT: DEEPA KOSHALEY EMAIL: deepadesignscape@gmail.com



### DEVELOPER:

## DFL PROPERTIES ONE, LLC

2009 ESTO PARK RD. SOUTHLAKE, TX 76092 (817) 307-8105 CONTACT: MICHAEL DEESE EMAIL: MICHAEL@DEESE.LIFE

### OWNER:

## MANSFIELD CORRIDOR, LLC


1019 WALNUT FALLS CIRCLE MANSFIELD, TX 76063 (817)817) 456-4302 CONTACT: ROY ENGLISH EMAIL: JUDGEROYENGLISH@AOL.COM **ENGINEER**:


# MAZIDJI GROUP

11105 FERNALD AVE. DALLAS, TX 75218 (214) 663-1068 CONTACT: COSTA MAZIDJI, PhD, PE EMAIL: costa@mazidjigroup.com

SPECIFIC USE PERMIT LANDSCAPE PLAN JAVA LOUNGE COFFEE SHOP BEING A PORTION OUT OF THE SAMUEL WEST SURVEY, ABSTRACT 1648 CITY OF MANSFIELD, TARRANT COUNTY, TEXAS DATE OF PREPARATION 06/01/2021 0.99 ACRES 1 COMMERCIAL LOT

CASE NUMBER: SUP # 21-002

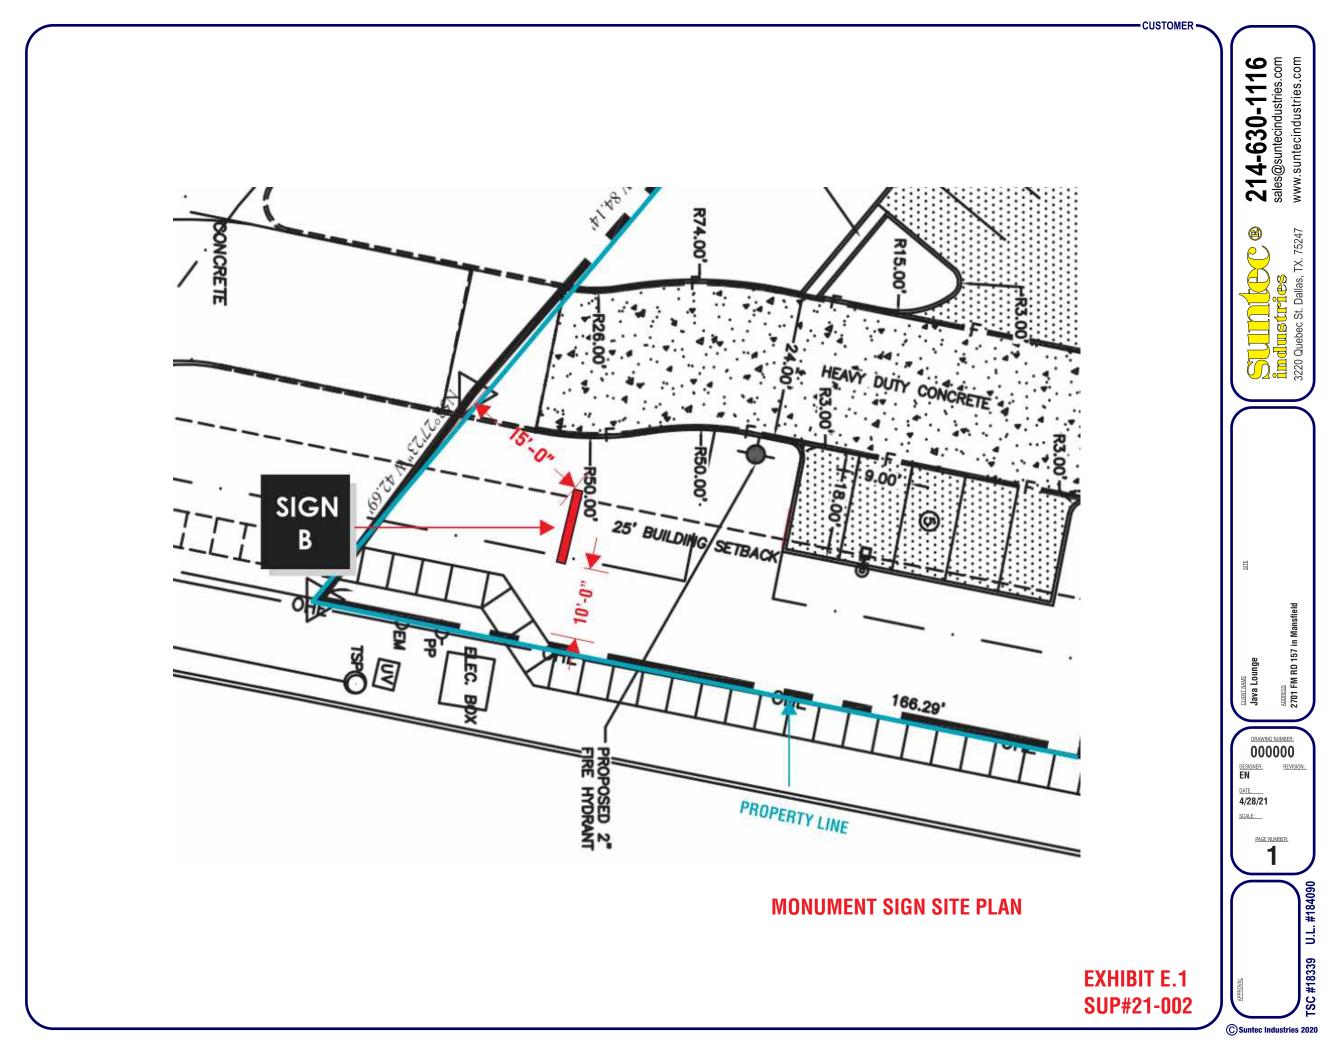

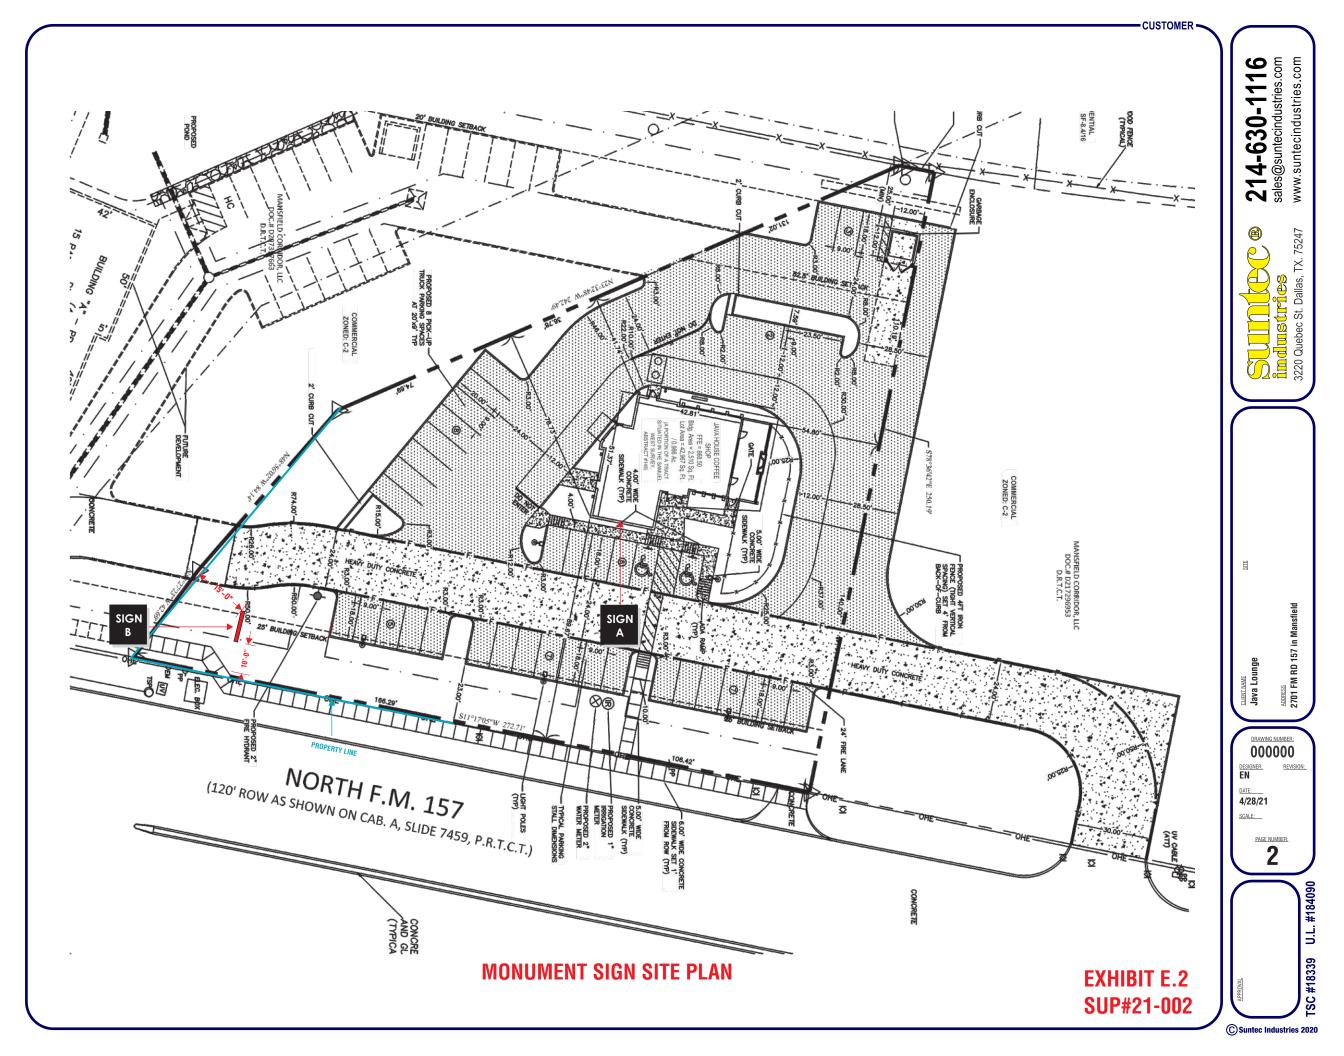



**STOREFRONT ELEVATION** 

SCALE: 1/8"=1'-0"


CUSTOMER -

214-630-1116 sales@suntecindustries.com www.suntecindustries.com

Sullindustries îmdustries 3220 Quebec St. Dallas, TX. 75247

U.L. #184090

TSC #18339

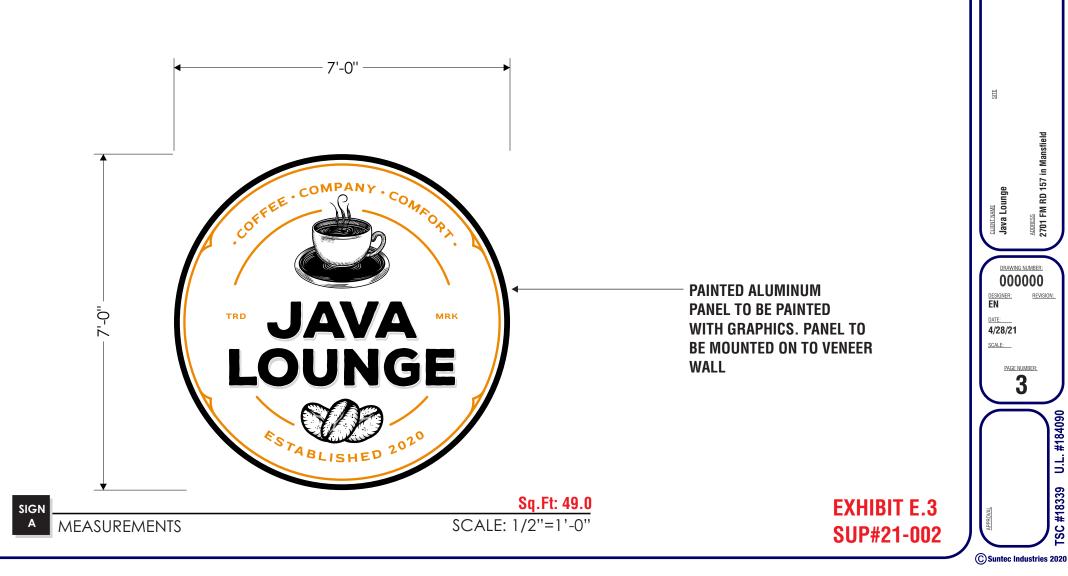


Mansfield, TX Signage Code:

Monument signs may have a maximum height of 10 feet and a maximum sign area of 50 square feet. The sign must be located along the highway frontage of the lot.

Minimum setback. The minimum setback for a monument sign shall be as follow

- (a) Ten feet from the street right-of-way line.
- (b) 15 feet from side

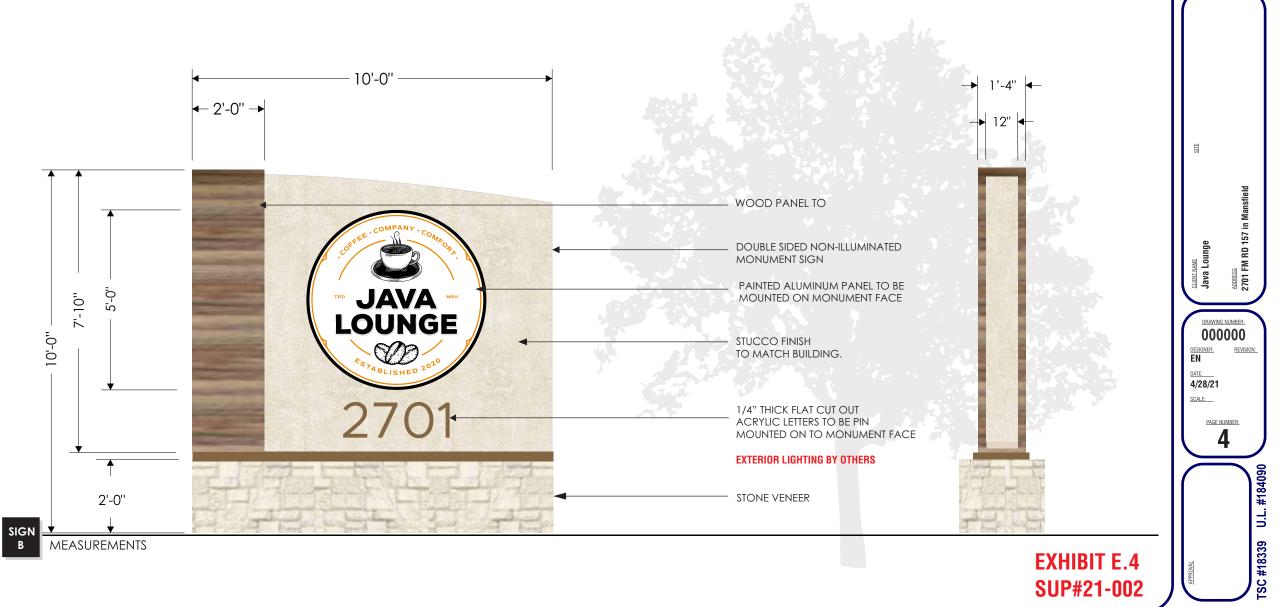

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