

VICINITY MAP

STONELAKE CAPITAL PARTNERS


100 CRESCENT COURT, SUITE 850 DALLAS, TEXAS 75201 214-965-0630

POWERS BROWN ARCHITECTURE

2100 TRAVIS STREET HOUSTON, TEXAS 77002 713-335-0456

DEVELOPMENT SITE PLAN- EXHIBIT B ZC#21-009



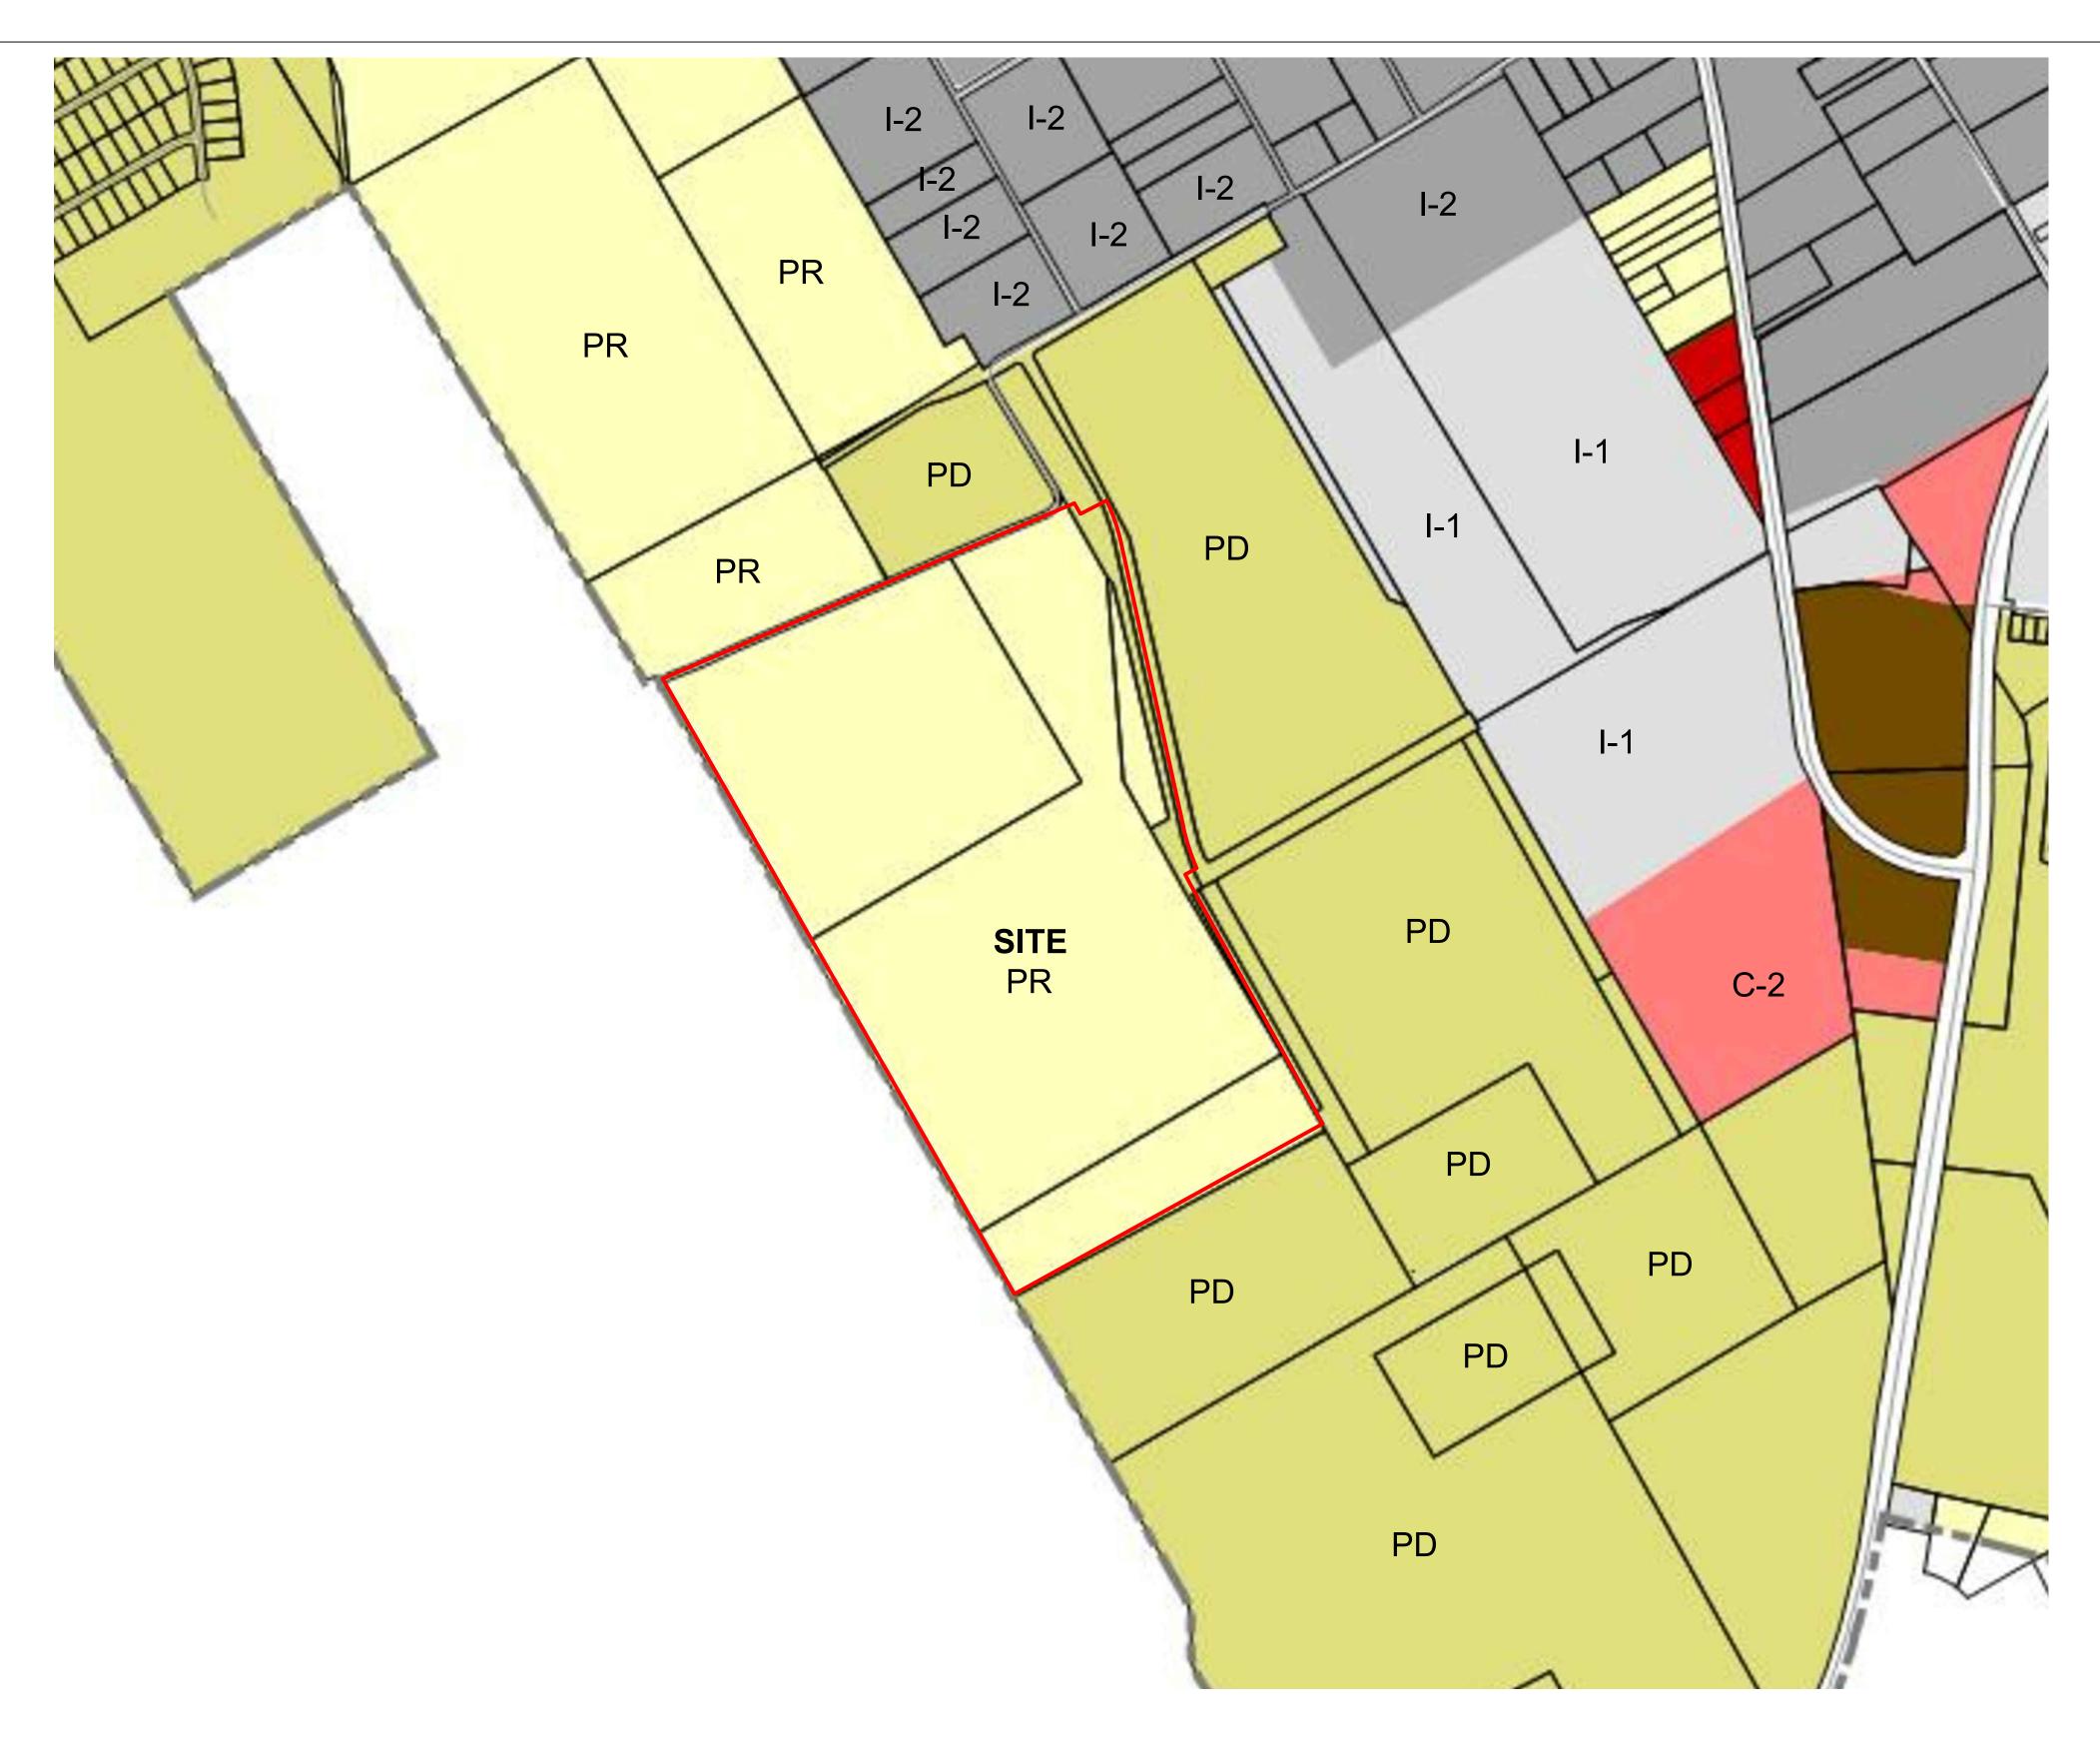

ZONING EXHIBIT

LEGEND 2F C-1 C-2 C-3 C-4 Н 1-1 I-2 MF-1 MF-2 MH OP PD PR SF-12/22 SF-5AC/24 SF-6/12 SF-7.5/12 SF-7.5/16 SF-7.5/18 SF-8.4/16 SF-8.4/18 SF-9.6/20 SP

PROPERTY BND


Freeway Overlay Zones

FREEWAY OVERLAY DISTRICT

SECONDARY FREEWAY OVERLAY DISTRICT

DEVELOPMENT SITE PLAN- EXHIBIT B ZC#21-009




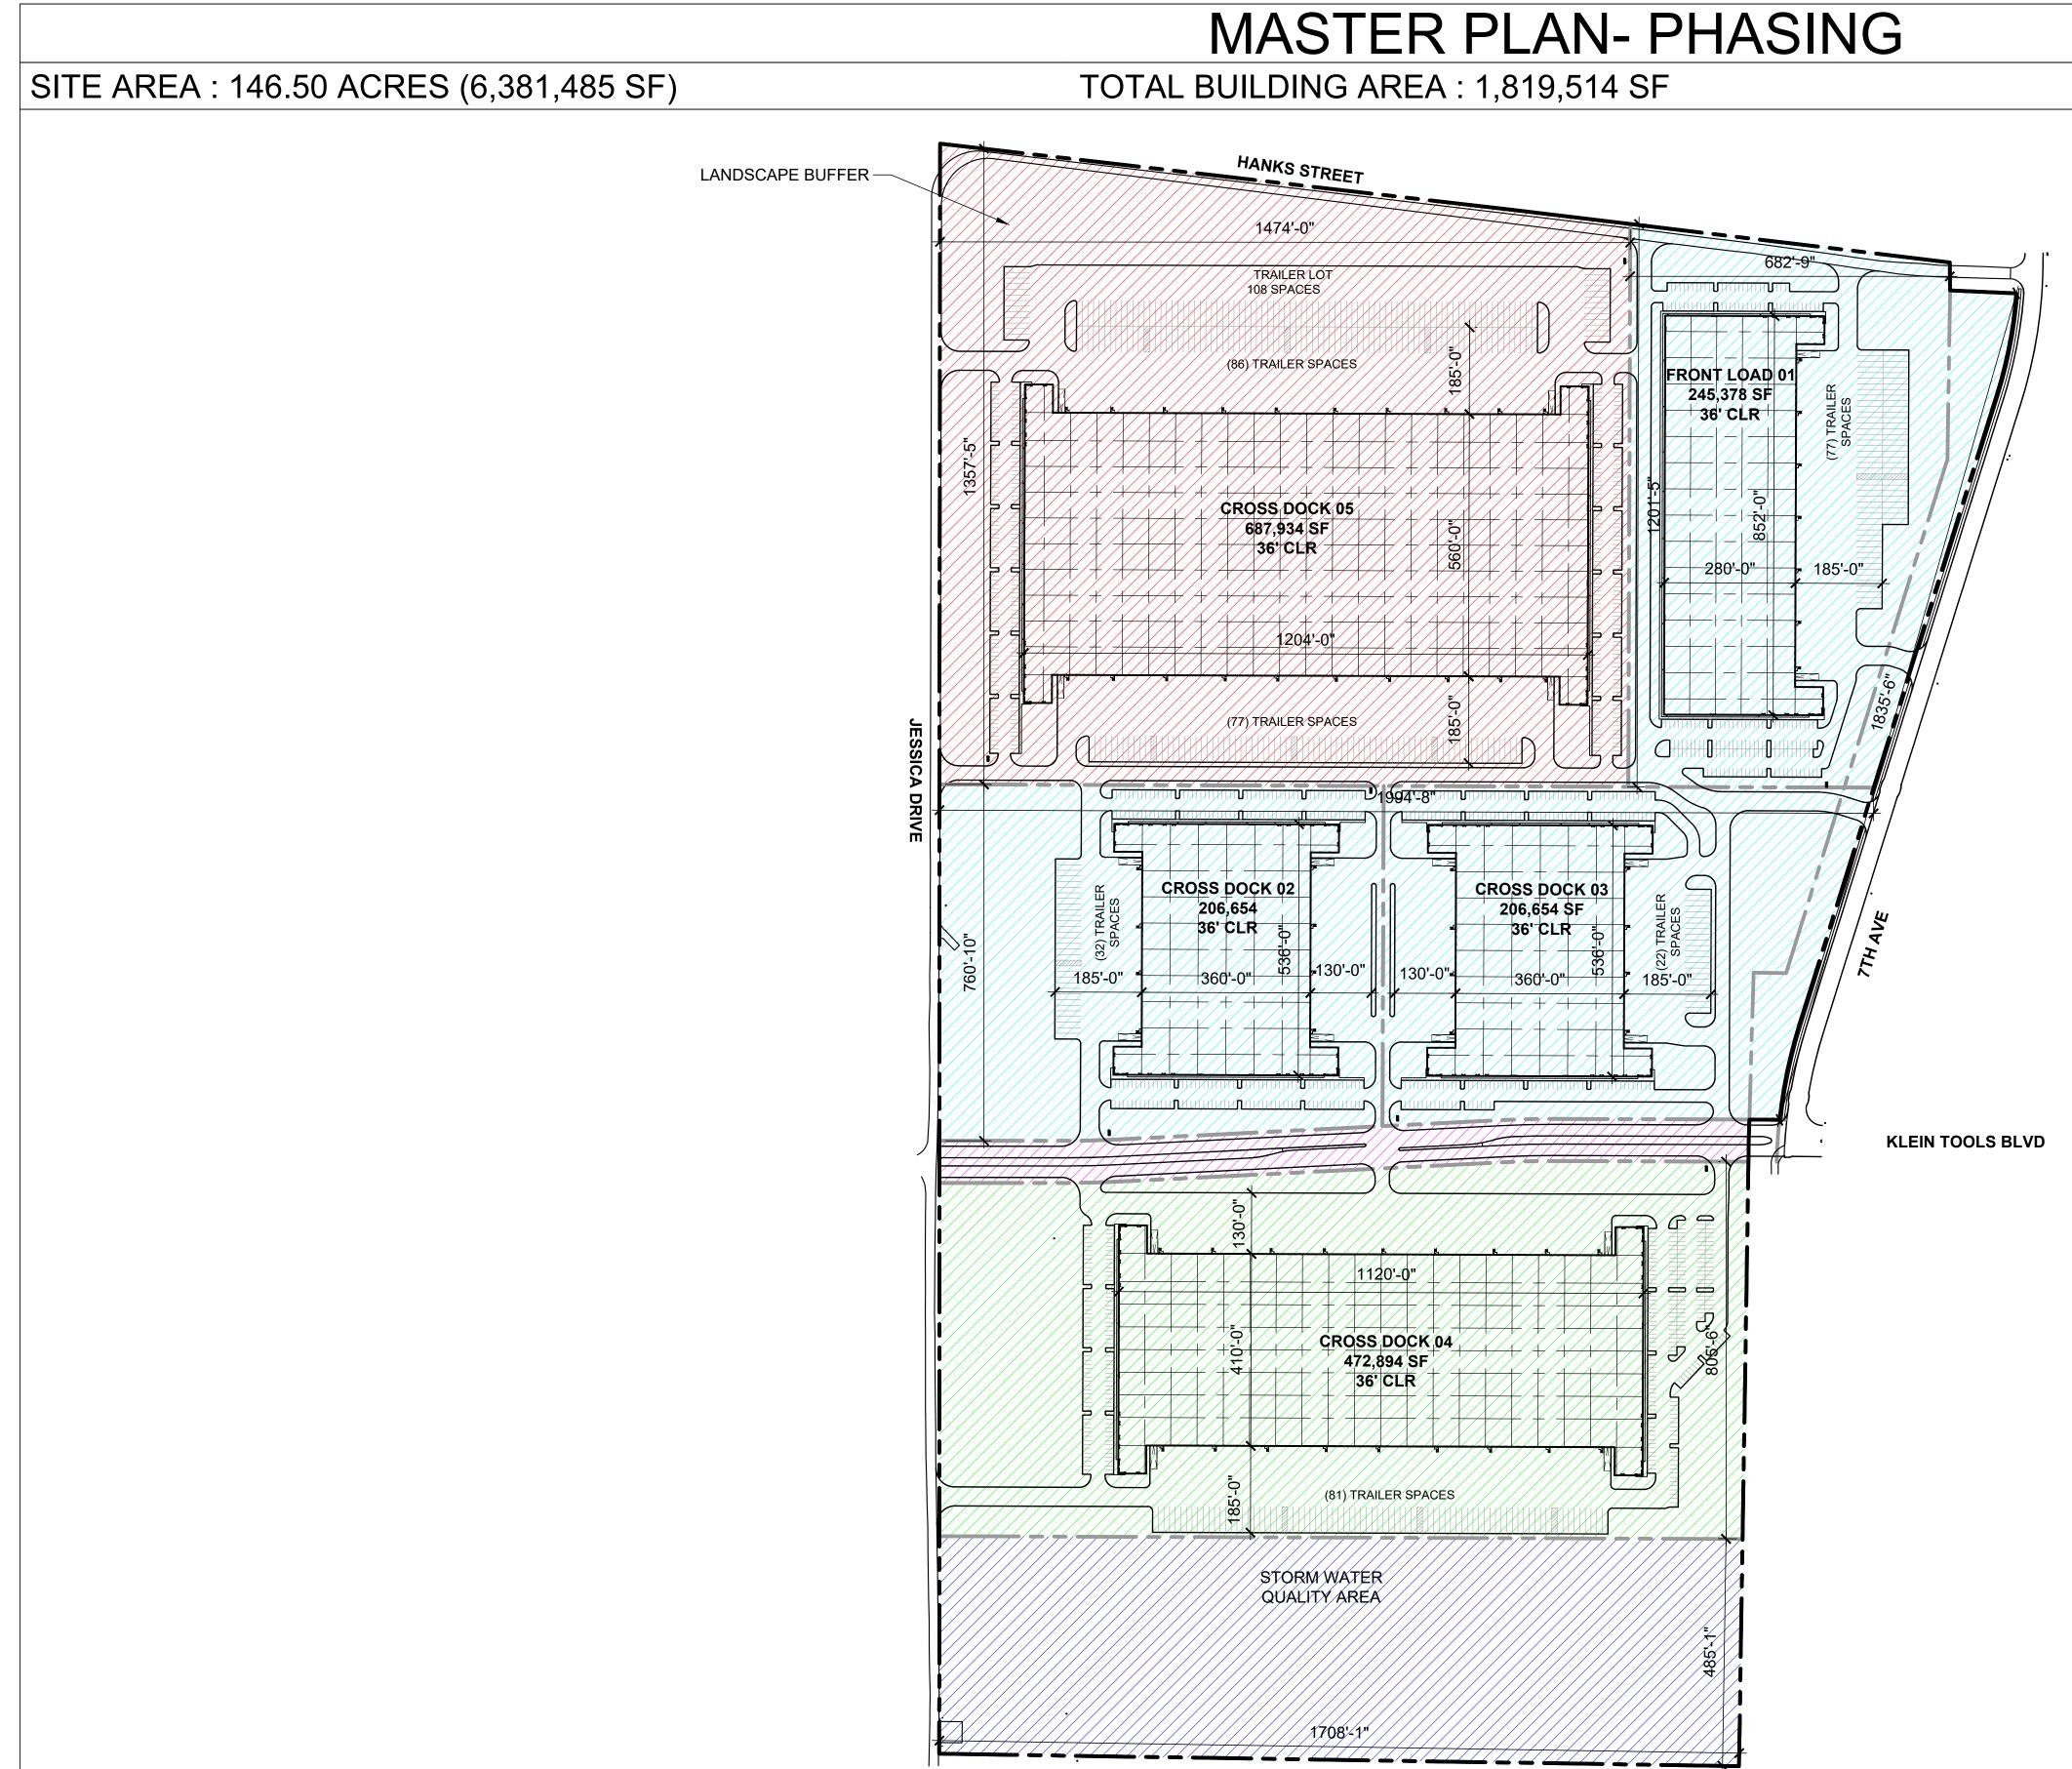


COVERAGE : 28.5 %



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	PHASE I
	SITE AREA: 49.92 AC (2,174,467 SF)
	BUILDING AREA: 658,686 SF
	COVERAGE: 30.3%
	USE: LIGHT INDUSTRIAL
	PHASE II
	SITE AREA: 30.91 AC (1,346,400 SF)
	BUILDING AREA: 472,894 SF
	COVERAGE: 35.1%
	USE: LIGHT INDUSTRIAL
	PHASE III
	SITE AREA: 43.44 AC (1,892,462 SF)
	BUILDING AREA: 687,934 SF
	COVERAGE: 36.4%
	USE: LIGHT INDUSTRIAL
	R.O.W.
	AREA: 3.57 AC (155,633 SF)
	STORM WATER QUALITY
	AREA: 18.65 AC (812,523 SF)

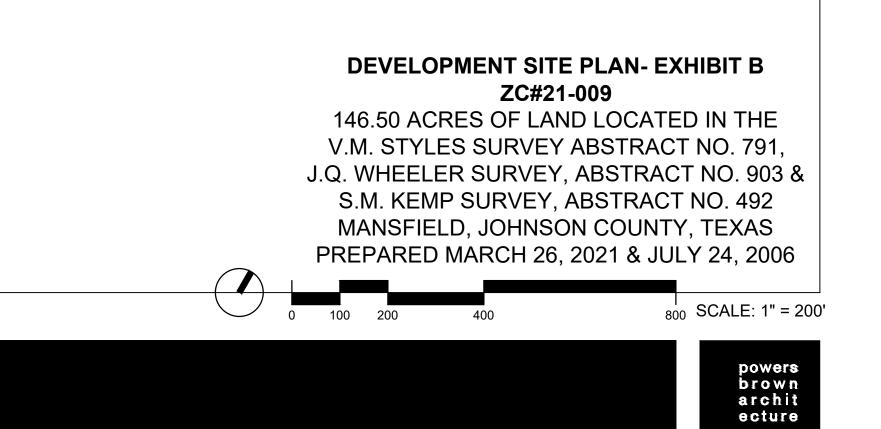

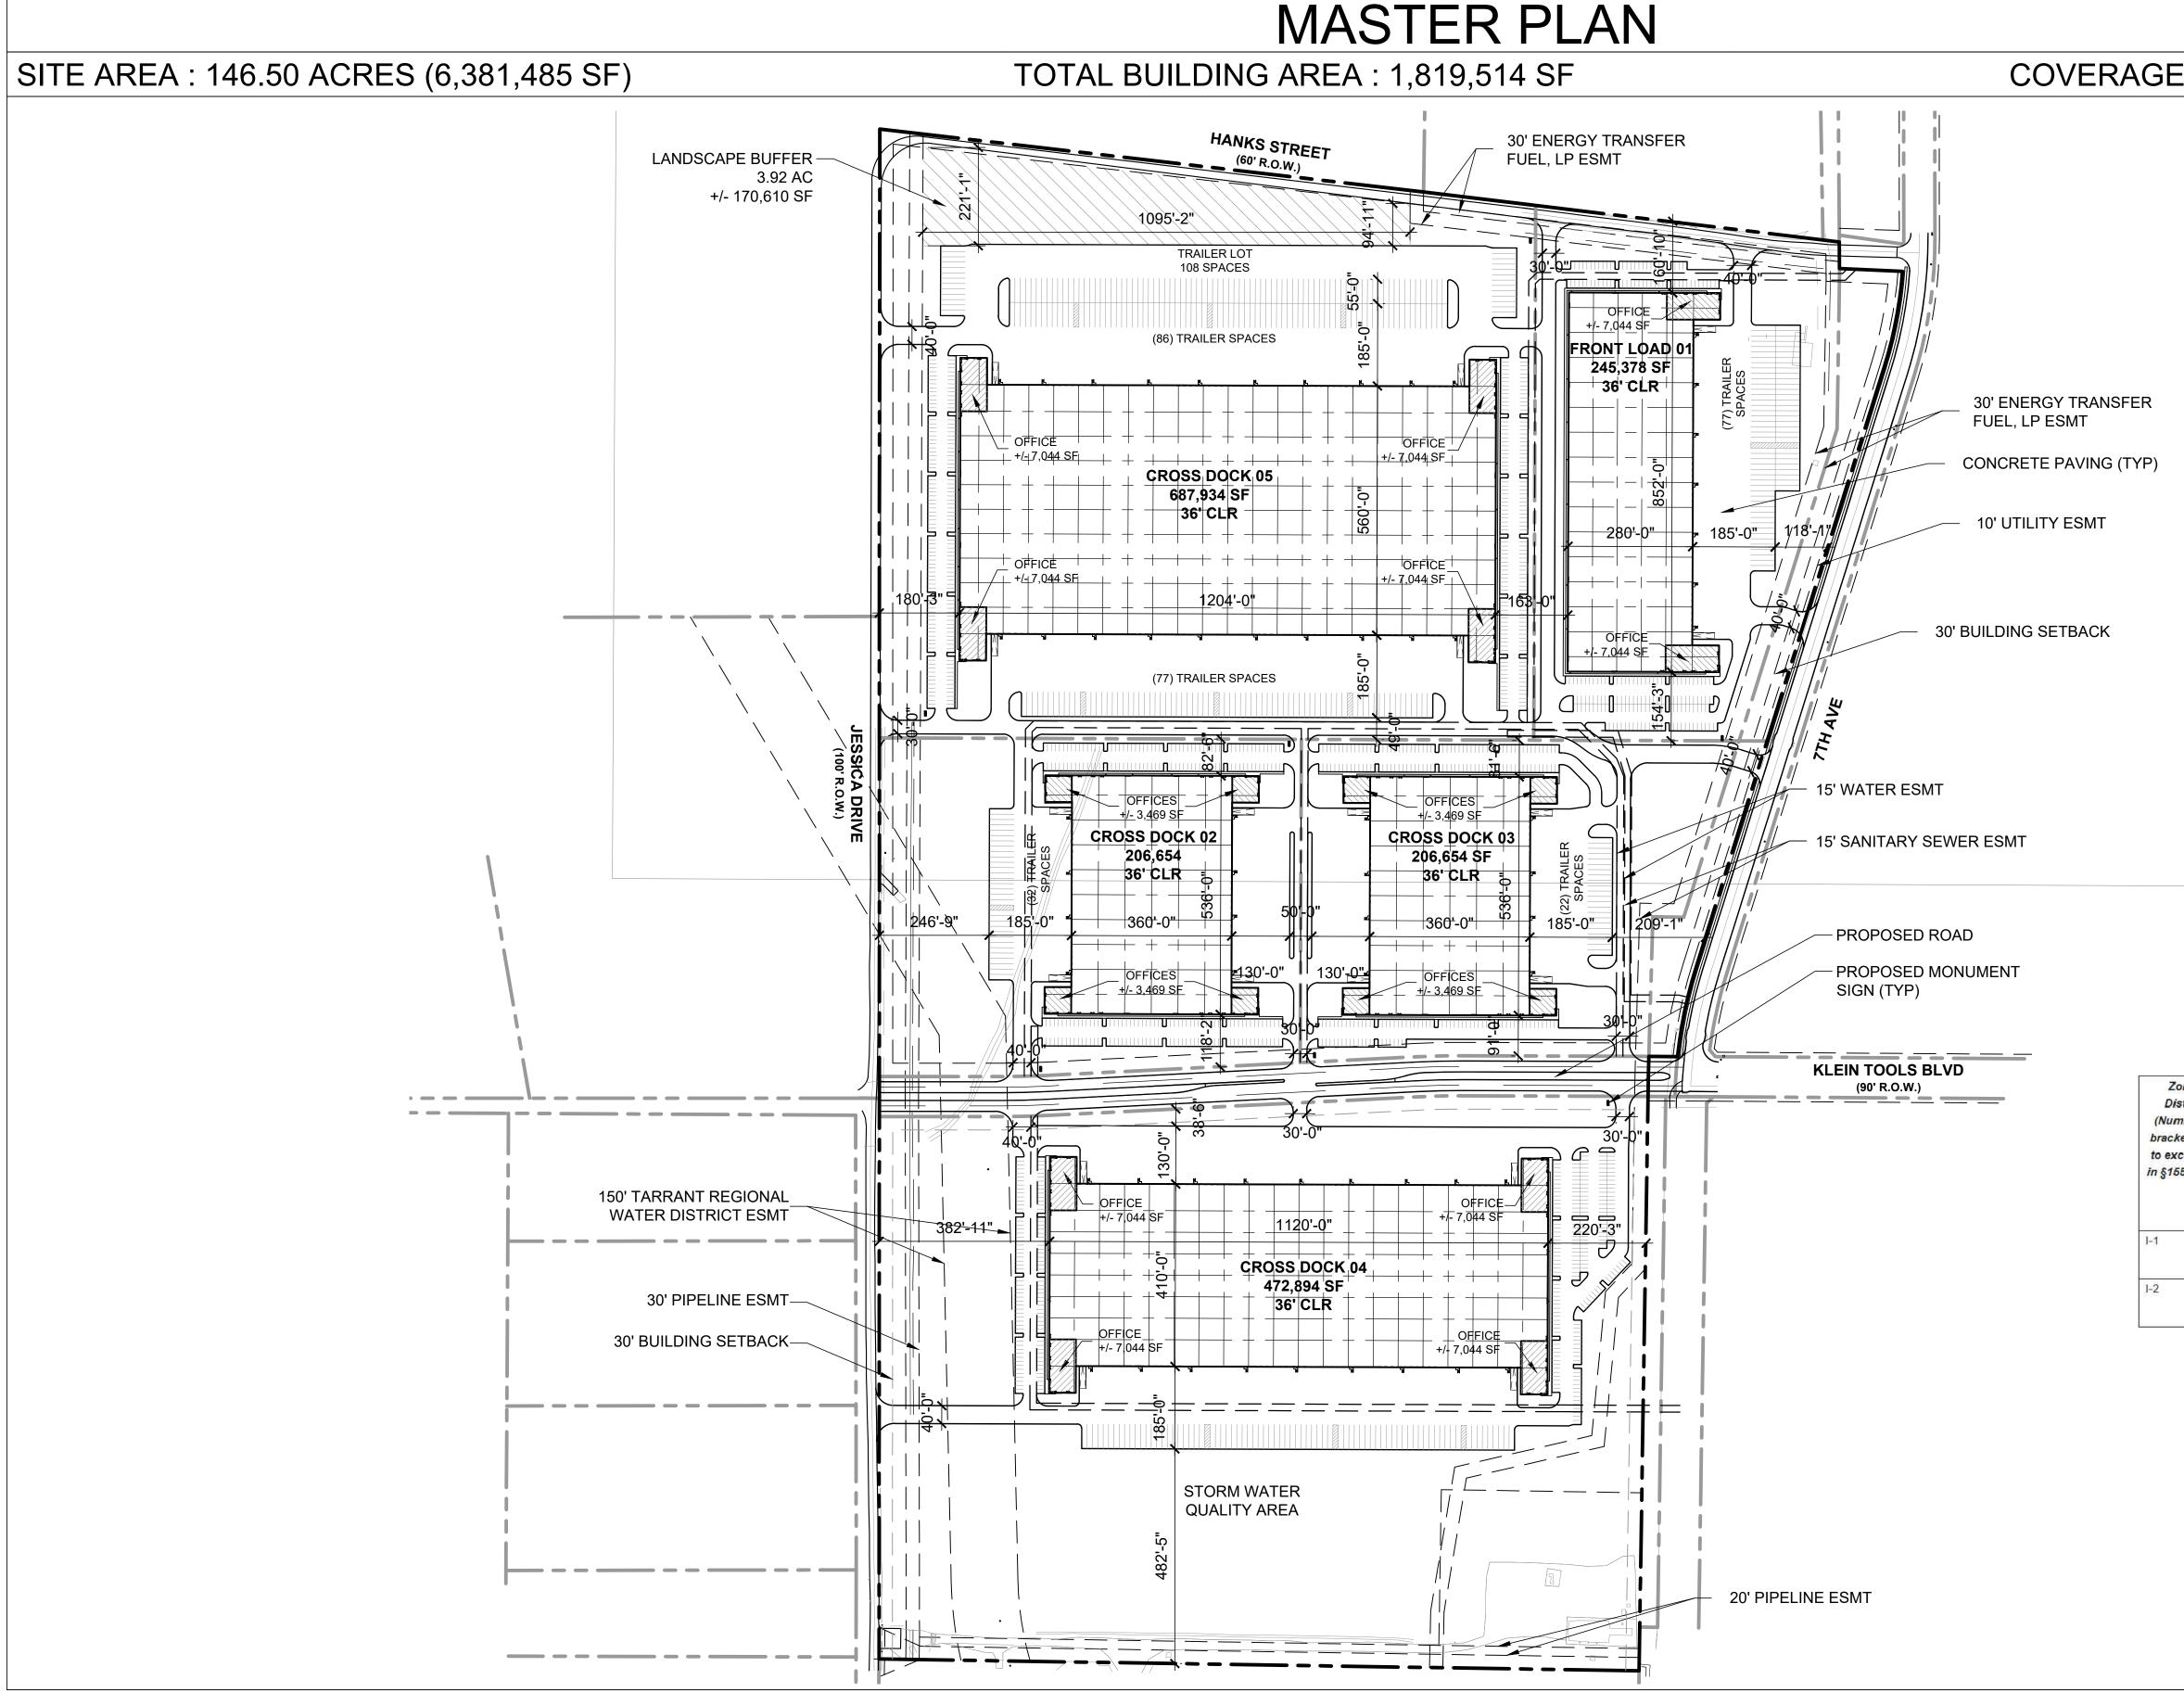

MANSFIELD PARKING REQUIREMENTS NO MORE THAN FIFTEEN (15) CONTIGUOUS SPACES SHALL BE LOCATED TOGETHER WITHOUT A TREE-ISLAND.
OFFICE: 1 SPACE PER 300 SF LIGHT INDUSTRIAL- WAREHOUSE AND ENCLOSED STORAGE: 1 SPACE PER 3,000 SF
FRONT LOAD 01: 245,378 SF OFFICE (14,088 SF): 47 SPACES WAREHOUSE (231,290 SF): 78 SPACES PARKING REQUIRED: 125 SPACES PARKING PROVIDED: 190 SPACES CROSS DOCK 02: 206,654 SF OFFICE (13,876 SF): 47 SPACES: WAREHOUSE (192,778 SF): 64 SPACES PARKING REQUIRED: 111 SPACES PARKING PROVIDED: 228 SPACES CROSS DOCK 03: 206,654 SF OFFICE (13,876 SF): 47 SPACES: WAREHOUSE (192,778 SF): 64 SPACES PARKING REQUIRED: 111 SPACES PARKING REQUIRED: 111 SPACES PARKING REQUIRED: 111 SPACES MAREHOUSE (192,778 SF): 64 SPACES PARKING REQUIRED: 111 SPACES PARKING REQUIRED: 111 SPACES PARKING PROVIDED: 192 SPACES CROSS DOCK 04: 472,894 SF OFFICE: (28,176 SF): 94 SPACES WAREHOUSE (444,718 SF): 149 SPACES PARKING REQUIRED: 243 SPACES PARKING REQUIRED: 243 SPACES
CROSS DOCK 05: 687,934 SF OFFICE (28,176 SF): 94 SPACES WAREHOUSE (659,758 SF): 220 SPACES PARKING REQUIRED: 314 SPACES PARKING PROVIDED: 332 SPACES

TOTAL PARKING REQUIRED: 904 SPACES TOTAL PARKING PROVIDED: 1,252 SPACES


loning istricts	Lot Dimension	Maximum Floor Area	Minimum Bui	ilding Setback (fee	t) (7) (10) (12)	Masonry Construction	Maximum Height (Feet)
istricts imbers in kets refer xceptions 55.055(C))	(i.e. area, width, depth)	ith, depth) Ratio When st	When abutting street	When abutting other property lines (1) (3)		Requirement	(2) (6)
			right-of-way	In a non-residential district	In a residential district		
	None	2.0	30	None	40	Refer to §155.056	None
	None	1.0	30	None	40	Refer to §155.056	None

NO ONSITE LIQUID WASTE NO TRASH DUMPSERS

DEVELOPMENT SITE PLAN- EXHIBIT B ZC#21-009

FIRE LANE



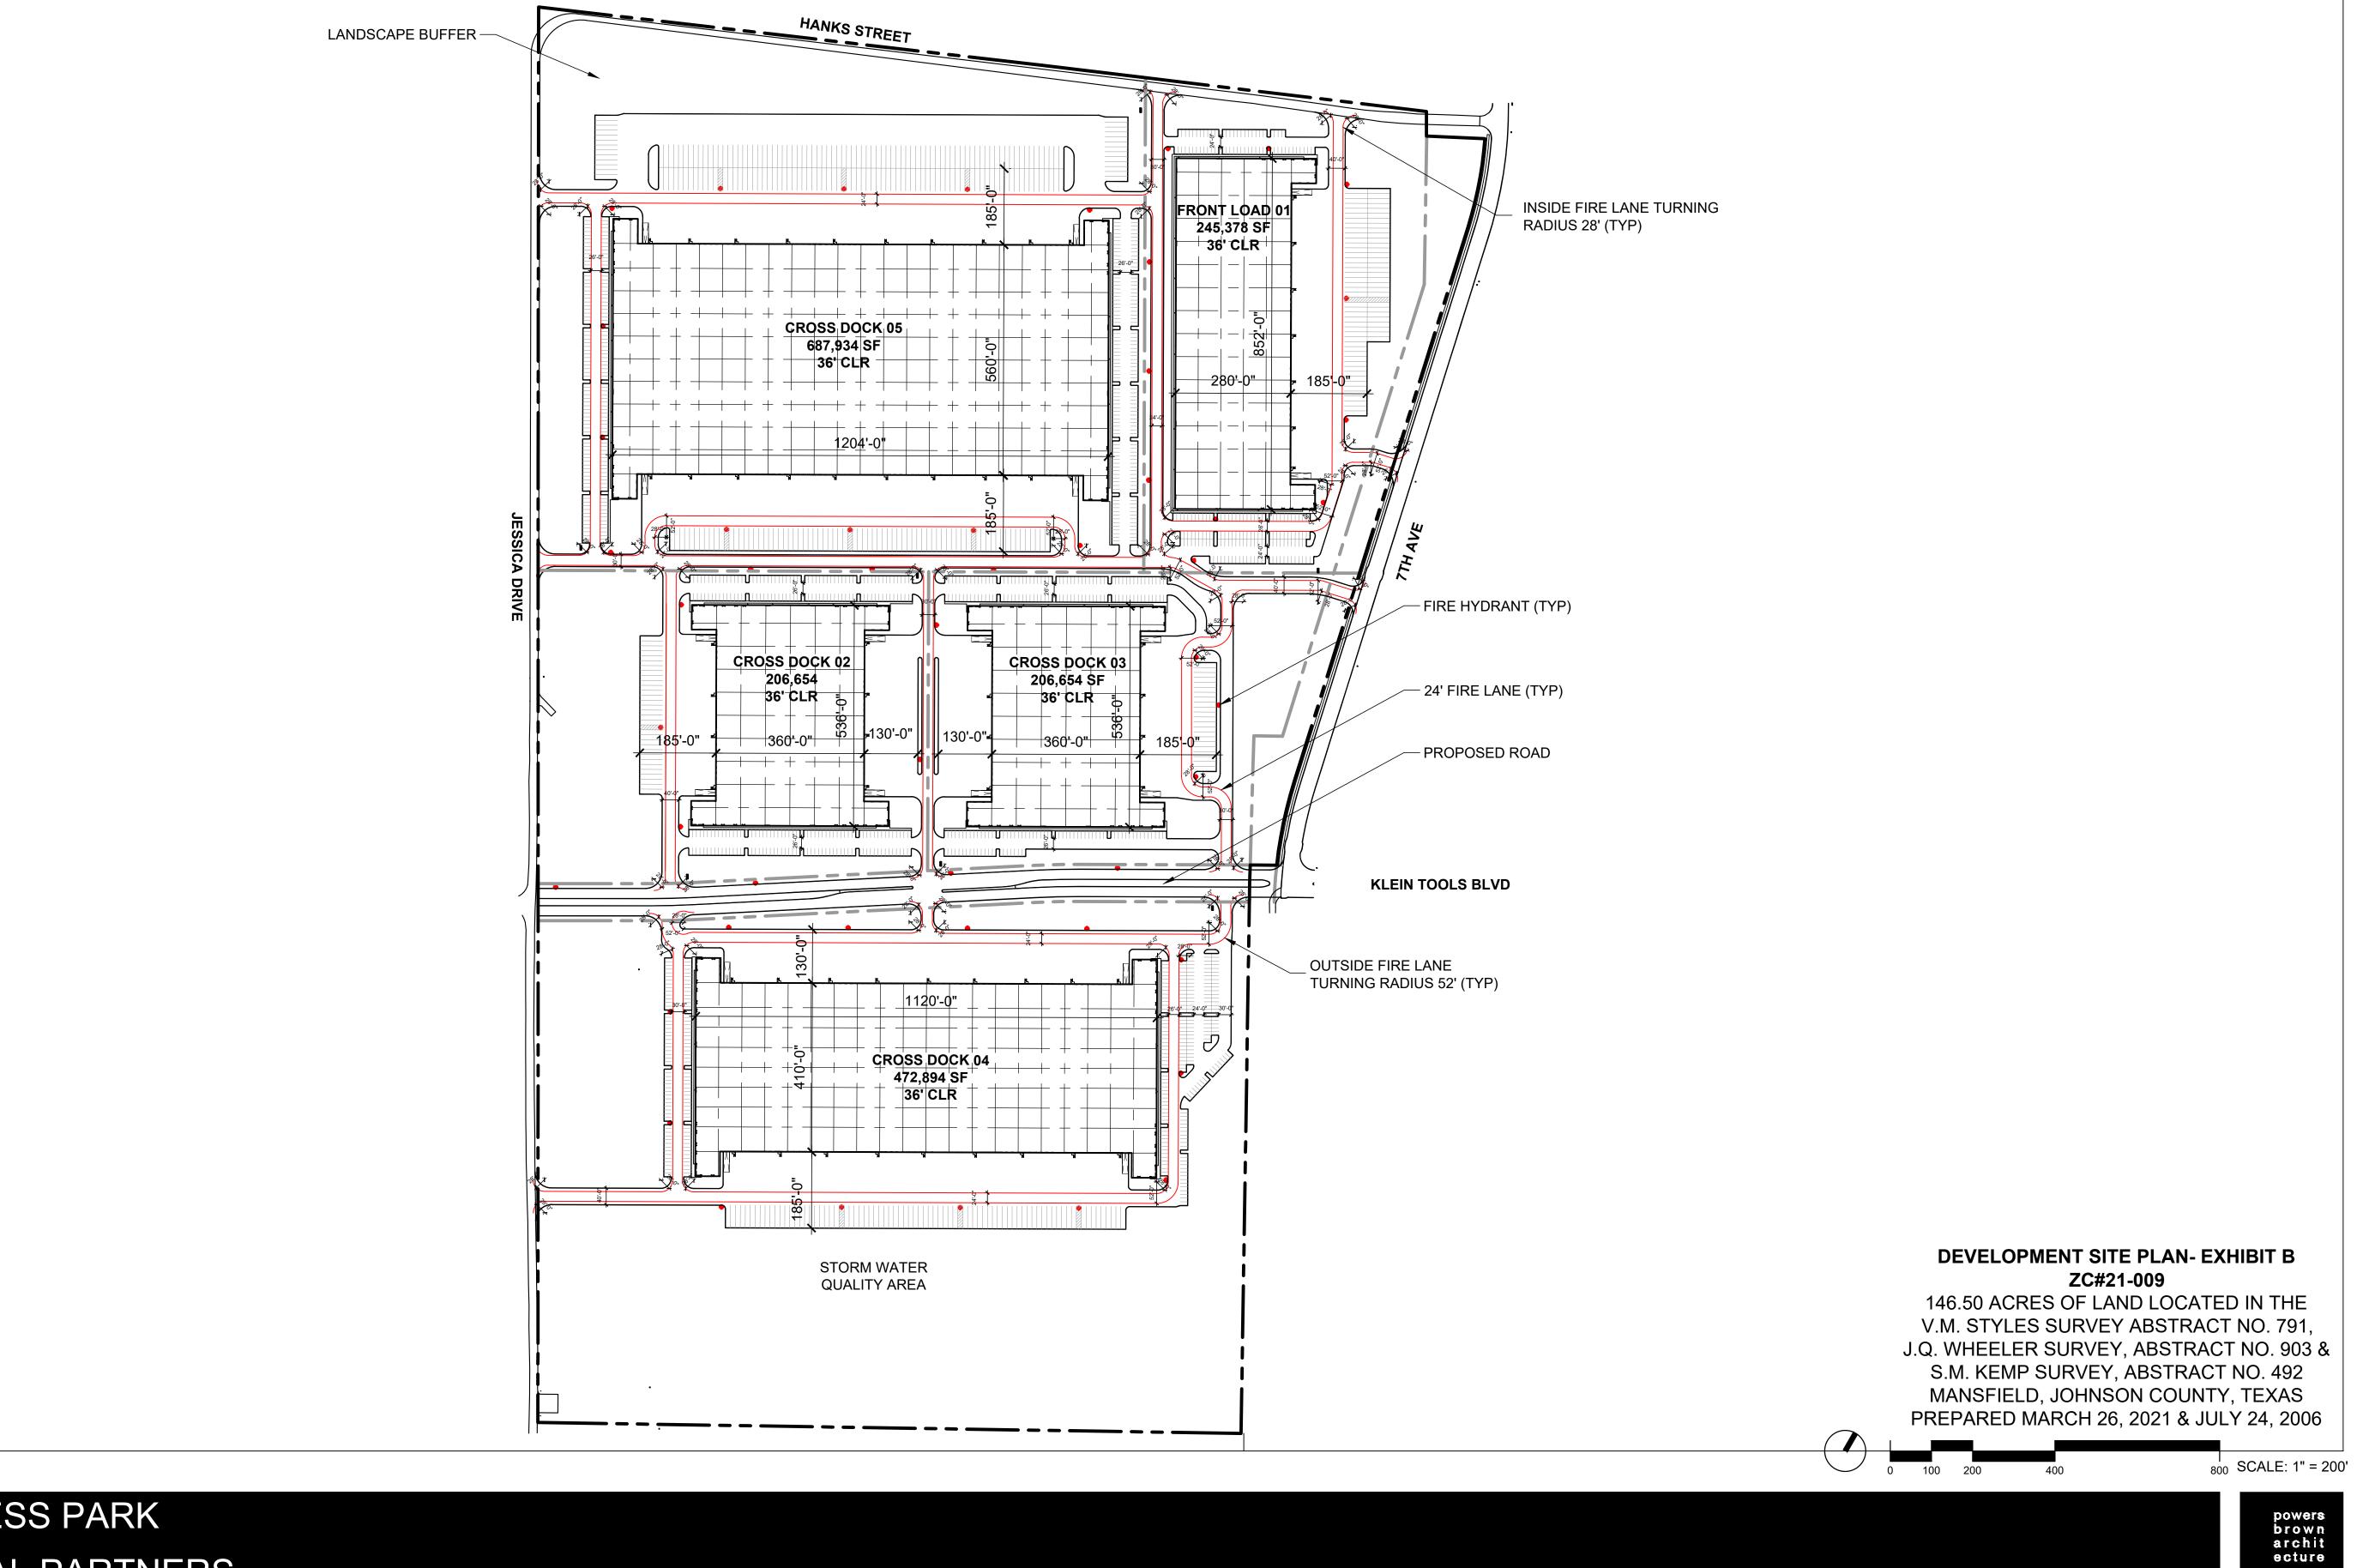


MANSFIELD BUSINESS PARK a project for STONELAKE CAPITAL PARTNERS


MASTER PLAN- FIRE ACCESS

MASTER PLAN- PEDESTRIAN ACCESS


SIDEWALKS

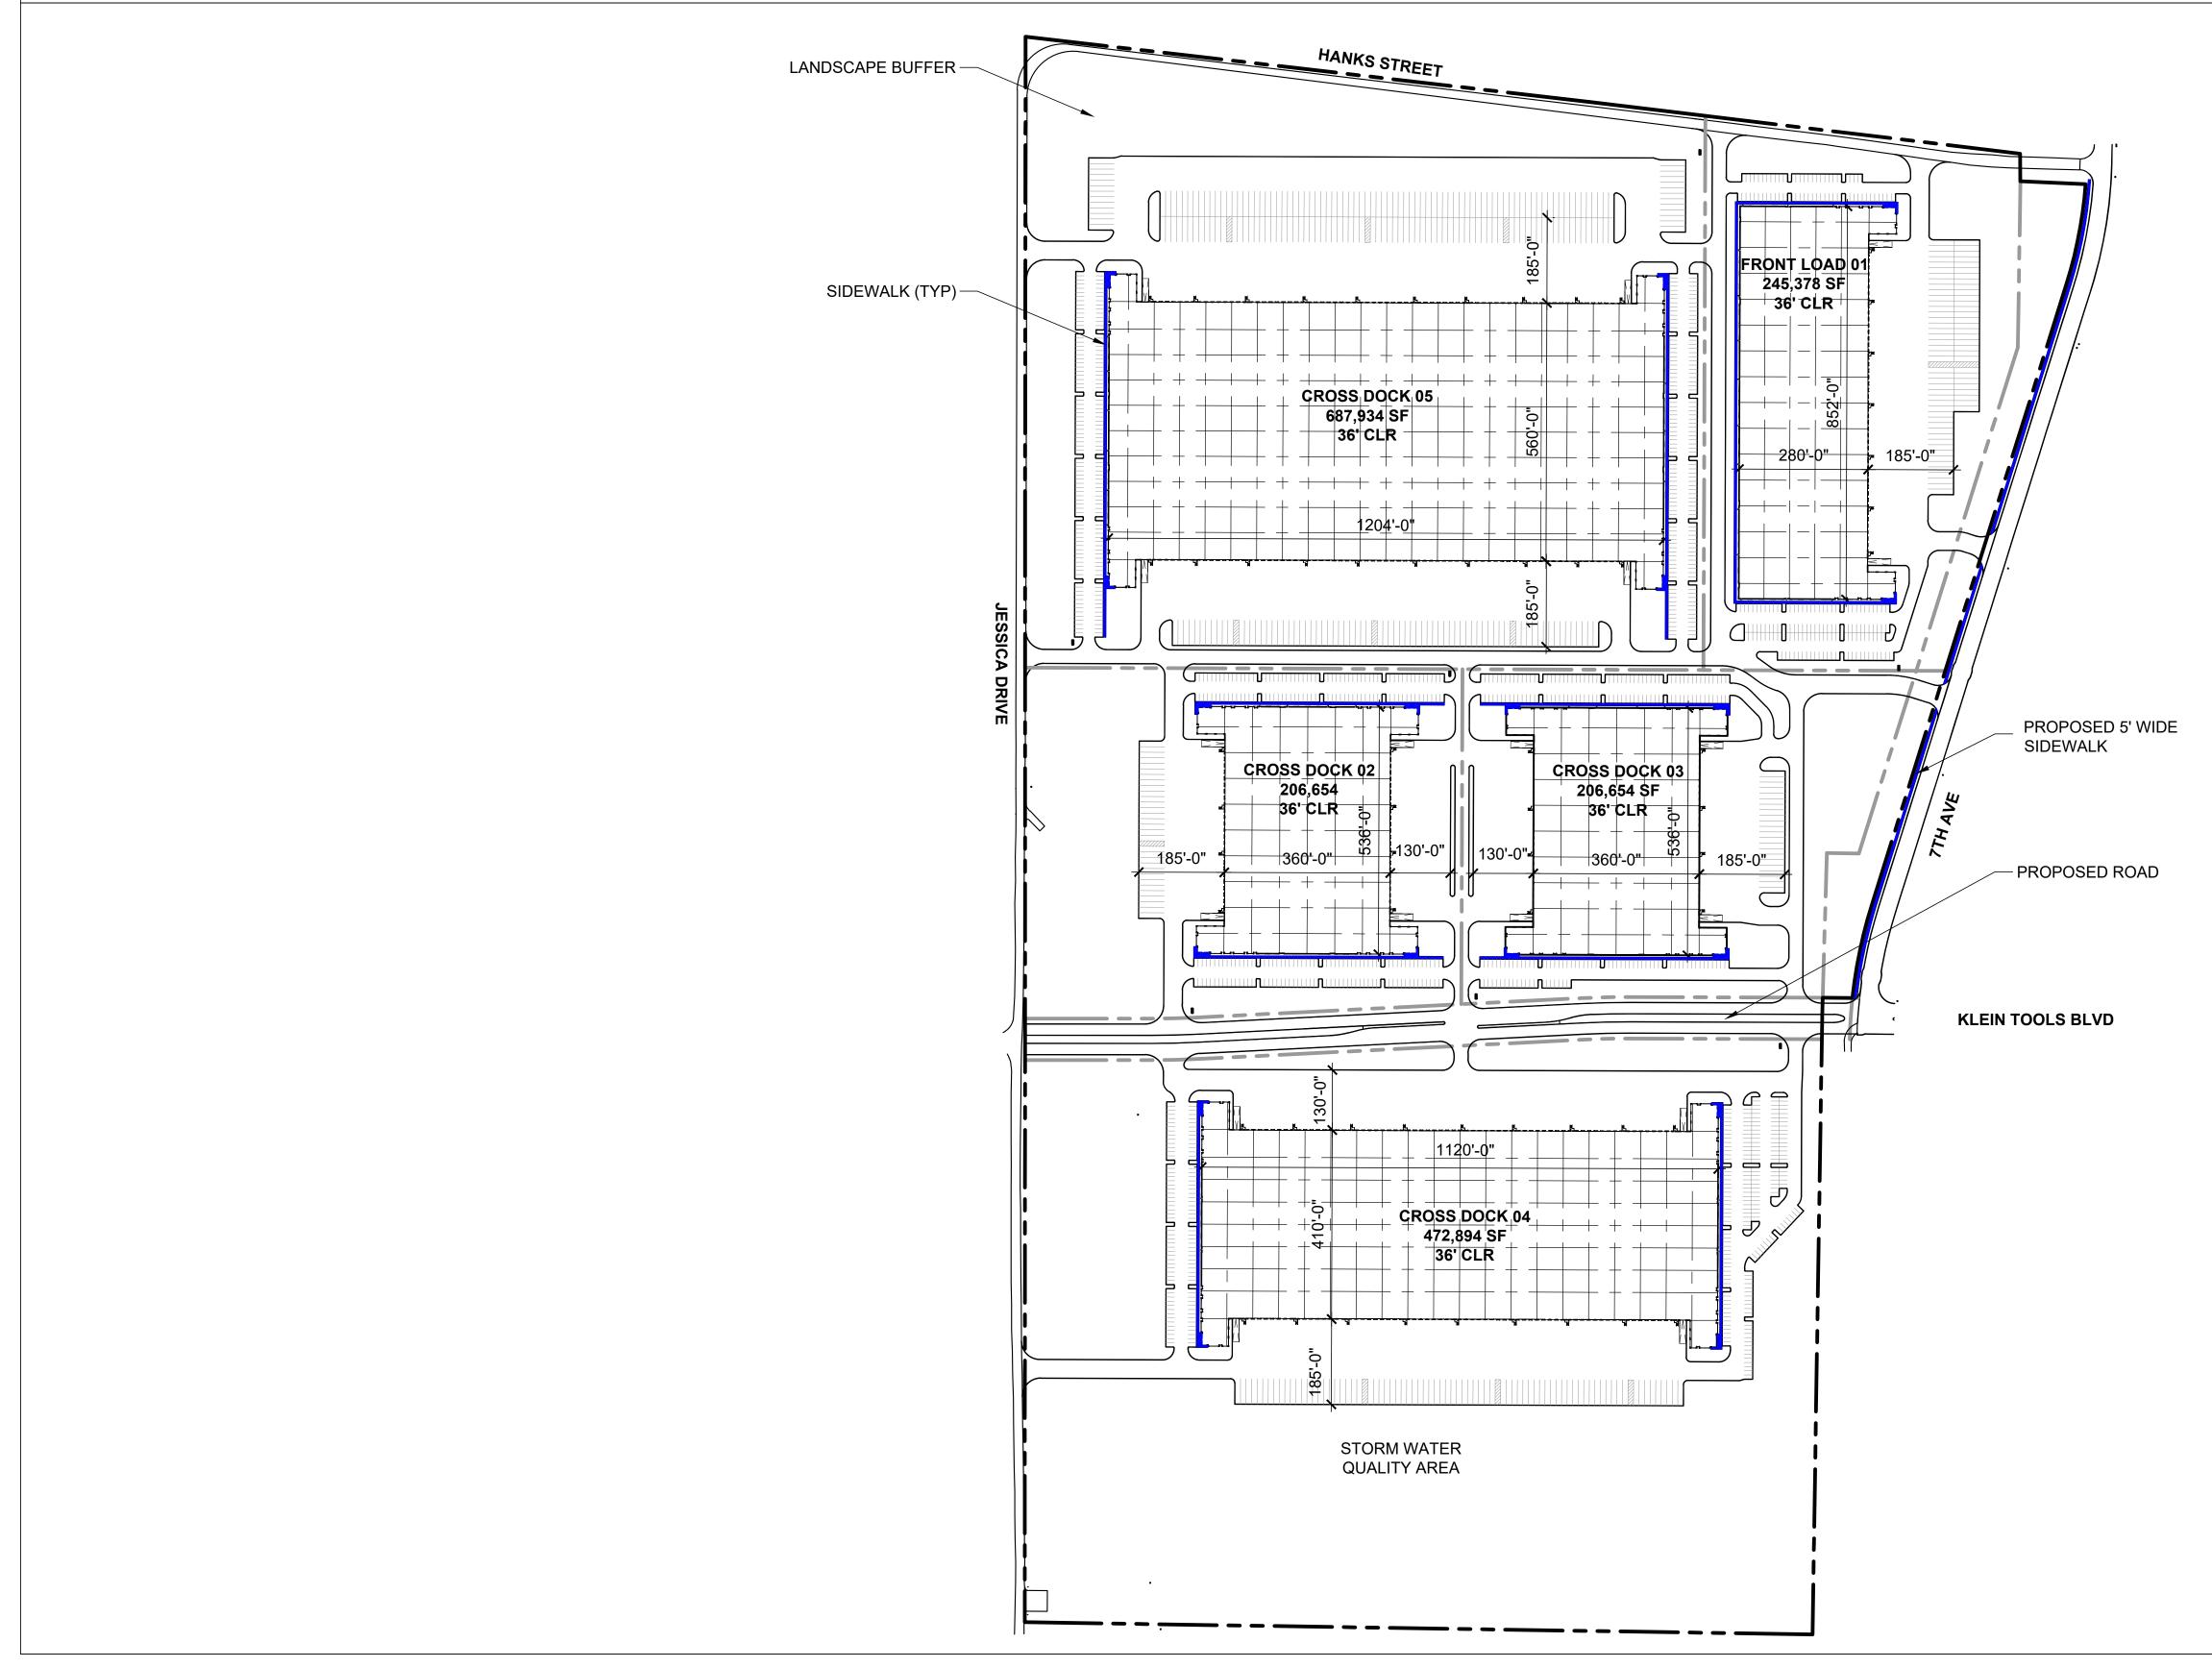

MANSFIELD BUSINESS PARK a project for STONELAKE CAPITAL PARTNERS

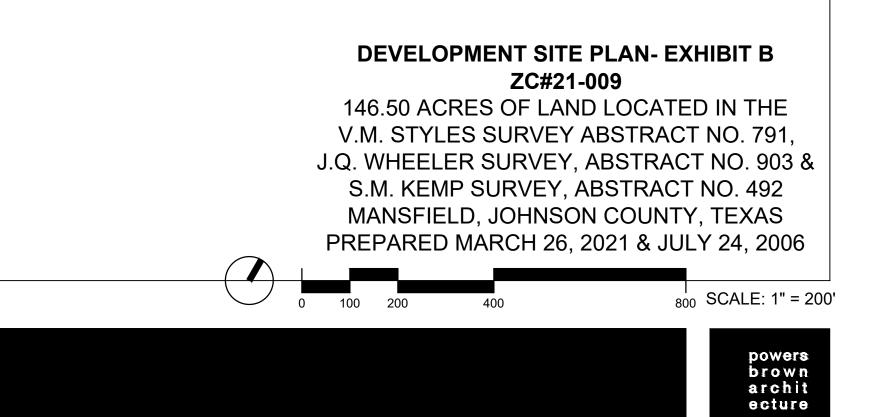

BUILDING AREA- 245,378 SF

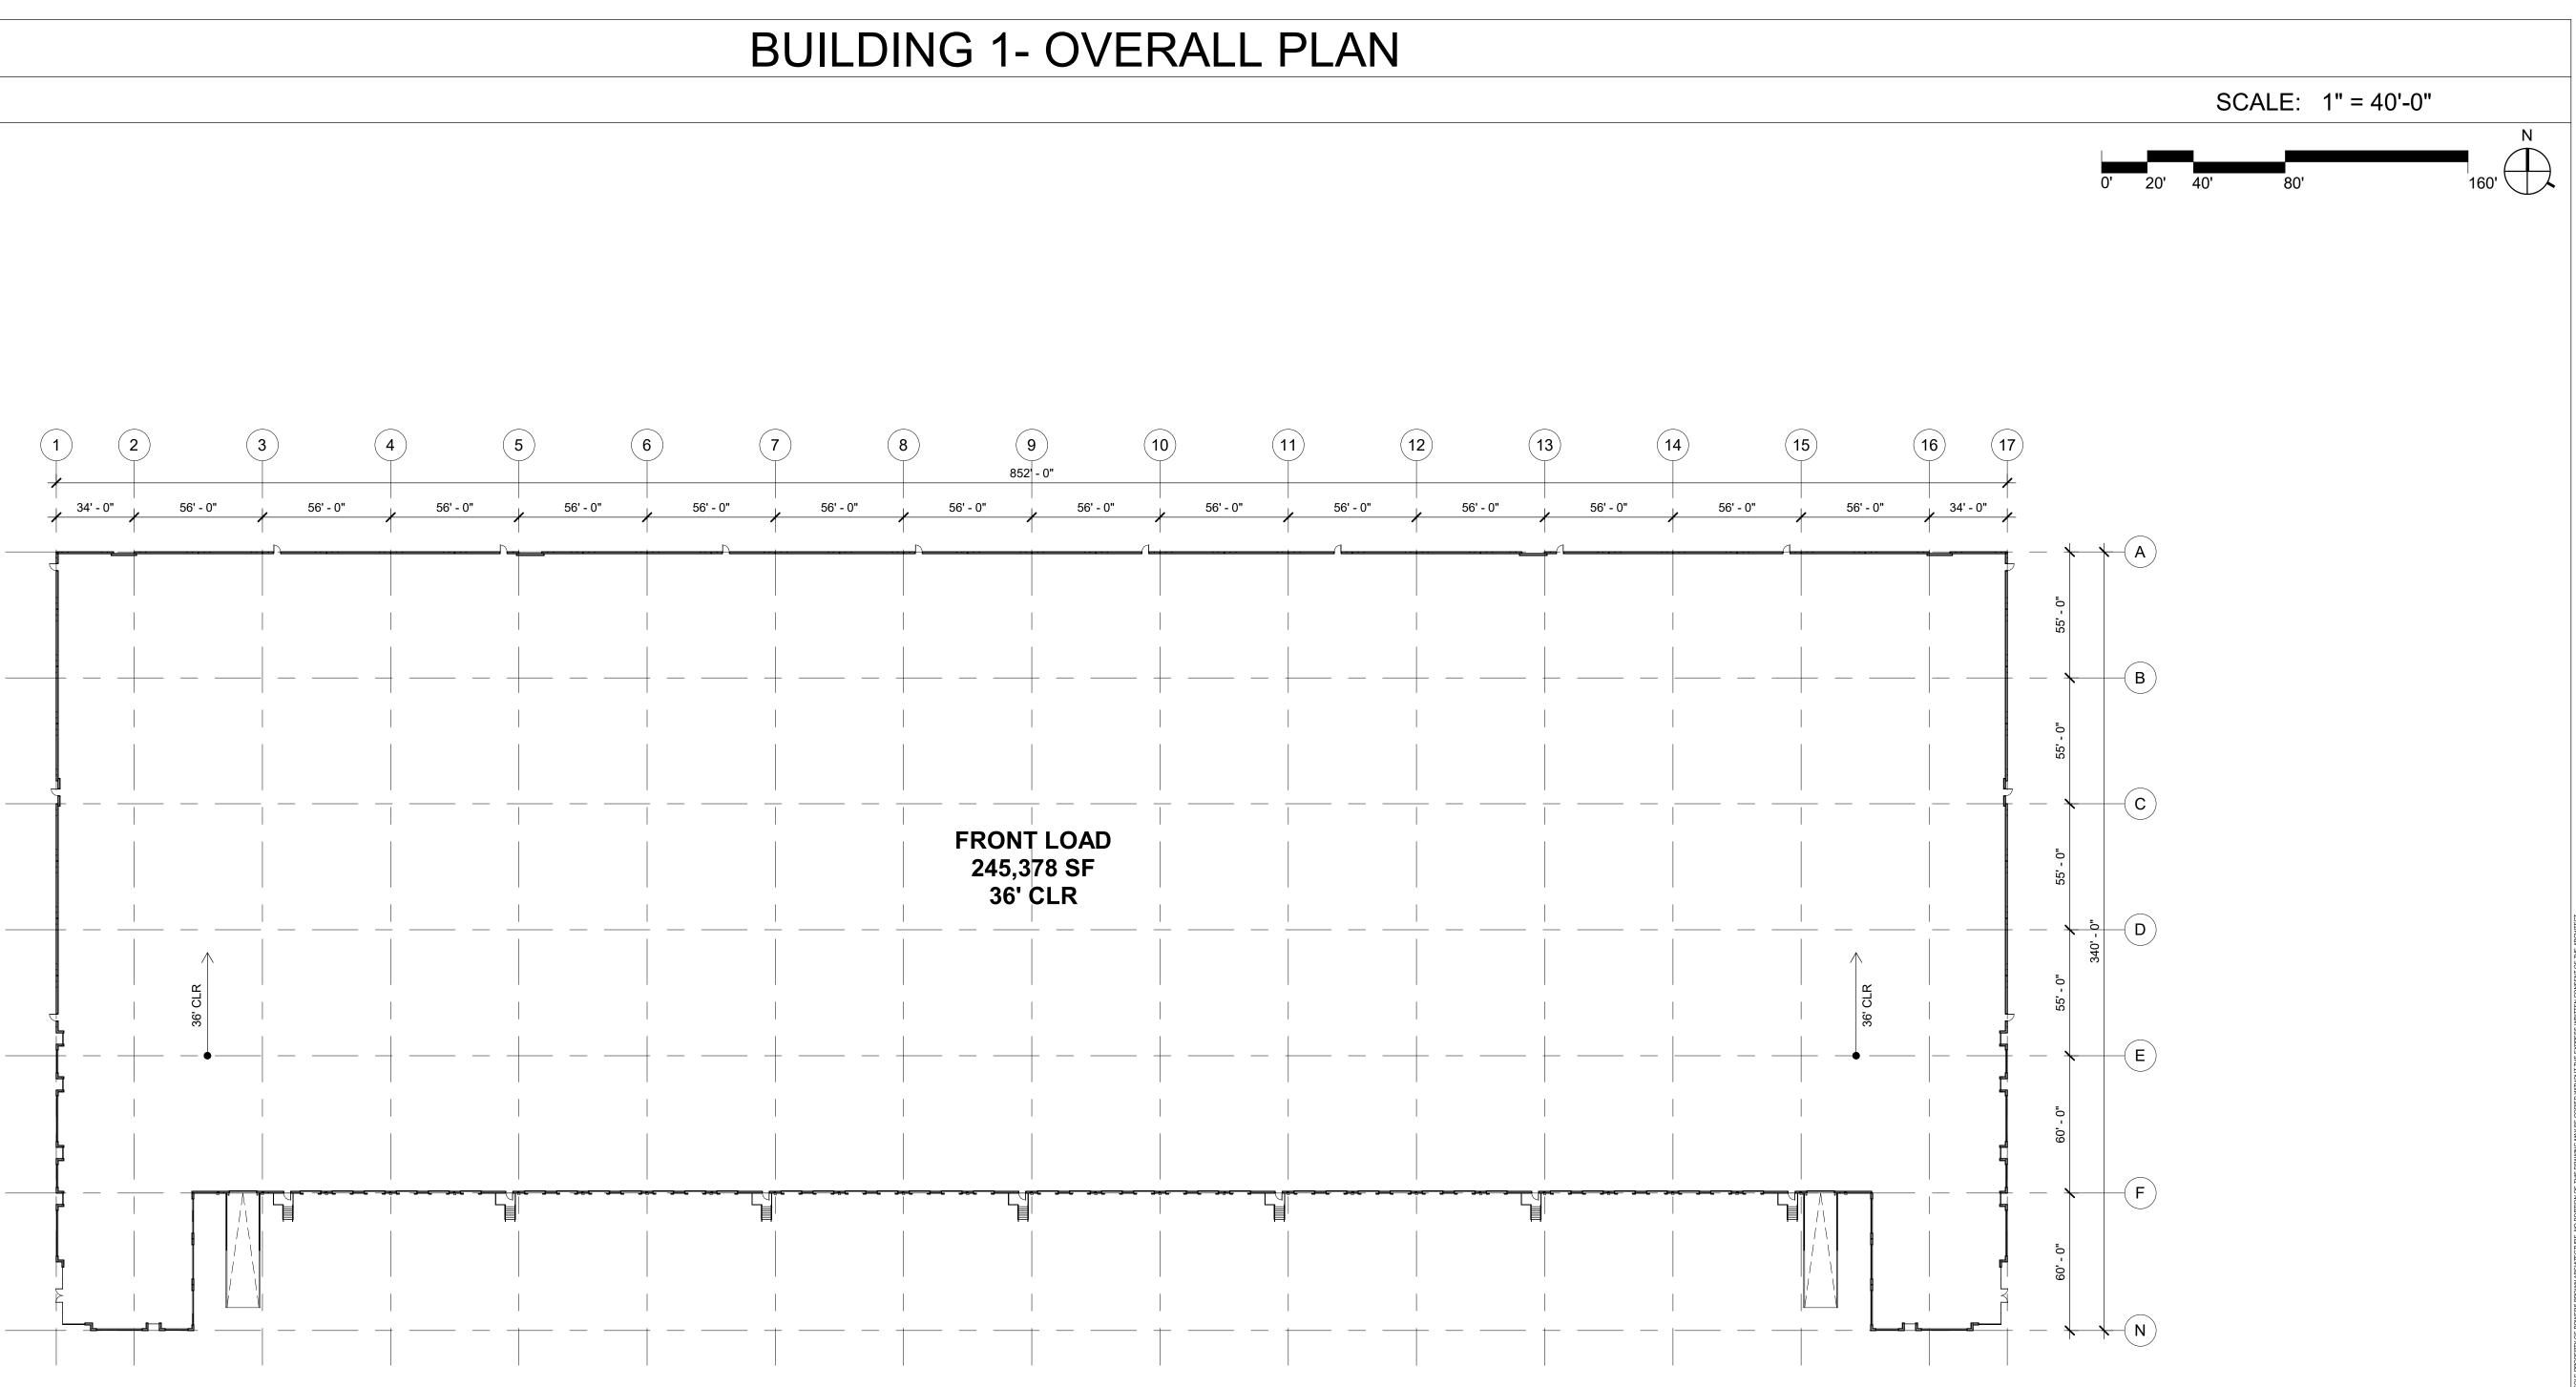

MANSFIELD BUSINESS PARK A PROJECT FOR STONELAKE CAPITAL PARTNERS


HOUSTON

DEVELOPMENT SITE PLAN- EXHIBIT B ZC#21-009






BUILDING AREA- 206,654 SF

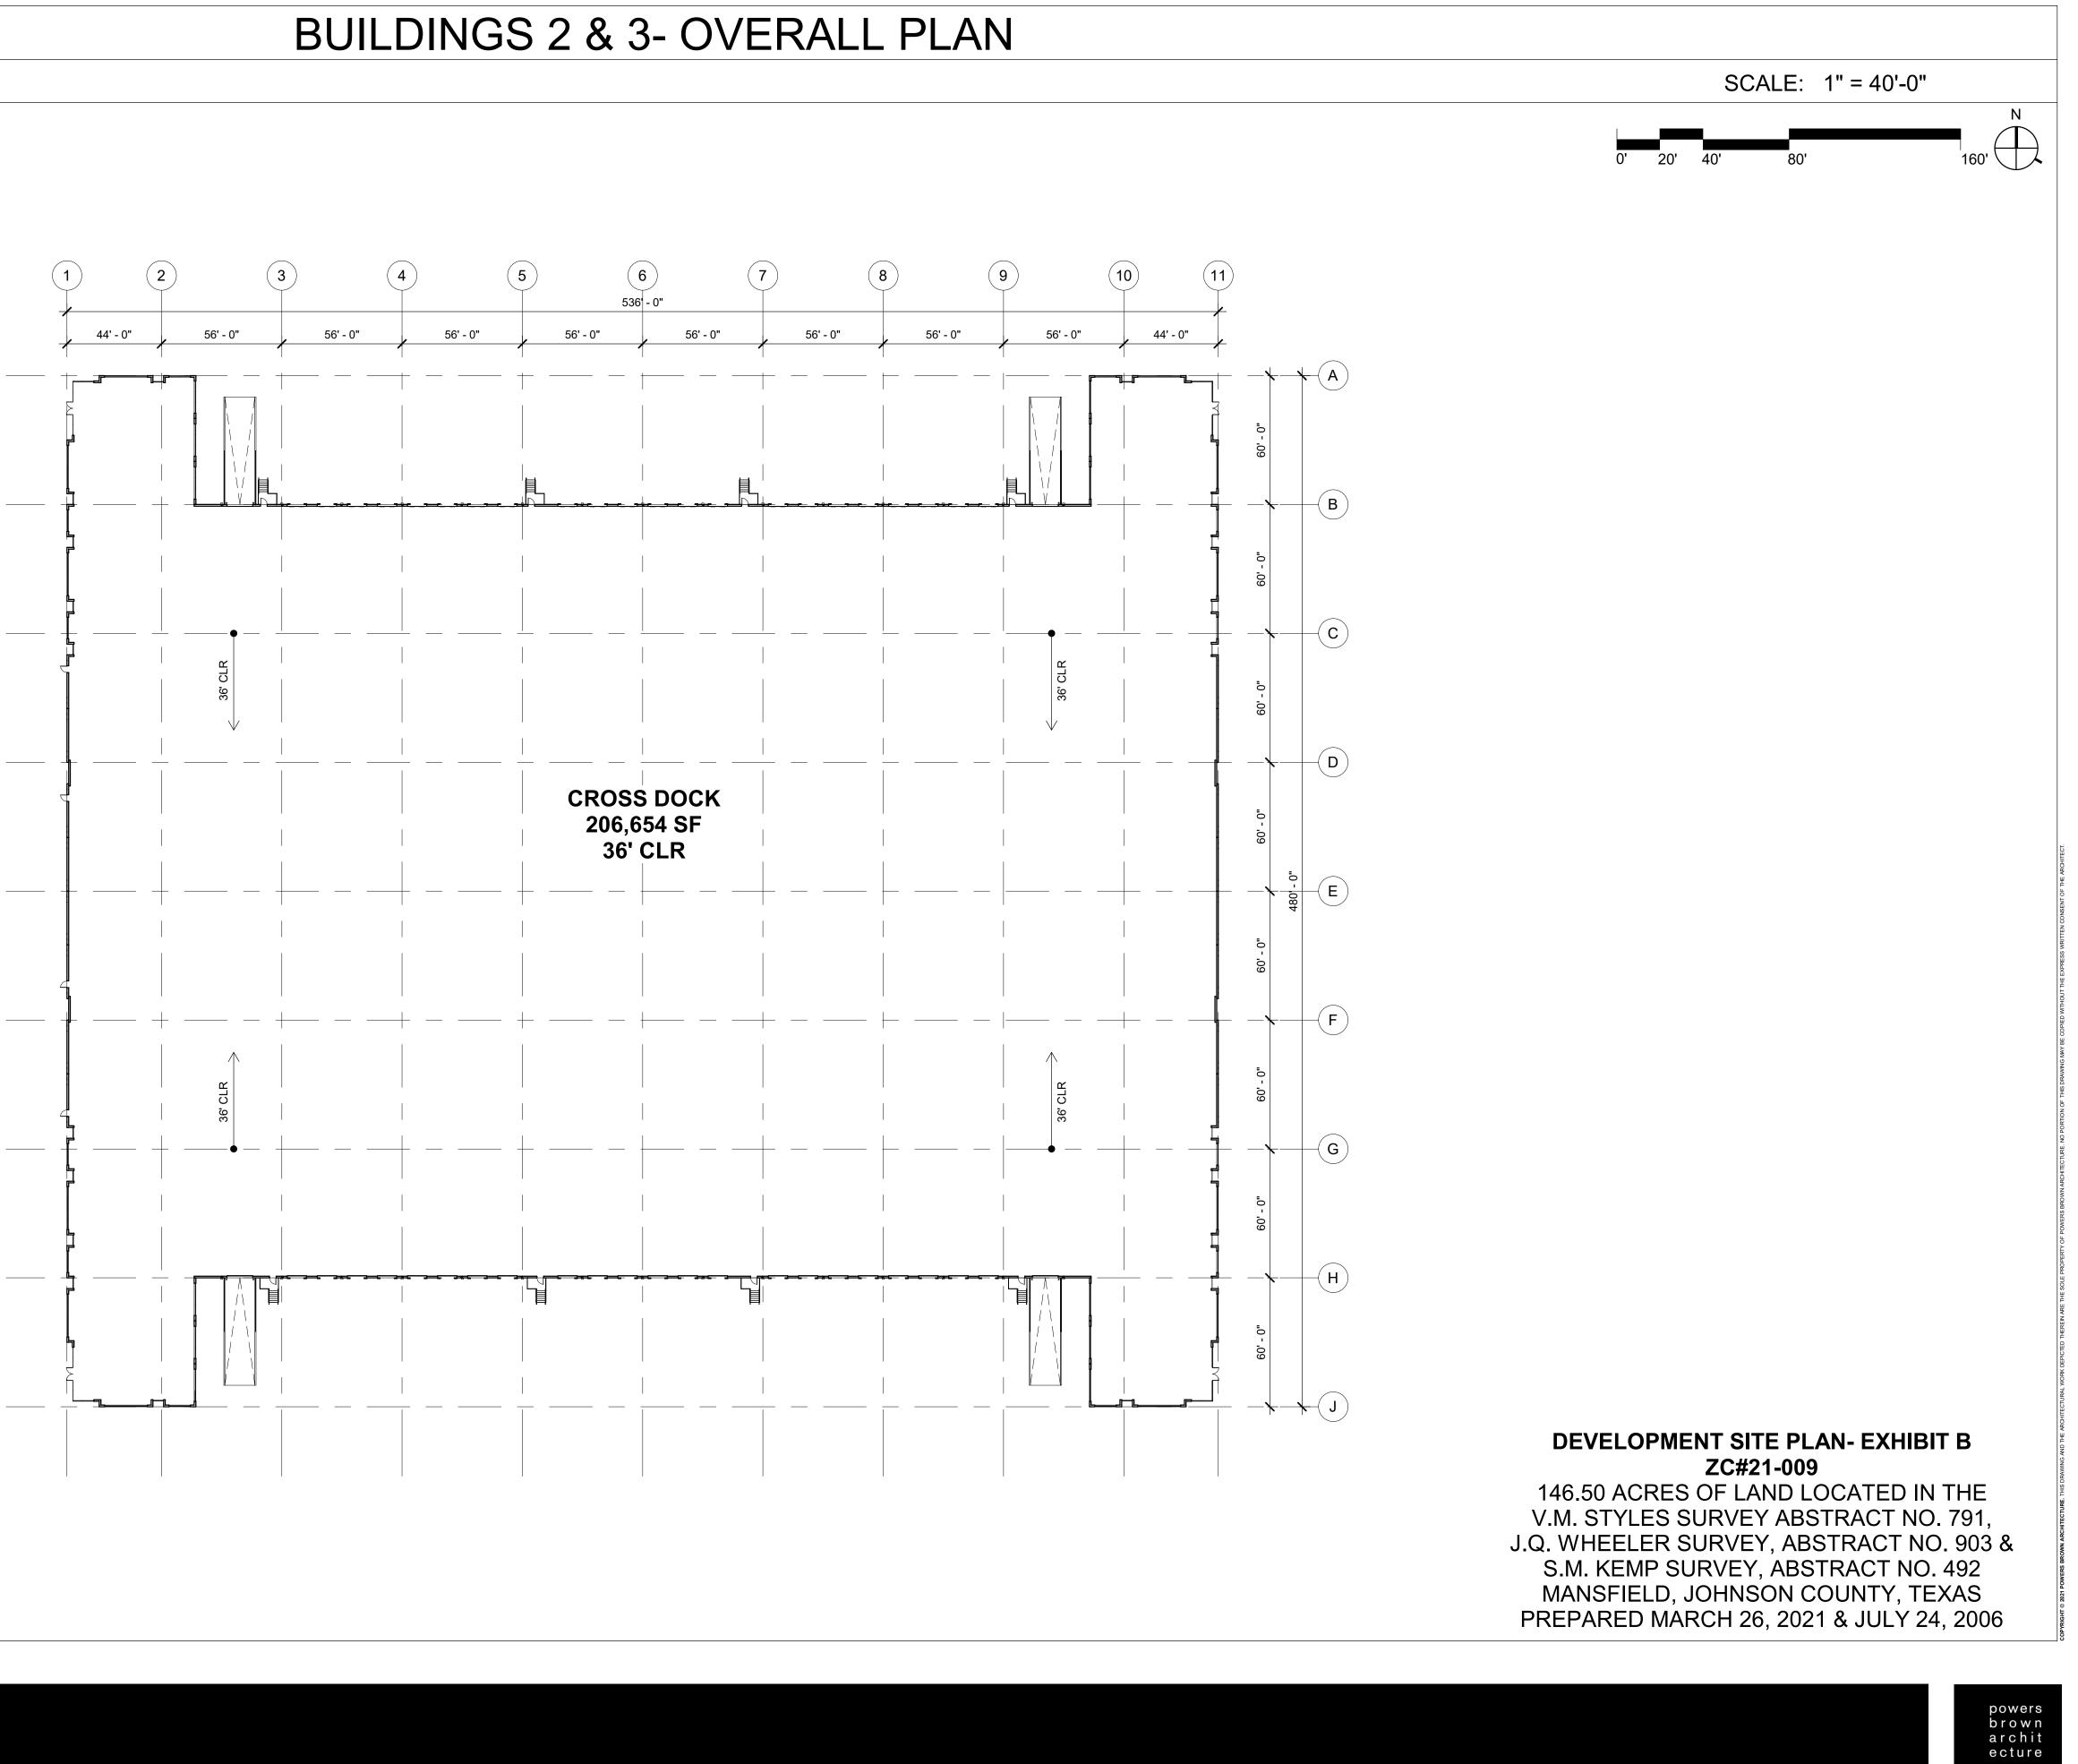

MANSFIELD BUSINESS PARK A PROJECT FOR STONELAKE CAPITAL PARTNERS HOUSTON


BUILDING AREA- 472,894 SF

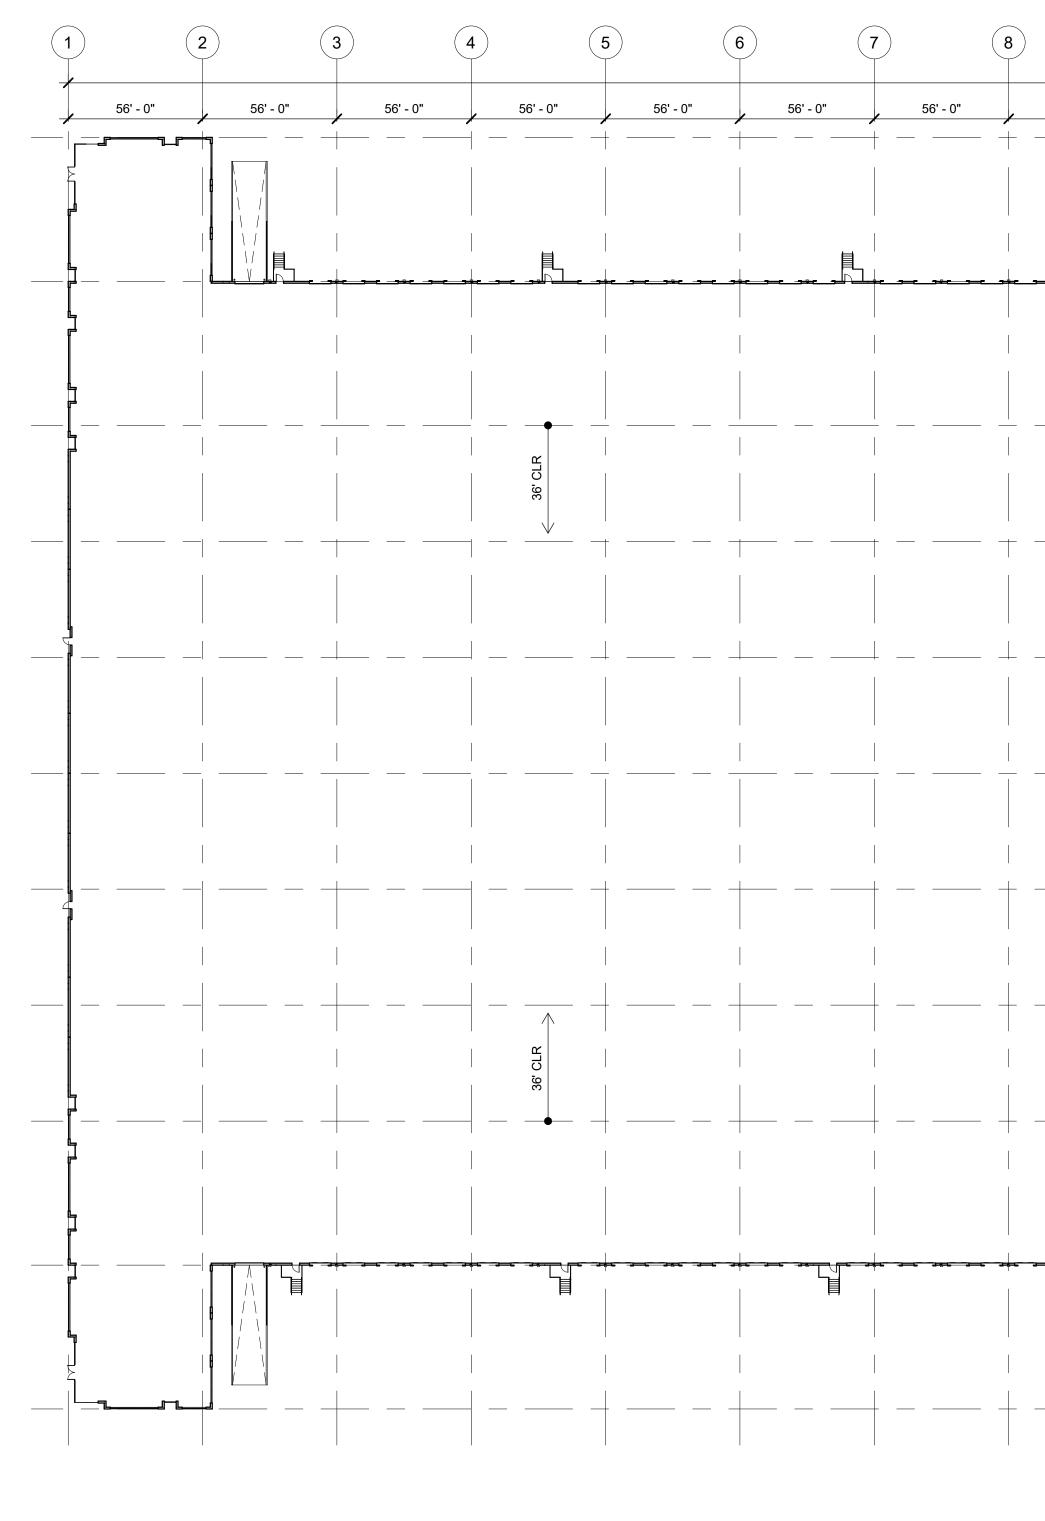

MANSFIELD BUSINESS PARK A PROJECT FOR STONELAKE CAPITAL PARTNERS HOUSTON

BUILDING 4- OVERALL PLAN


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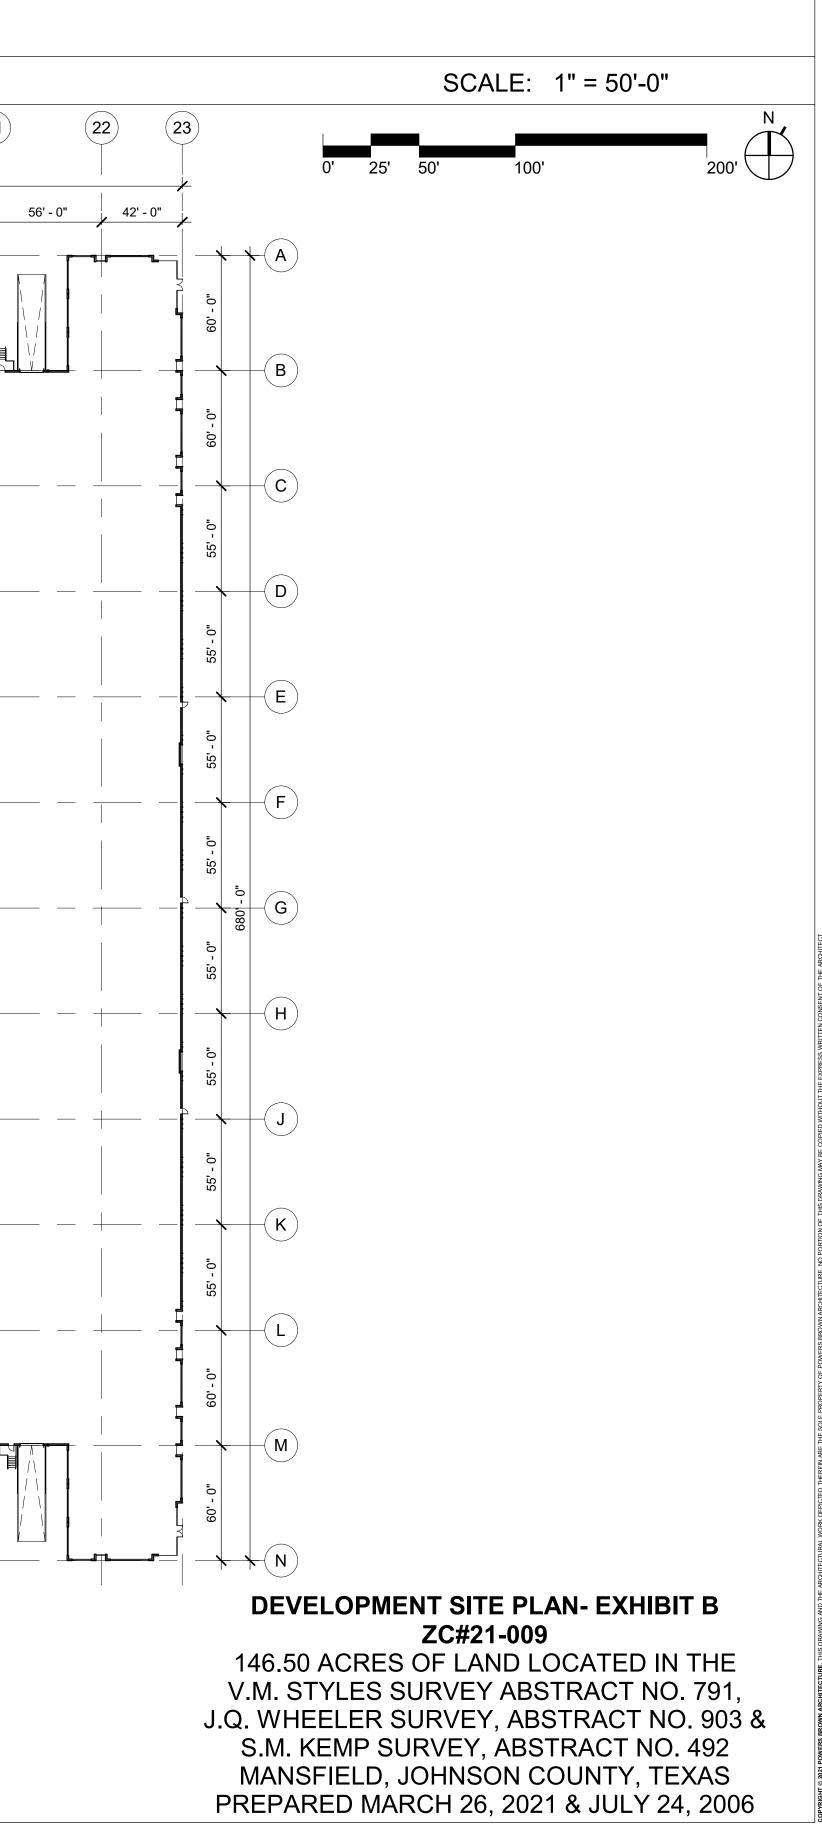
BUILDING AREA- 687,934 SF

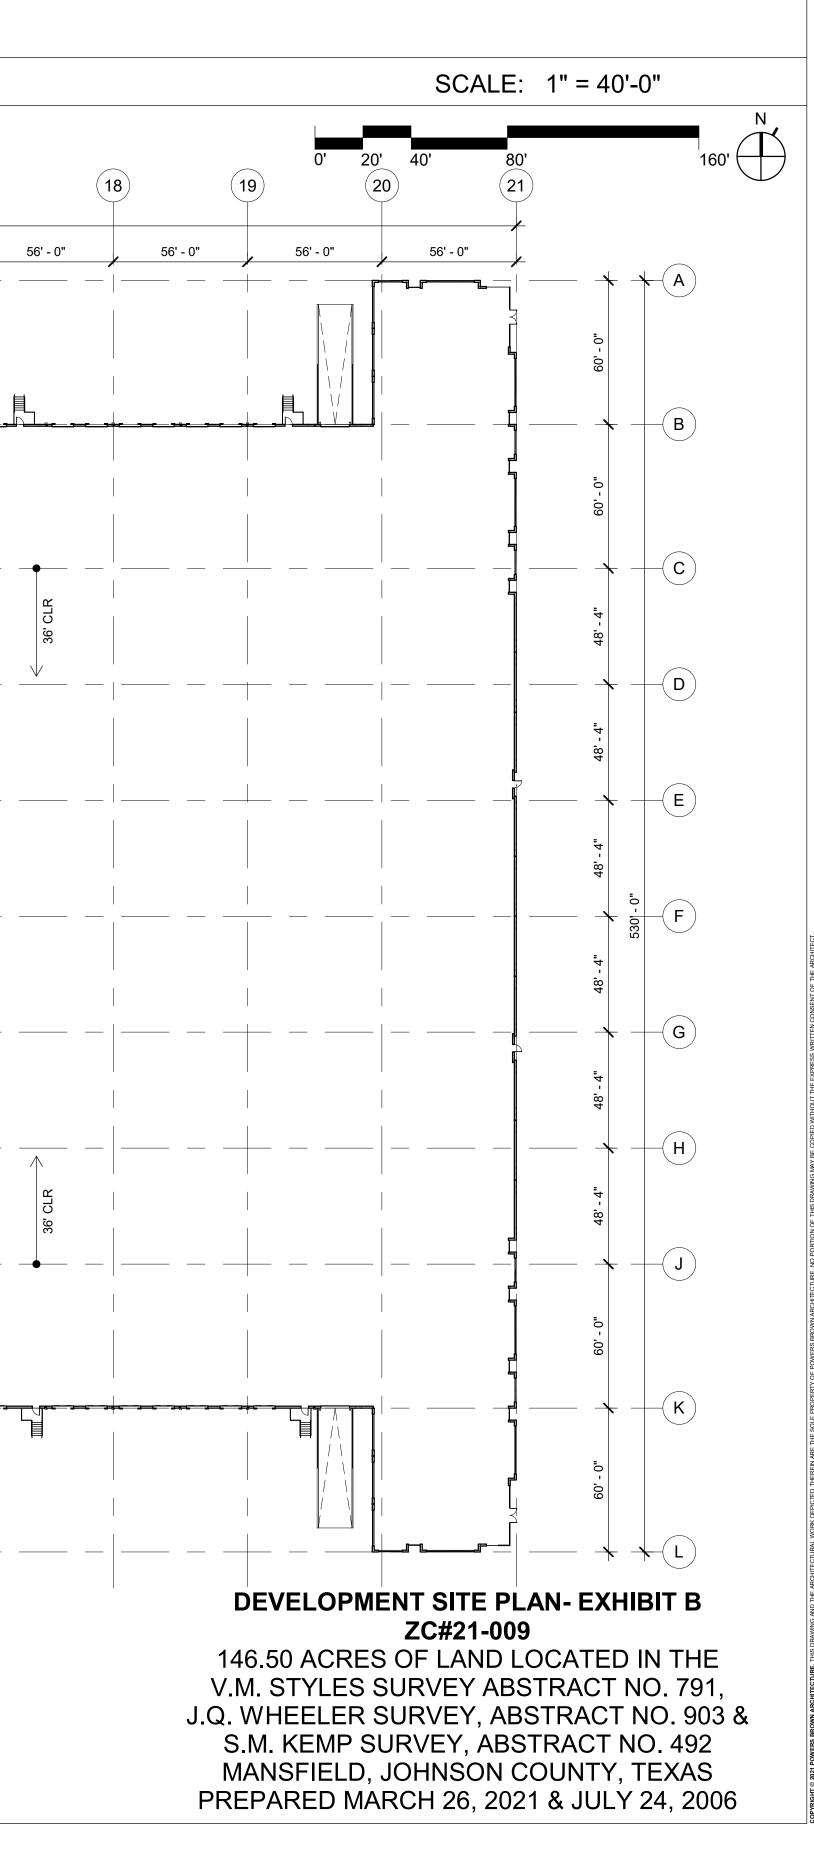

MANSFIELD BUSINESS PARK STONELAKE CAPITAL PARTNERS HOUSTON


BUILDING 5- OVERALL PLAN

10	(11)	(12)	(13)		16 17	18 (19)	20 21
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						36' CLR	
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		CROSS DC 687,934 \$ 36' CLF	SF				
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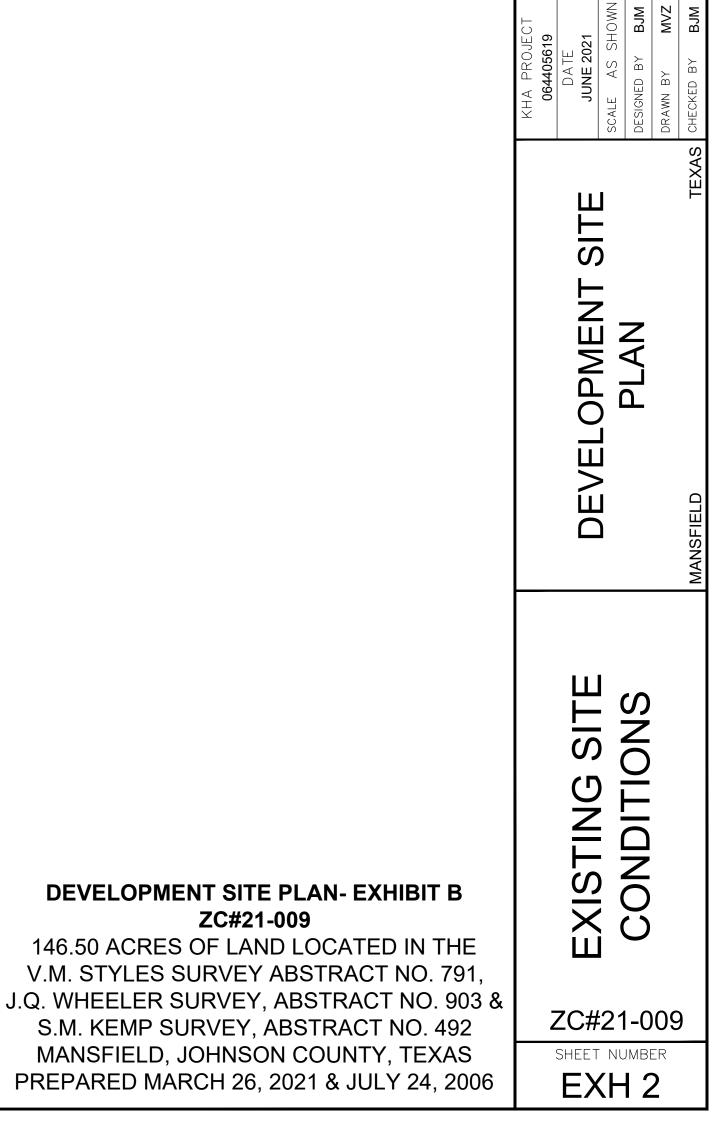


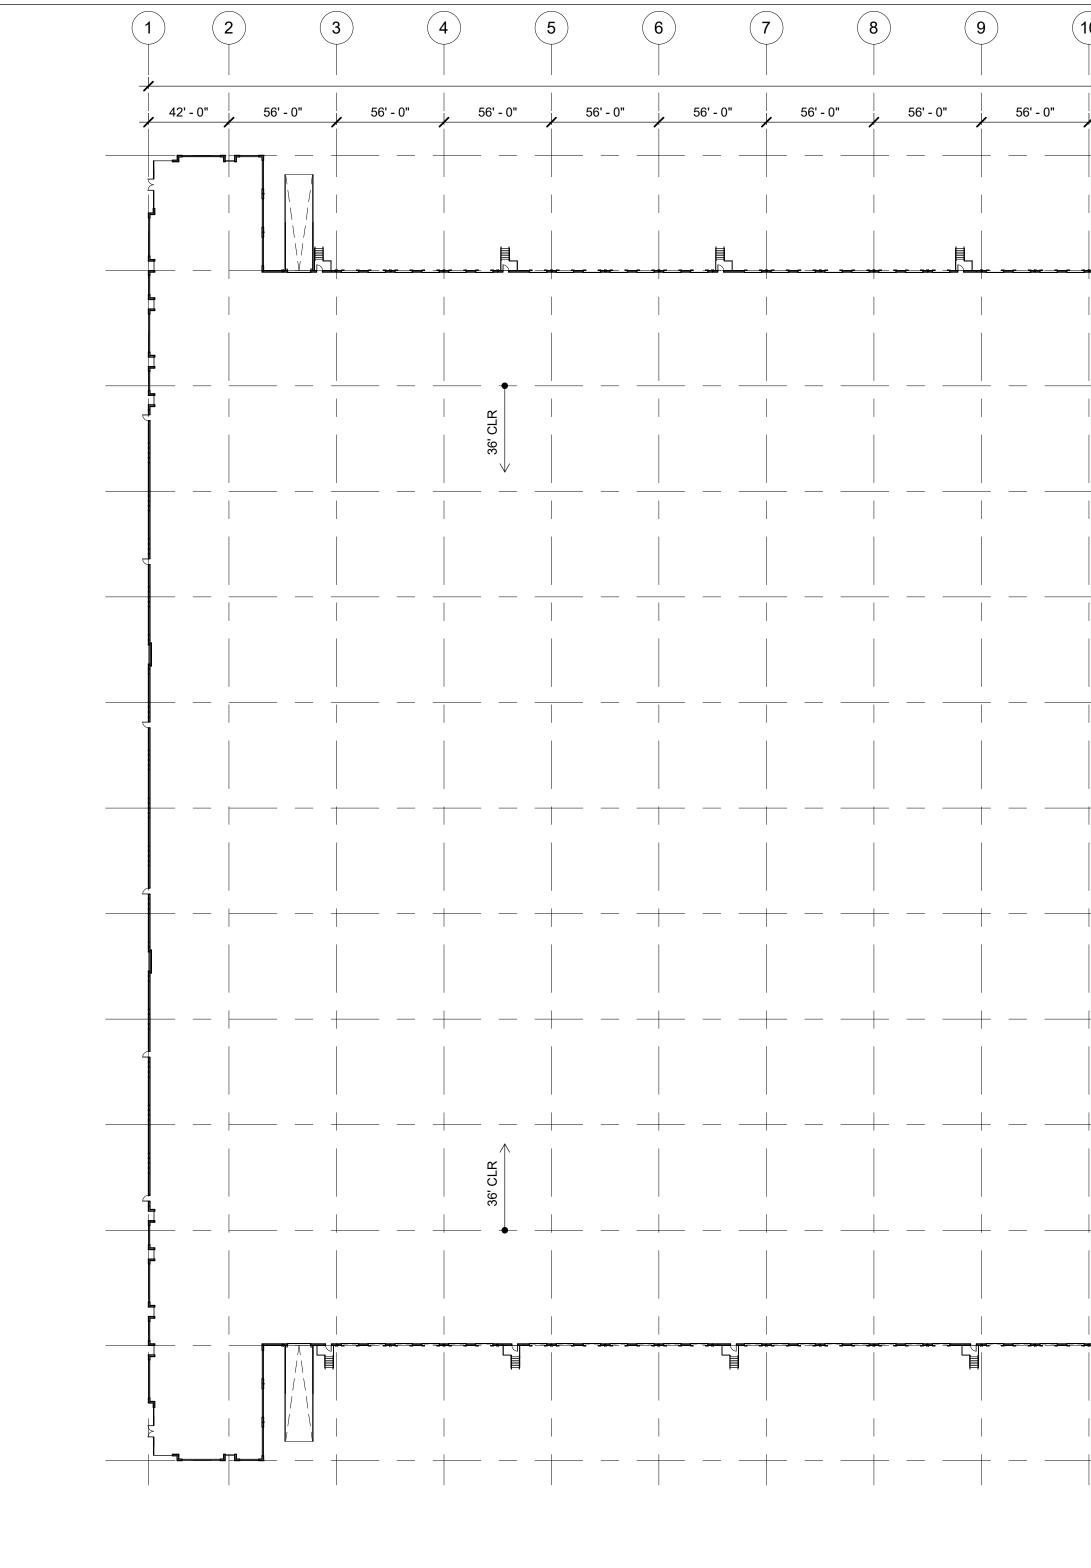


APPROXIMATE CENTERLINE OF EXISTING DRAINAGE DITCH _ _ `

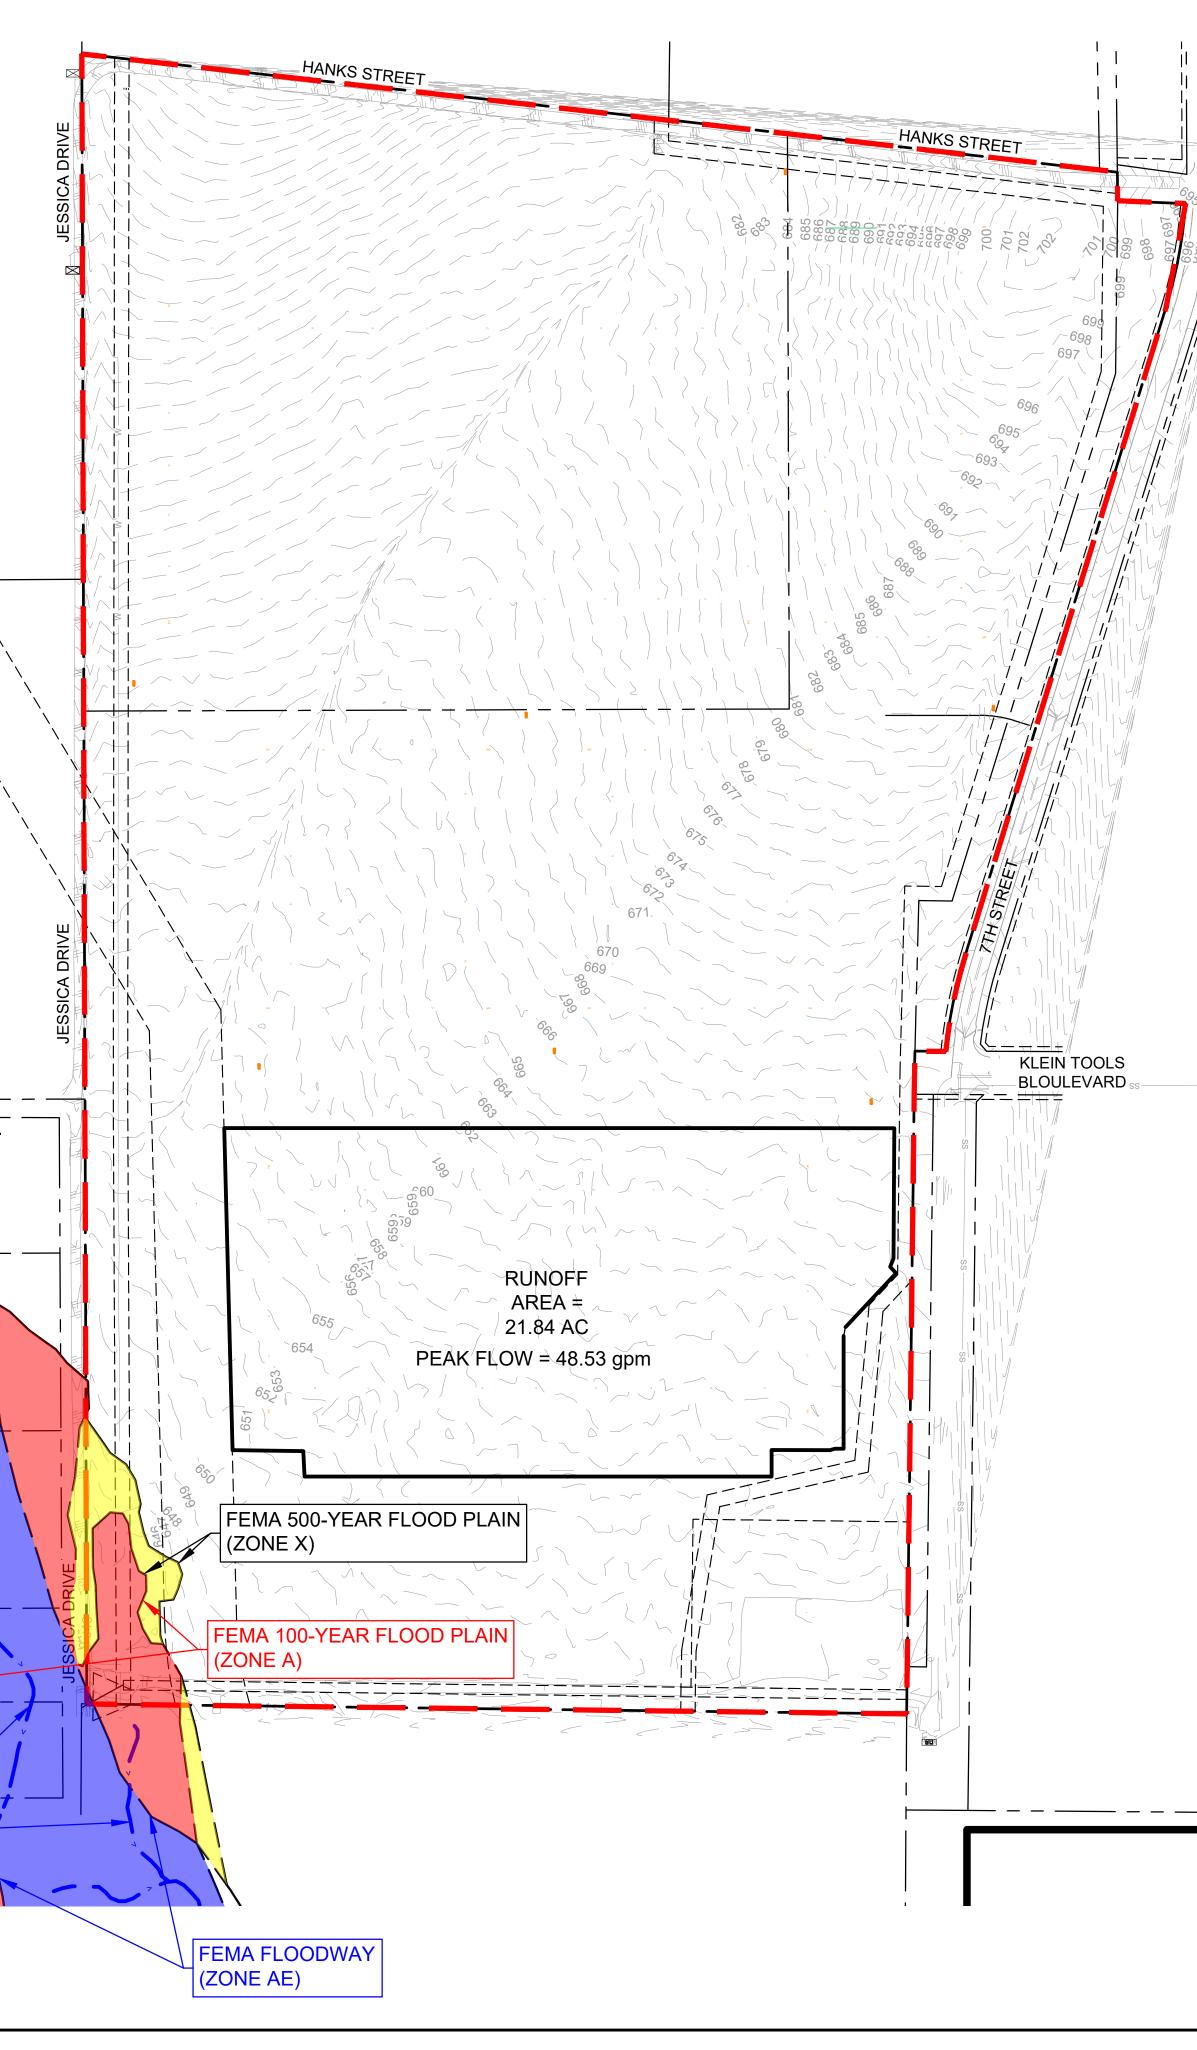



GR 0	RAPHIC SCALE IN FE	ET 400			
LEGEN	D)			
SITE BOUNDARY					
FEMA FLOODWAY					
100 - YEAR FEMA FLOOD PLAIN					
500 - YEAR FEMA FLOOD PLAIN					
APPROX. CENTERLINE OF EXISTING DRAINAGE DITCH					
			Kimlev»Horn	13455 NOEL ROAD, TWO GALLERIA OFFICE TOWER	PHONE: 972-770-1300 FAX: 972-239-3820



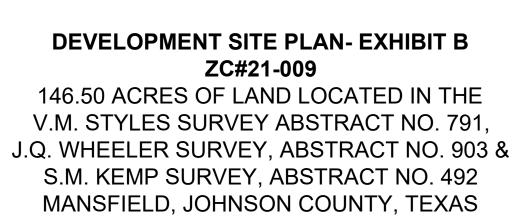



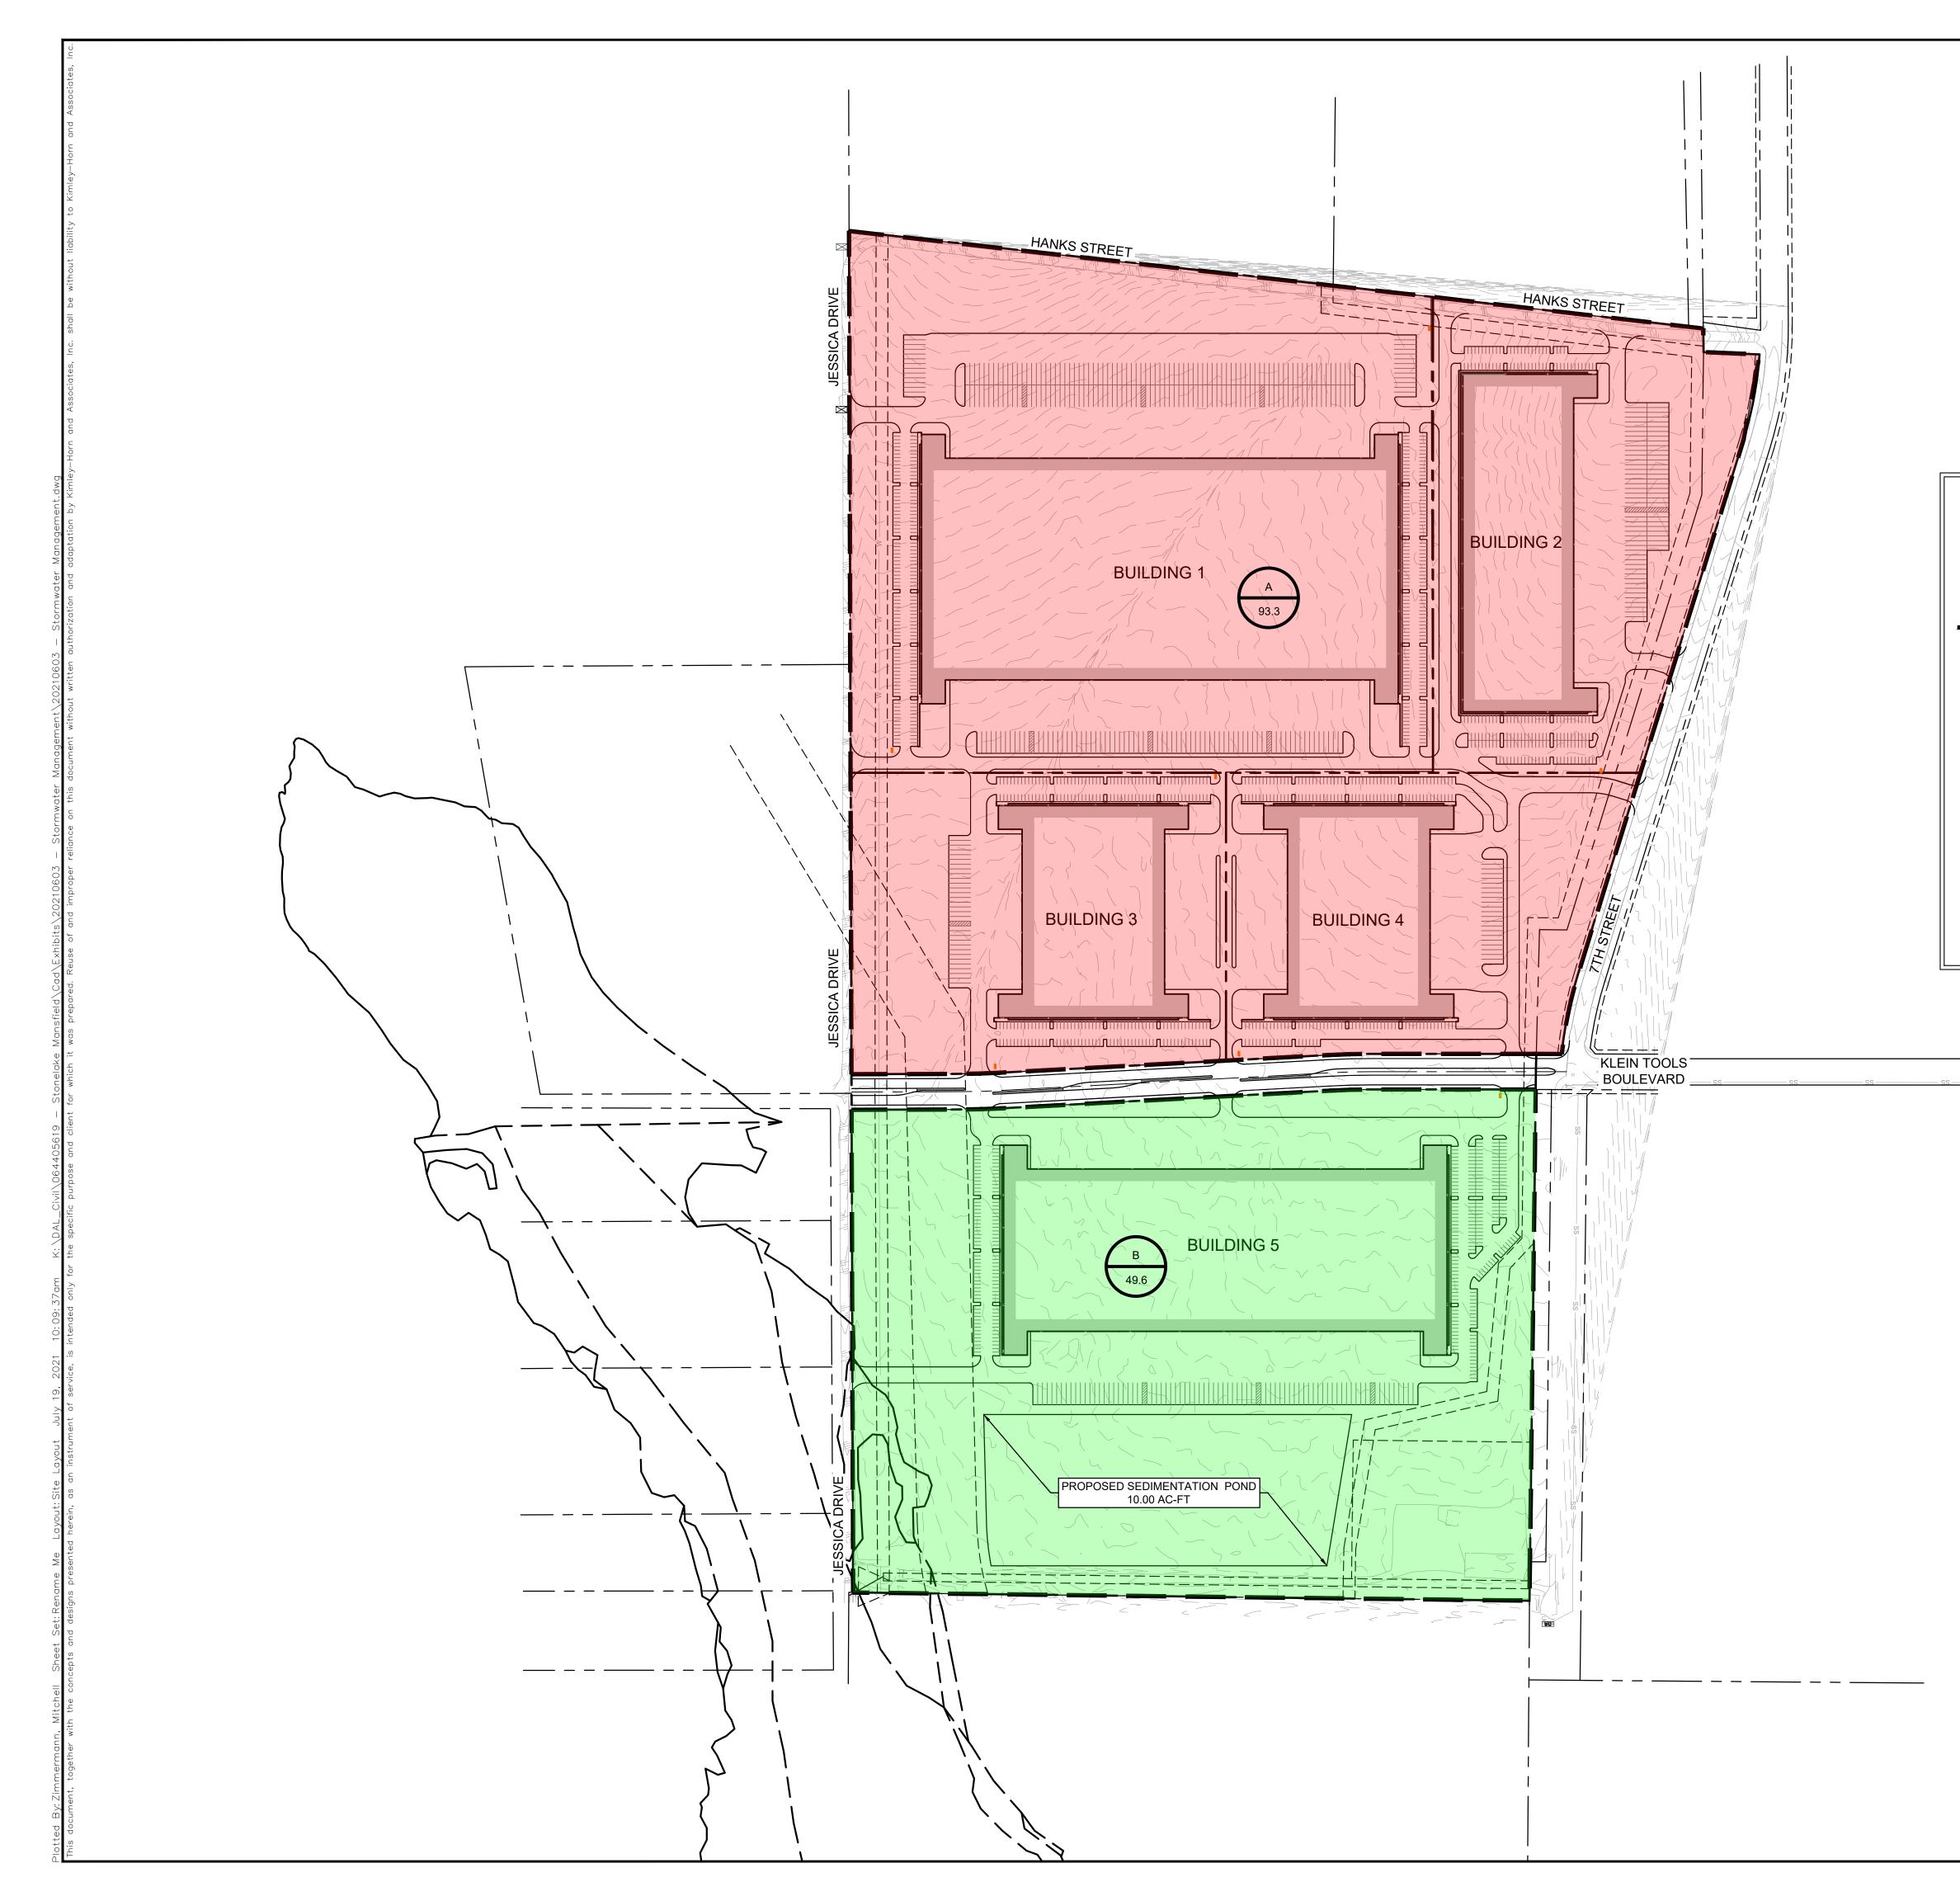

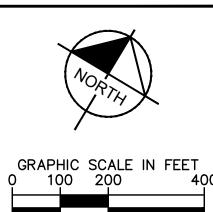

400


DRAINAGE KEY -DRAINAGE AREA DESIGNATION Α--AREA (ACRES) PROPOSED DRAINAGE AREA BOUNDARY WATER QUALITY ORIFICE CALCULATIONS R_v = VOLUMETRIC RUNOFF COEFFICIENT WQ_v = WATER QUALITY PROTECTION VOLUME (AC-FT)


A = TOTAL DRAINAGE AREA IN ACRES I = PERCENT IMPERVIOUS COVER Q_{WV}= WATER QUALITY PROTECTION VOLUME (INCHES)

A = 142.9 ACRES l = 62% R_∨ = 0.05 + 0.009 x I = 0.56 $WQ_v = (1.5 \times R_v \times A) / 12 = 10.00$ $Q_{WV} = 1.5 (R_v) = 0.84$

		NINIEY » TOTI		13455 NOEL KUAD, 1 WU GALLERIA OFFICE 10WER SUITE 700, DALLAS, TX 75240	PHONE: 972-770-1300 FAX: 972-239-3820 WWW.KIMLEY-HORN.COM TX F-928	© 2021 KIMLEY-HORN AND ASSOCIATES, INC.
	KHA PROJECT 064405619	DATE JUNE 2021	SCALE AS SHOWN	DESIGNED BY BJM	DRAWN BY MVZ	TEXAS CHECKED BY BJM
		DEVELOPMENT SITE		PLAN		MANSFIELD TEXAS
B HE 91,	PRELIMINARY	STORMWATER		MANAGEMENT		SHE FLAN
03 & 2 S 006		ZC#		JMBI)

DEVELOPMENT SITE PLAN- EXHIBIT B ZC#21-009 146.50 ACRES OF LAND LOCATED IN TH V.M. STYLES SURVEY ABSTRACT NO. 79 J.Q. WHEELER SURVEY, ABSTRACT NO. 90 S.M. KEMP SURVEY, ABSTRACT NO. 49 MANSFIELD, JOHNSON COUNTY, TEXAS PREPARED MARCH 26, 2021 & JULY 24, 20

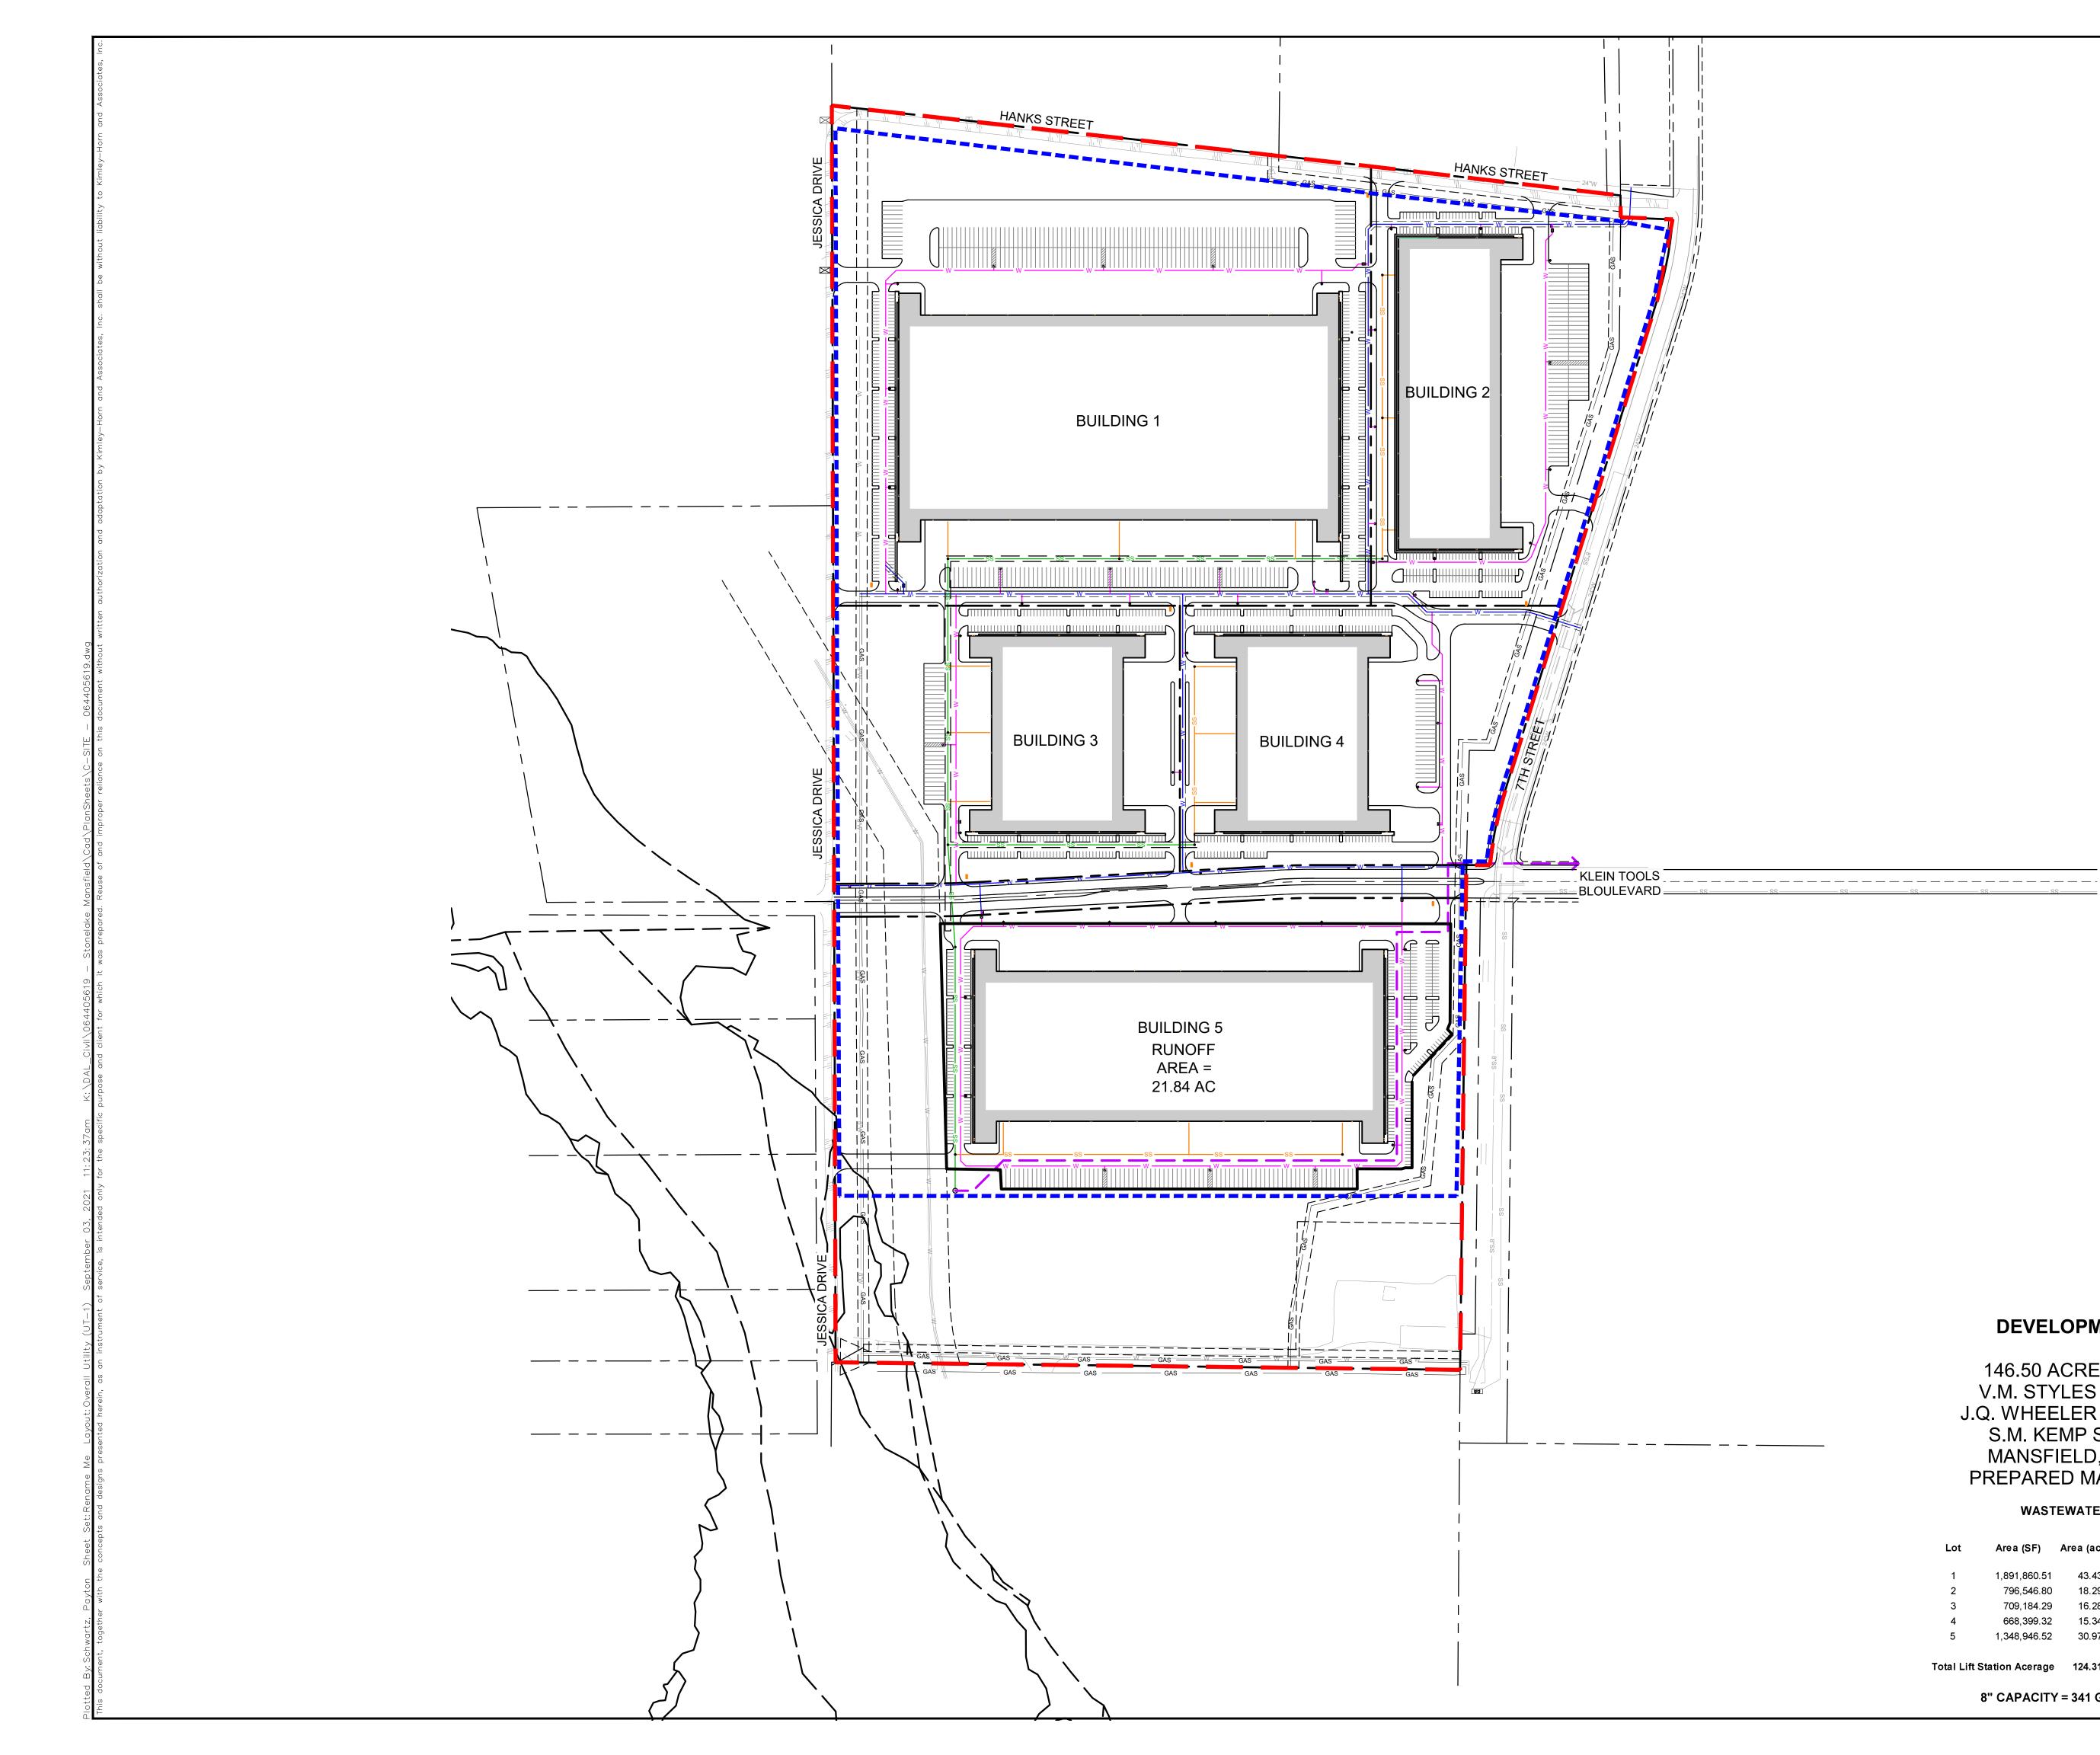

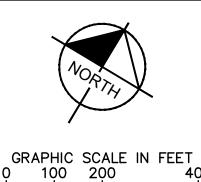

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SITE BOUNDARY	
SEWER BASIN BOUNDARY	
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PRIVATE WATER MAIN	
PUBLIC SANITARY MAIN	
PRIVATE SANITARY MAIN	
PRIVATE FORCE MAIN	


							DATE
							REVISIONS
							No.
				13455 NOEL ROAD. TWO GALLERIA OFFICE TOWER	SUITE 700, DALLAS, TX 75240	PHONE: 9/ 2-7/0-1300 FAX: 9/ 2-239-3820 WWW.KIMLEY-HORN.COM TX F-928	© 2021 KIMLEY-HORN AND ASSOCIATES, INC.
KHA PROJECT	064405619	DATE	AUGUSI ZUZI	SCALE AS SHOWN	DESIGNED BY BJM	DRAWN BY MVZ	CHECKED BY BJM
							MANSFIELD TEXAS
			<i>L</i>KELINIINAKY				
		ZC SHEI	ΕT		MBE	09 Er)


DEVELOPMENT SITE PLAN- EXHIBIT B ZC#21-009

146.50 ACRES OF LAND LOCATED IN THE V.M. STYLES SURVEY ABSTRACT NO. 791, J.Q. WHEELER SURVEY, ABSTRACT NO. 903 & S.M. KEMP SURVEY, ABSTRACT NO. 492 MANSFIELD, JOHNSON COUNTY, TEXAS PREPARED MARCH 26, 2021 & JULY 24, 2006

WASTEWATER FLOWS - MANSFIELD INDUSTRIAL

Lot	Area (SF)	Area (ac)	Design Factor (gal/ac)	Flow (gpd)	Flow (gpm)	Peak Flow (gpm)	Peak Flow (cfs)
1	1,891,860.51	43.43	800	34,744.91	24.13	96.51	0.22
2	796,546.80	18.29	800	14,628.96	10.16	40.64	0.09
3	709,184.29	16.28	800	13,024.50	9.04	36.18	0.08
4	668,399.32	15.34	800	12,275.47	8.52	34.10	0.08
5	1,348,946.52	30.97	800	24,774.04	17.20	68.82	0.15
Total Lift	Station Acerage	124.31		Total Life Sta	tion Flow	276.24	0.62
	8" CAPACITY	′ = 341 GP	М	8" (TY = 0.76 CI	=S

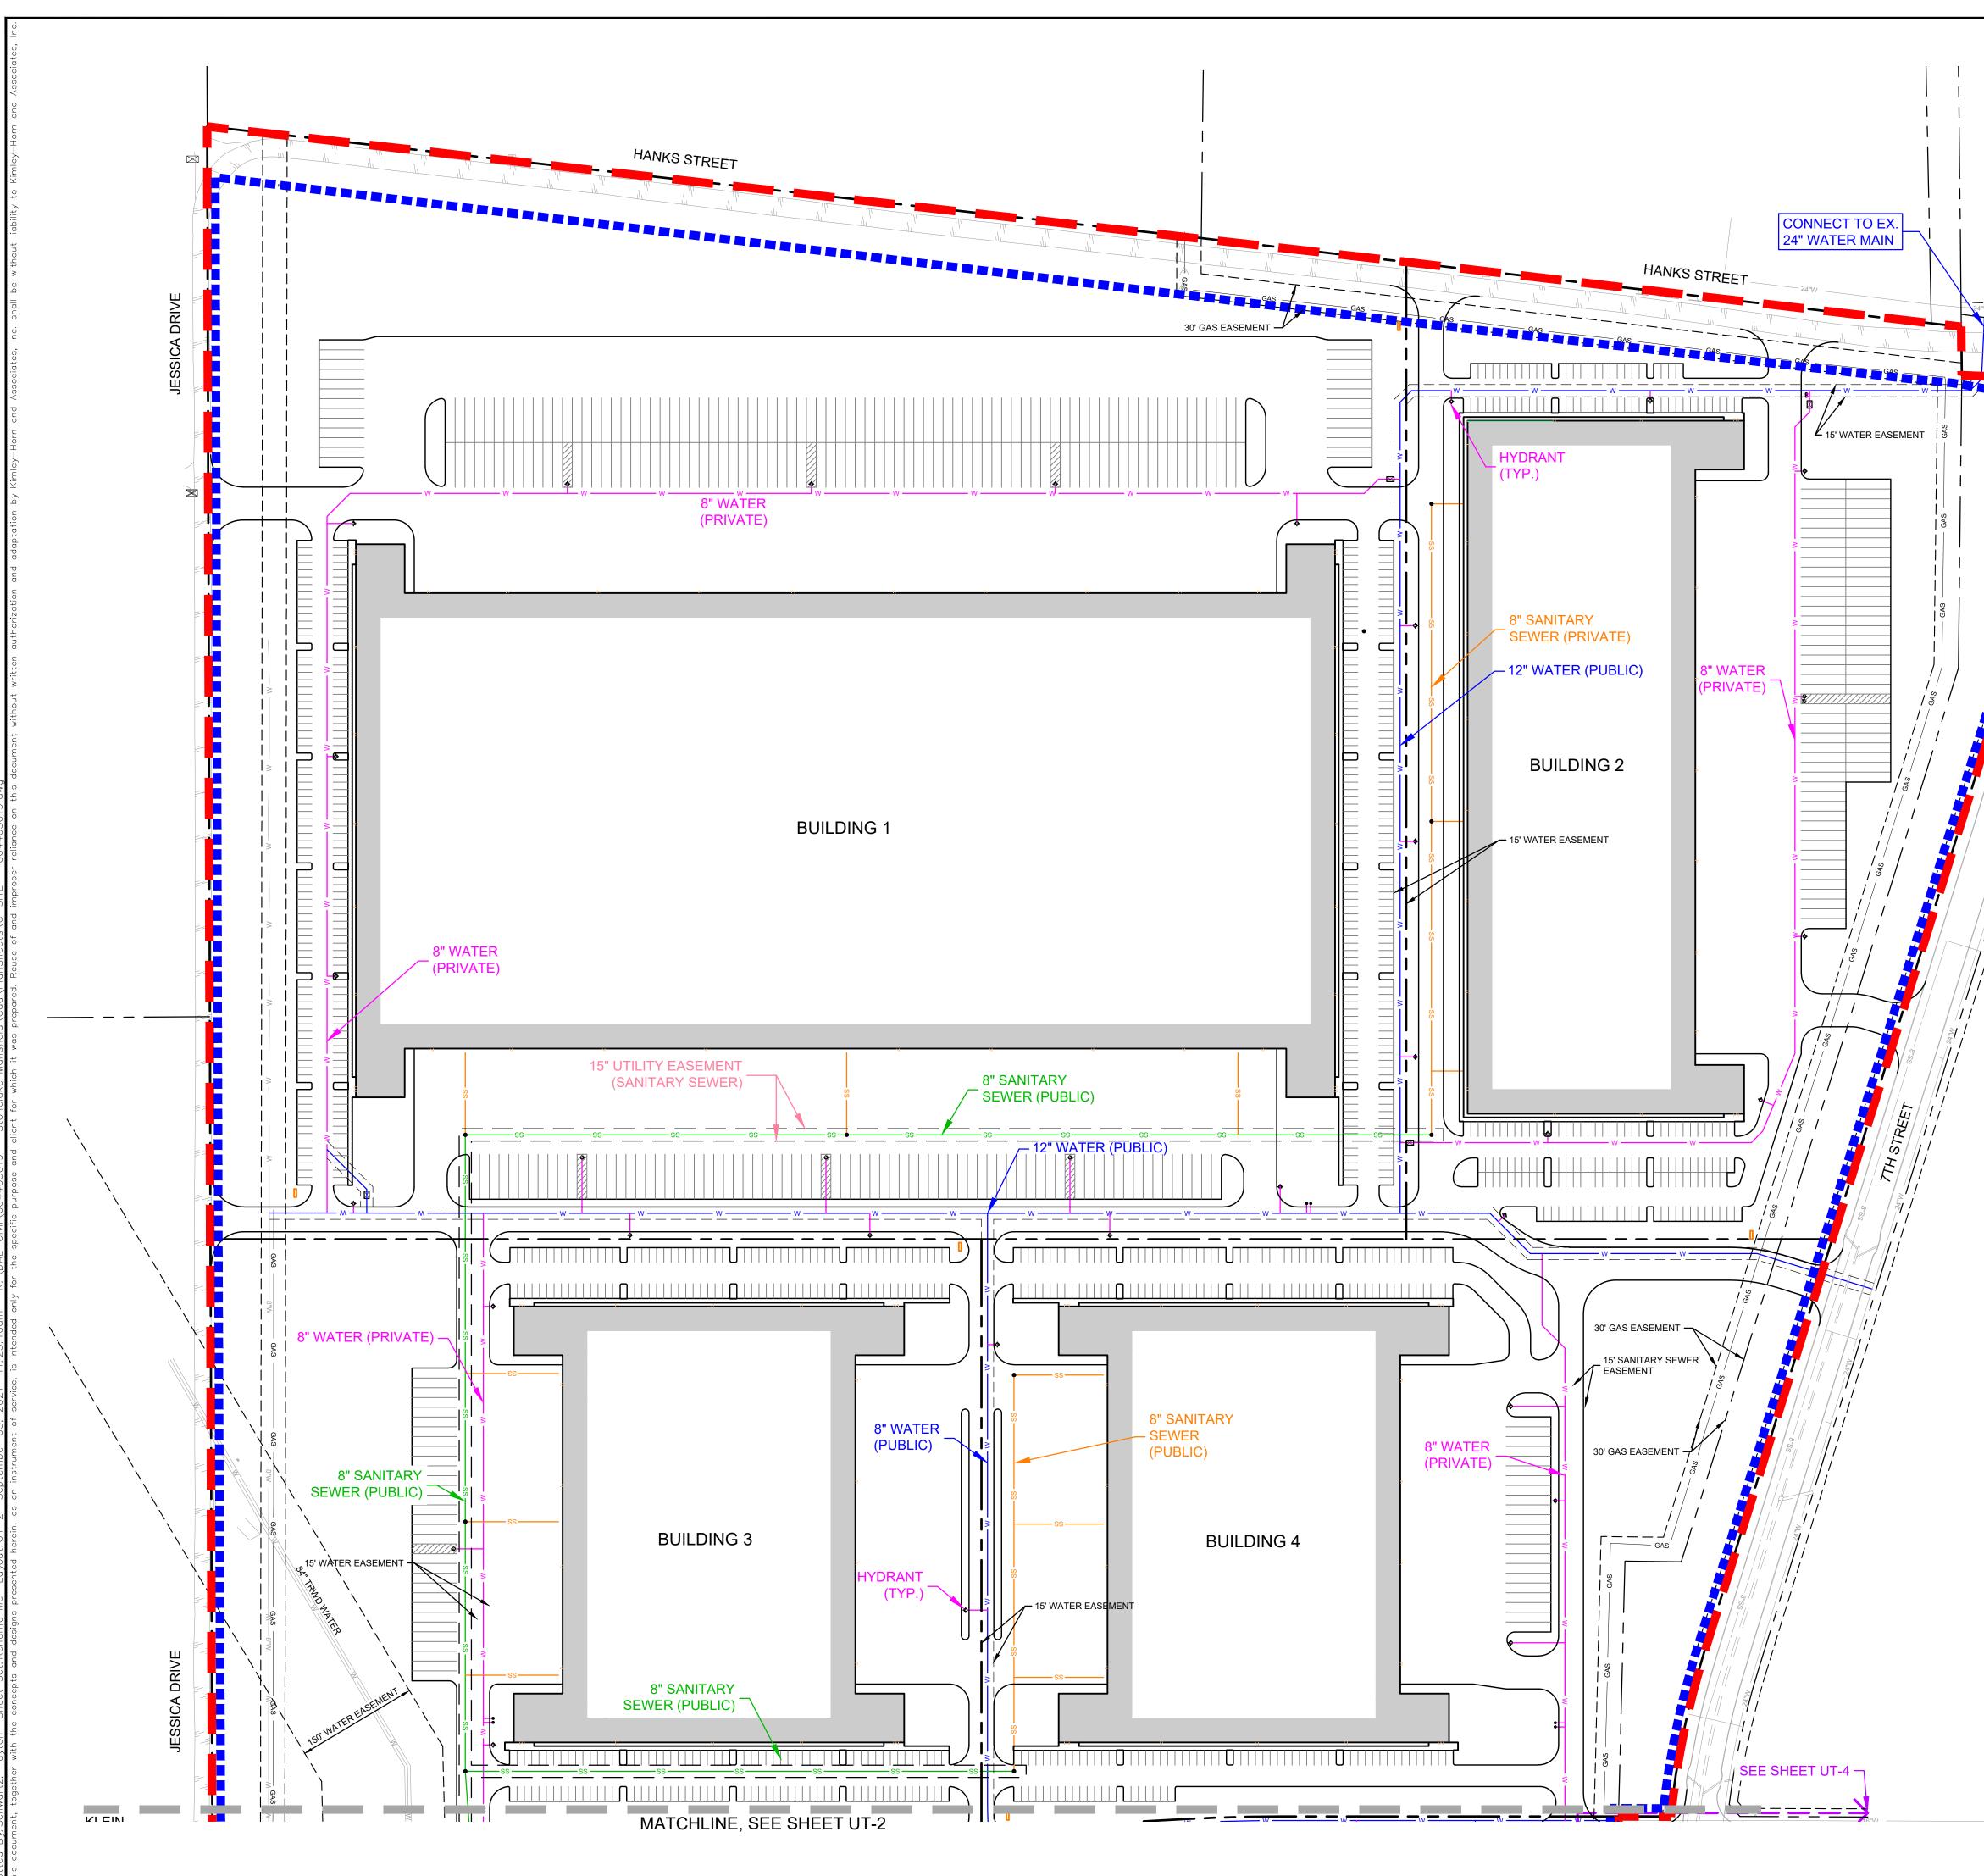

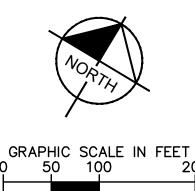

LEGEND							
SITE BOUNDARY							
SEWER BASIN BOUNDARY							
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PRIVATE WATER MAIN							
PUBLIC SANITARY MAIN							
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PRIVATE FORCE MAIN							


00								REVISIONS
					13455 NOEL ROAD. TWO GALLERIA OFFICE TOWER	SUITE 700, DALLAS, TX 75240	PHONE: 9/ 2-7 / 0-1300 FAX: 9/ 2-239-3820 WWW.KIMLEY-HORN.COM TX F-928	© 2021 KIMLEY-HORN AND ASSOCIATES, INC.
	KHA PROJECT	064405619			SCALE AS SHOWN	DESIGNED BY BJM	DRAWN BY MUZ	TEXAS CHECKED BY BJM
						L'AN		MANSFIELD
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			SHEI		NUI	MBE	09 Er)

DEVELOPMENT SITE PLAN- EXHIBIT B ZC#21-009

146.50 ACRES OF LAND LOCATED IN THE V.M. STYLES SURVEY ABSTRACT NO. 791, J.Q. WHEELER SURVEY, ABSTRACT NO. 903 & S.M. KEMP SURVEY, ABSTRACT NO. 492 MANSFIELD, JOHNSON COUNTY, TEXAS PREPARED MARCH 26, 2021 & JULY 24, 2006

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Total Lift Station Acerage		124.31		Total Life Sta	tion Flow	276.24	0.62
8" CAPACITY = 341 GPM				8" CAPACITY = 0.76 CFS			

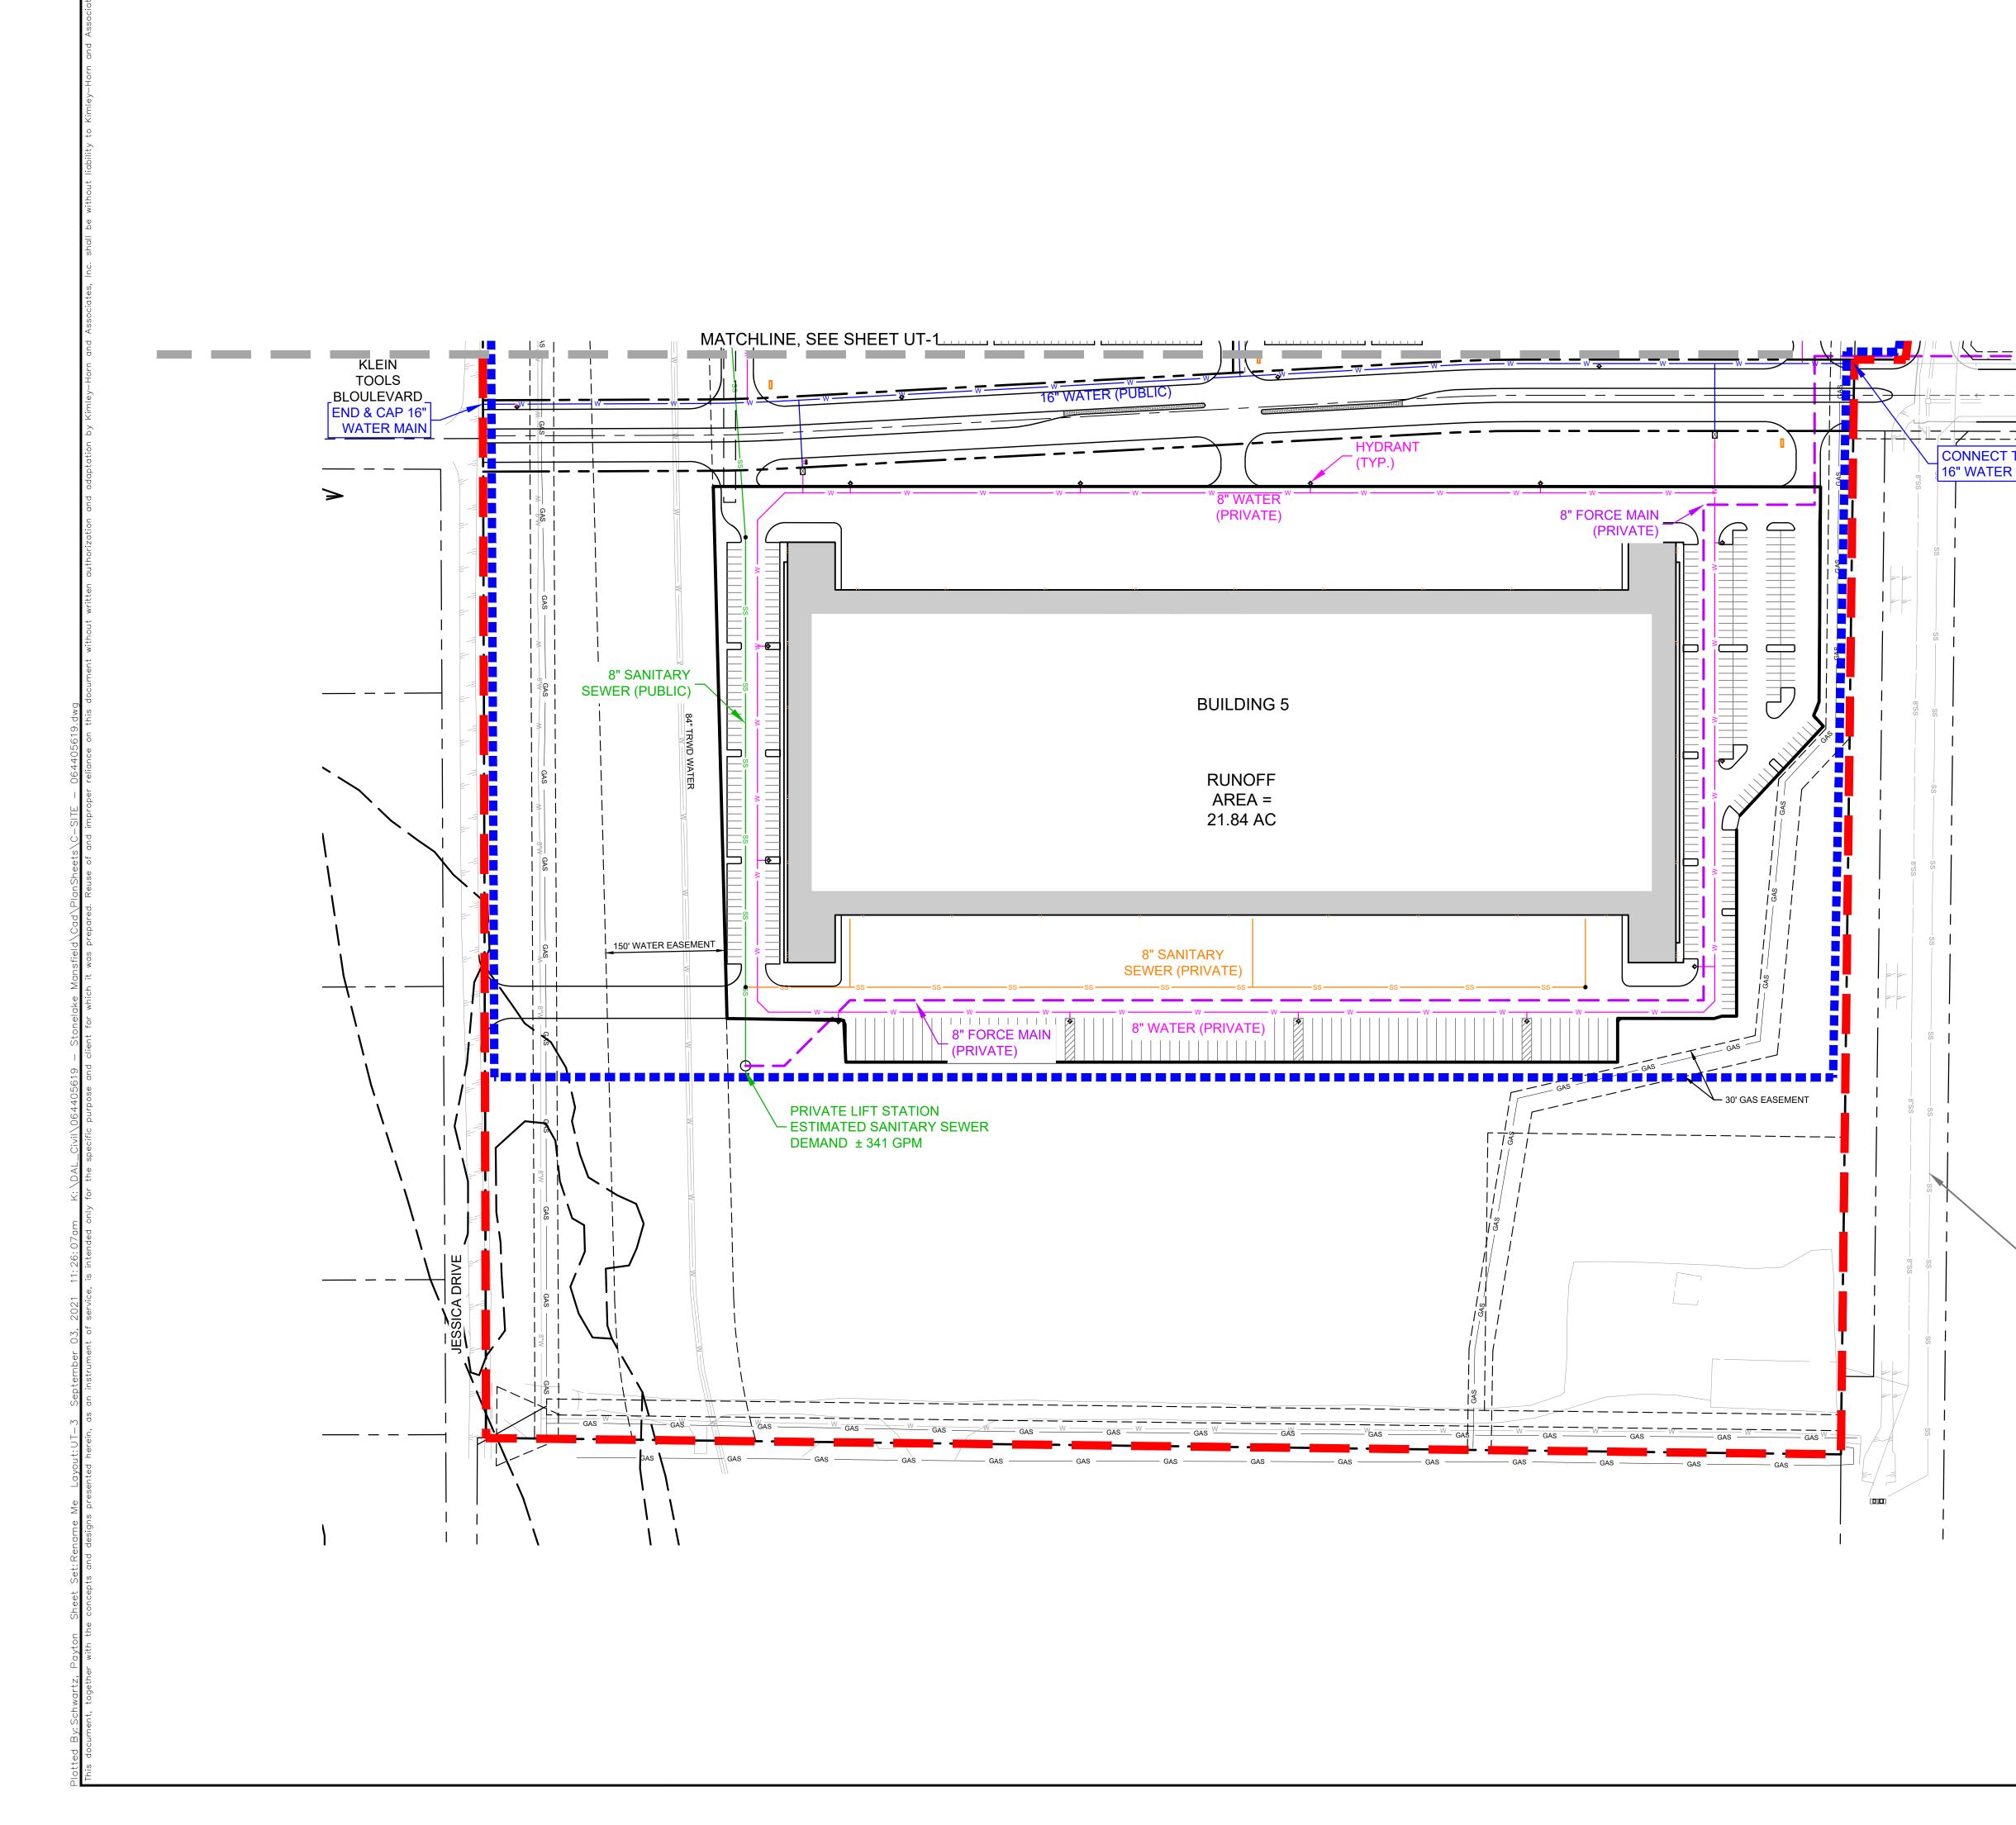

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	NORTH	DATE
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	LEGEND	EVISIONS
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	PRIVATE WATER MAIN w PUBLIC SANITARY MAIN ss	
N	PRIVATE SANITARY MAINSS	
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SSSS		TOWER 20 INC.
		TAFE NOEL ROAD, TWO GALLERIA OFFICE TOW SUITE 700, DALLAS, TX 75240 PHONE: 972-770-1300 FAX: 972-239-3820 WWW.KIMLEY-HORN.COM TX F-928 © 2021 KIMLEY-HORN AND ASSOCIATES, INC.
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		TWO GA 20, DALL 70-1300 EY-HORI HORN AN
		- ROAD, SUITE 70 SUITE 70 W.KIMLI MLEY-H
		65 NOEL WWW © 2021 K
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		PRO JATE JAS AS BY BY
		KHA PR(064405 DAT DAT AUGUST SCALE AS SCALE AS DESIGNED BY DRAWN BY CHECKED BY
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DEVELOPMENT S	SITE PLAN- EXHIBIT B	
ZC	#21-009 LAND LOCATED IN THE	
V.M. STYLES SURV	EY ABSTRACT NO. 791,	> → →
	YEY, ABSTRACT NO. 903 & EY, ABSTRACT NO. 492	A A
	NSON COUNTY, TEXAS	₹d
S.M. KEMP SURVE MANSFIELD, JOHN	26 2021 $R II II V 21 2000$	
S.M. KEMP SURVE MANSFIELD, JOHN PREPARED MARCH	26, 2021 & JULY 24, 2006 - mansfield industrial	Ī₹≽
S.M. KEMP SURVE MANSFIELD, JOHN PREPARED MARCH WASTEWATER FLOWS Lot Area (SF) Area (ac) Factor	- MANSFIELD INDUSTRIAL Flow Peak Flow Peak Flow Flow (gpd) (gpm) (cfs)	
S.M. KEMP SURVE MANSFIELD, JOHN PREPARED MARCH WASTEWATER FLOWS Lot Area (SF) Area (ac) Factor (gal/ac) 1 1,891,860.51 43.43 800	G - MANSFIELD INDUSTRIAL Flow (gpd) Flow Peak Flow Peak Flow (gpm) (gpm) (cfs) 34,744.91 24.13 96.51 0.22	'RELIMI JTILITY
S.M. KEMP SURVE MANSFIELD, JOHN PREPARED MARCH WASTEWATER FLOWS Lot Area (SF) Area (ac) Factor (gal/ac)	Flow Peak Flow Peak Flow Flow (gpd) (gpm) (gpm) (cfs)	PRELIMINARY UTILITY PLAN
S.M. KEMP SURVE MANSFIELD, JOHN PREPARED MARCH WASTEWATER FLOWS Lot Area (SF) Area (ac) Design Factor (gal/ac) 1 1,891,860.51 43.43 800 2 796,546.80 18.29 800 3 709,184.29 16.28 800 4 668,399.32 15.34 800 5 1,348,946.52 30.97 800	Flow (gpd) Flow (gpm) (gpm) Peak Flow (gpm) (gpm) Peak Flow (gpm) (cfs) 34,744.91 24.13 96.51 0.22 14,628.96 10.16 40.64 0.09 13,024.50 9.04 36.18 0.08 12,275.47 8.52 34.10 0.08 24,774.04 17.20 68.82 0.15	
S.M. KEMP SURVE MANSFIELD, JOHN PREPARED MARCH WASTEWATER FLOWS Design Lot Area (SF) Area (ac) Design 1 1,891,860.51 43.43 800 2 796,546.80 18.29 800 3 709,184.29 16.28 800 4 668,399.32 15.34 800	Flow (gpd) Flow (gpm) (gpm) Peak Flow (gpm) (cfs) 34,744.91 24.13 96.51 0.22 14,628.96 10.16 40.64 0.09 13,024.50 9.04 36.18 0.08 12,275.47 8.52 34.10 0.08	ZC#21-009 SHEET NUMBER UT-3

